




TYPICAL FRONTYARD PLANTING - PLAN 1 1"=10"



TYPICAL FRONTYARD PLANTING - PLAN 2 1"=10"

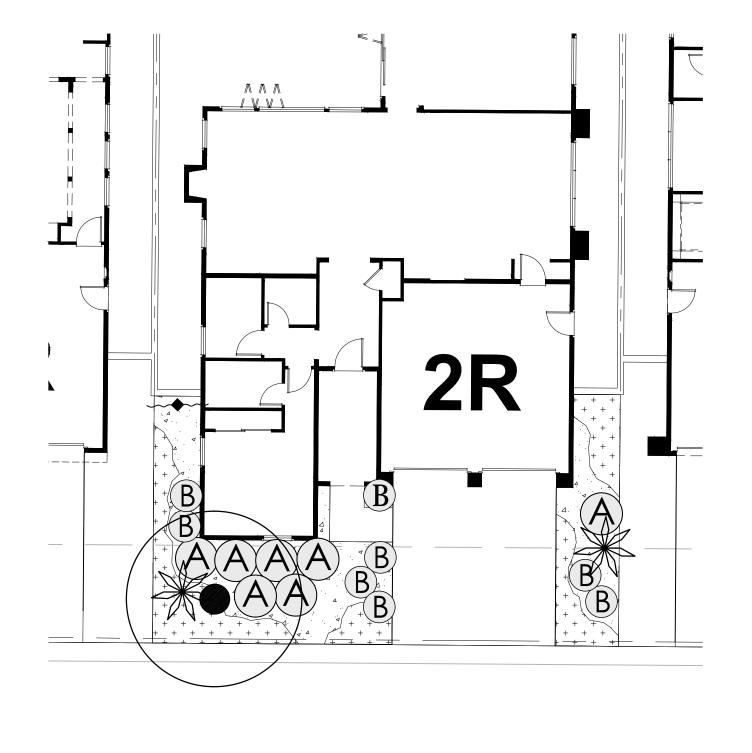

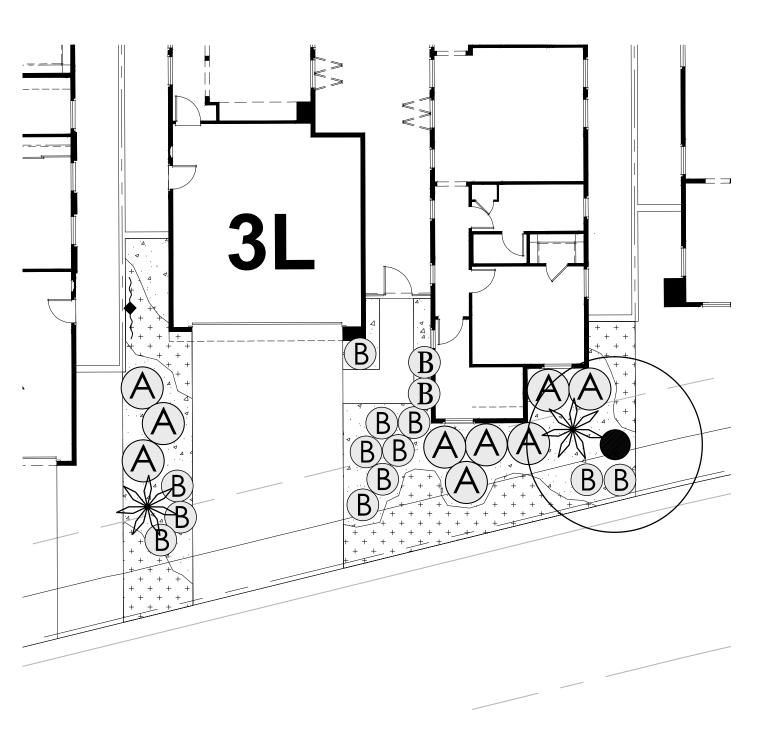

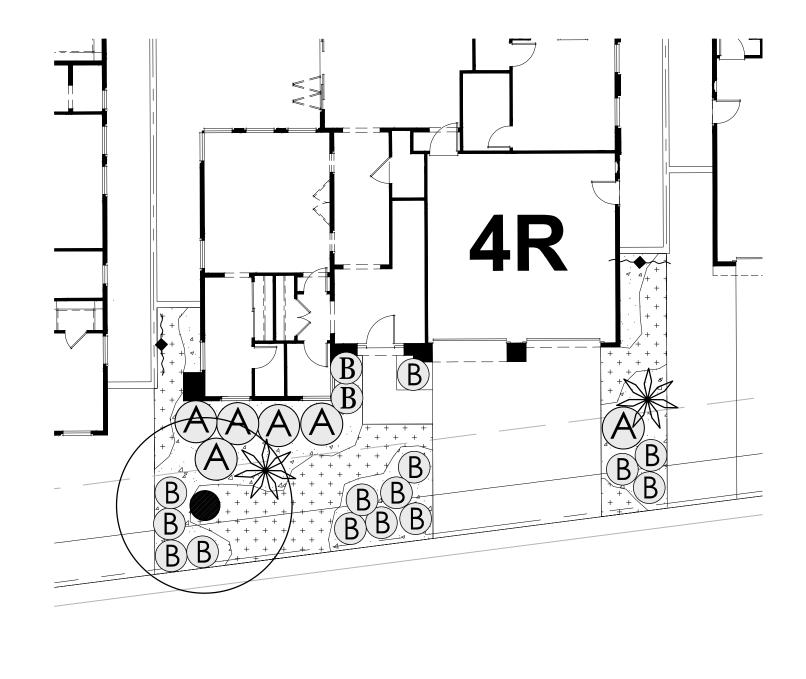

TYPICAL FRONTYARD PLANTING - PLAN 4 1"=10"

CONCEPTUAL PLANT LEGEND

		BOTANICAL NAME	COMMON NAME	MIN. SIZE	<u>SPACING</u>	PLANT
	OPEN S	PACE TREES				FACTOR
		CERCIDIUM "DESERT MUSEUM" OLEA EUROPAEA "WILSONII" SCHINUS MOLLE	PALO VERDE FRUITLESS OLIVE CALIFORNIA PEPPER	24" BOX 24" BOX 24" BOX	AS SHOWN AS SHOWN AS SHOWN	LOW LOW LOW
	INTERIO	R STREET TREES				
		ACACIA STENOPHYLLA RHUS LANCEA	SHOESTRING ACACIA AFRICAN SUMAC	24" BOX 24" BOX	as shown as shown	LOW LOW
	<u>ACCEN</u>	<u>TS</u>				
		AGAVE AMERICANA AGAVE GEMINIFLORA DASYLIRION WHEELERI HESPERALOE PARVIFLORA OPUNTIA V. "SANTA RITA"	CENTURY PLANT TWIN-FLOWERED AGAVE DESERT SPOON RED YUCCA PURPLE OPUNTIA	5 GALLON 5 GALLON 5 GALLON 5 GALLON 5 GALLON	AS SHOWN AS SHOWN AS SHOWN AS SHOWN AS SHOWN	LOW LOW LOW LOW
	LARGE /	MEDIUM SHRUBS				
A		BOUGAINVILLEA "LA JOLLA" CALLIANDRA CALIFORNICA CAESALPINIA PULCHERRIMA LEUCOPHYLLUM LAEVIGATUM RUELLIA PENINSULARIS	BOUGAINVILLEA BAJA FAIRY DUSTER RED BIRD OF PARADISE CHIHUAHUAN SAGE DESERT RUELLIA	5 GALLON 5 GALLON 5 GALLON 5 GALLON 5 GALLON	AS SHOWN AS SHOWN AS SHOWN AS SHOWN AS SHOWN	LOW LOW LOW LOW
	SMALL /	' MEDIUM SHRUBS				
B		ENCELIA FARINOSA LANTANA C. "RADIATION" MUHLENBERGIA "REGAL MIST" ROSMARINUS "TUSCAN" ROSA "ICEBERG"	BRITTLE BUSH LANTANA PINK MUHLY GRASS UPRIGHT ROSEMARY ICEBERG ROSE	5 GALLON 5 GALLON 5 GALLON 5 GALLON 5 GALLON	AS SHOWN AS SHOWN AS SHOWN AS SHOWN AS SHOWN	LOW LOW LOW LOW MEDIUM
	GROUN	NDCOVERS_				
	+ + + + + + + + + + + + + + +	ACACIA R. "DESERT CARPET" BAILEYA MULTIRADIATA BULBINE FRUTESCENS "HALLMARK" CARISSA G. "GREEN CARPET" LANTANA MONTEVIDENSIS LANTANA M. "NEW GOLD" ROSA "FLOWER CARPET RED" ROSMARINUS O. 'PROSTRATUS'	TRAILING ACACIA DESERT MARIGOLD BULBINE NATAL PLUM SPREADING LANTANA SPREADING LANTANA GROUNDCOVER ROSE PROSTRATE ROSEMARY	1 GALLON	24" O.C. 24" O.C. 24" O.C. 24" O.C. 24" O.C. 24" O.C. 24" O.C. 24" O.C.	LOW LOW LOW LOW LOW MEDIUM
	<u>VINES</u>					
~ .		MACFADYENA UNGUIS-CATI ROSA BANKSIAE	CAT'S CLAW VINE LADY BANK'S ROSE	5 GALLON 5 GALLON	as shown as shown	LOW MEDIUM
	<u>TURF</u>					


DECOMPOSED GRANITE - "APACHE BROWN" - 1/4" MINUS - 2" DEEP LAYER


- 1) PERMANENT AUTOMATIC IRRIGATION SYSTEMS SHALL BE INSTALLED ON ALL LANDSCAPED AREAS REQUIRING IRRIGATION. WALKWAYS, PARKING AREAS, BUILDINGS AND FENCES.
- 2) ALL TREES SHALL BE MINIMUM DOUBLE-STAKED. WEAKER AND/OR SLOW-GROWING TREES SHALL BE STEEL-STAKED.
- 3) SLOPE BANKS FIVE FEET OR GREATER IN VERTICAL HEIGHT WITH SLOPES GREATER THAN OR EQUAL TO 3:1 TO BE LANDSCAPED AT A MINIMUM WITH AN APPROPRIATE GROUND COVER, ONE 15-GALLON OR LARGER SIZE TREE PER 600 SQUARE FEET OF SLOPE AREA, AND ONE 1-GALLON OR LARGER SHRUB FOR EACH 100 SQUARE FEET OF SLOPE AREA. SLOPE BANKS IN EXCESS OF EIGHT FEET IN VERTICAL HEIGHT WITH SLOPES GREATER OR EQUAL TO 2:1 SHALL ALSO BE PROVIDED WITH ONE 5-GALLON OR LARGER TREE PER 1,000 SQUARE FEET OF SLOPE AREA IN ADDITION TO THE ABOVE REQUIREMENTS.
- 4) ALL LANDSCAPE AREAS SHALL RECEIVE 2" DECOMPOSED GRANITE
- 5) ALL UTILITIES SHALL BE SCREENED WITH APPROPRIATE PLANT MATERIAL
- 6) ALL PARKWAYS, LANDSCAPING, FENCING AND ON-SITE LIGHTING SHALL BE MAINTAINED BY THE PROPERTY OWNER.
- 7) ALL IRRIGATED AREAS TO HAVE MOISTURE SENSORS INSTALLED TO ENSURE PLANT MATERIAL SURVIVAL.

``C<FI6G`%; 5@©CB`fD@5BH98`89BQ9@MHC`57<=JJ9`%\$\$`D9F79BH7CJ9F5; 9`-B`CB9`M95FŁ"

- 8) A COMBINATION OF TREES, SHRUBS, AND GROUND COVER SHALL BE INCORPORATED INTO LANDSCAPING PLANS. MINIMUM SIZES ARE AS FOLLOWS: "HF99G '&(!B7<'6CL'fl%); 5 @@CB'CF95779DH56@9:CF'C@CD9CL" ~C<FI 6G)!; 5@€C Bž5B8
- 9) DRIP SYSTEMS SHOULD BE USED IN ALL AREAS EXCEPT TURF IRRIGATION.
- 10) NATIVE AND DROUGHT TOLERANT PLANTS WILL BE INCORPORATED WHEREVER POSSIBLE.
- 11) THE APPLICANT INSURES THAT MATURE PLANTINGS WILL NOT INTERFERE WITH UTILITIES, ADJACENT SITE, EXISTING STRUCTURES AND TRAFFIC SIGHT LINES.

SHEET 2 OF 3 TYPICAL PLANTING PLAN

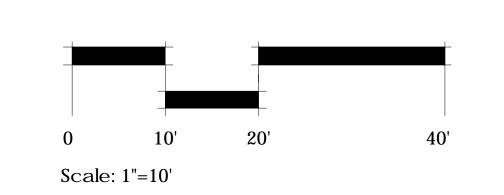

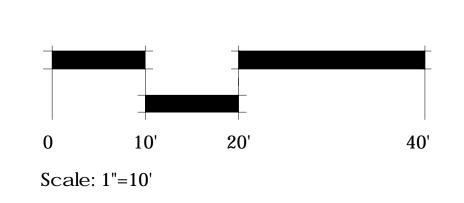




LANDSCAPE MASTER PLAN FOR:


PHASE 6 ESCENA

PALM SPRINGS CLASSIC TRACT NO. 32233

CITY OF PALM SPRINGS

03.20.14

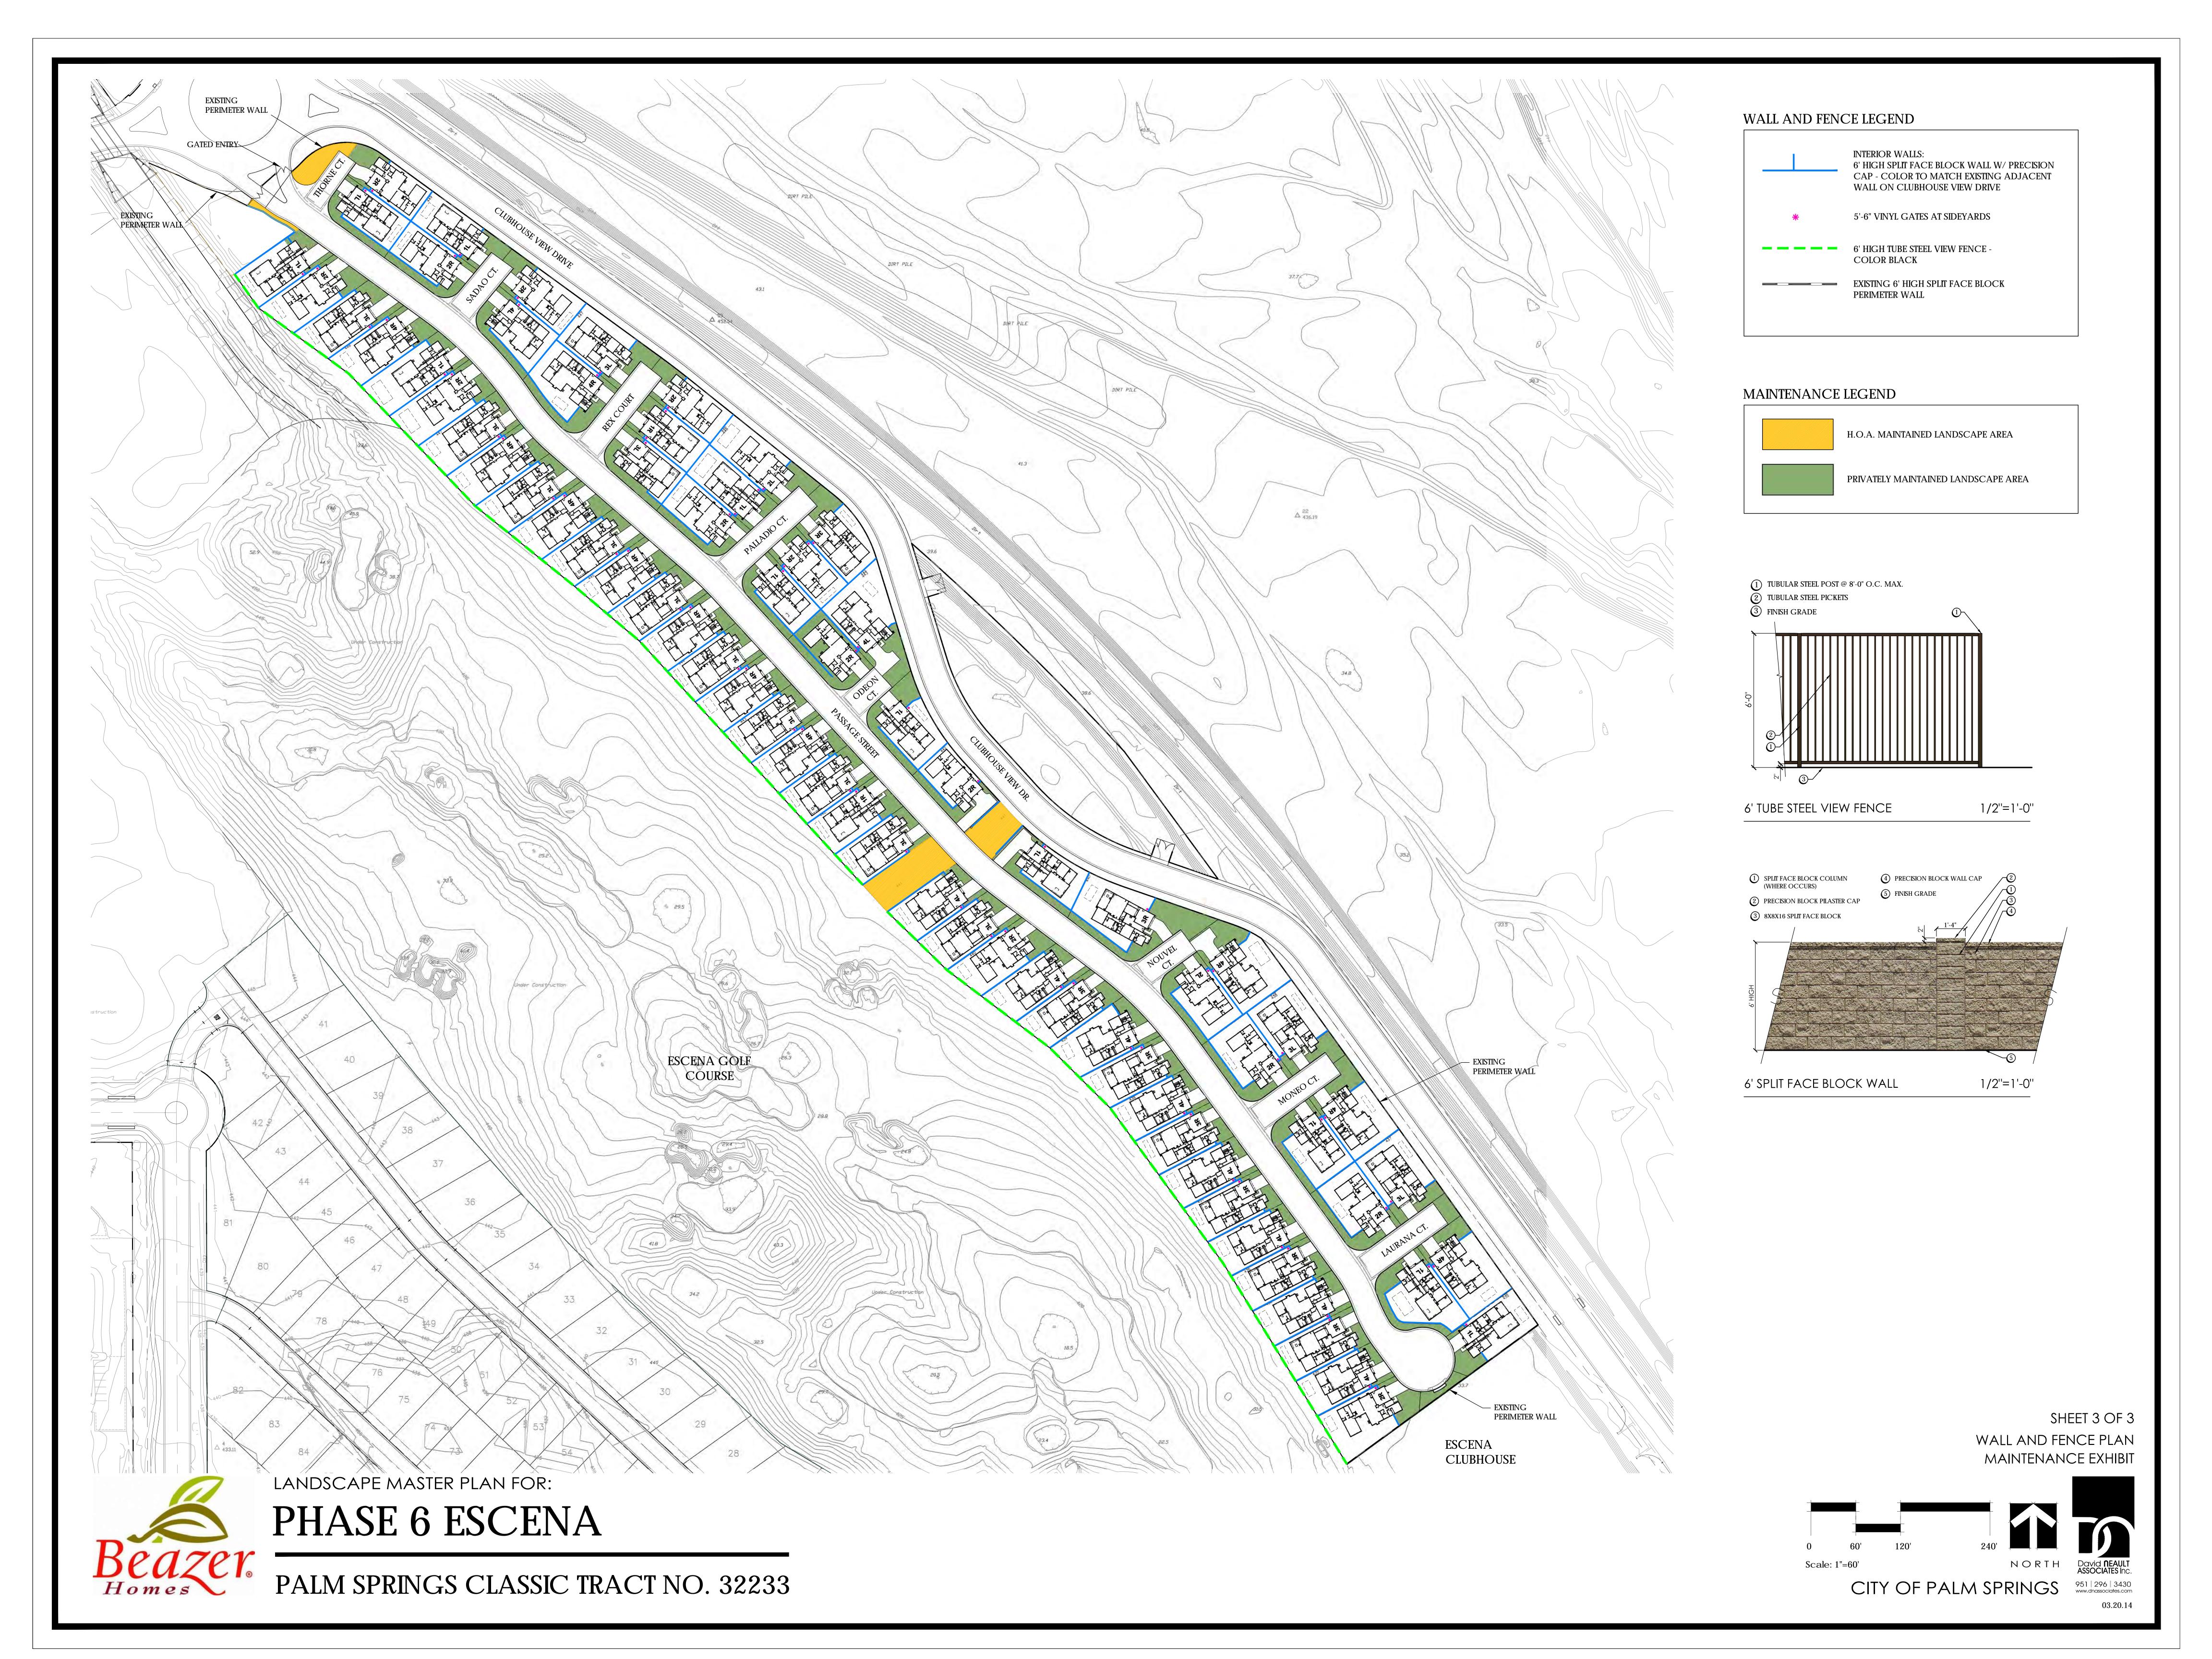

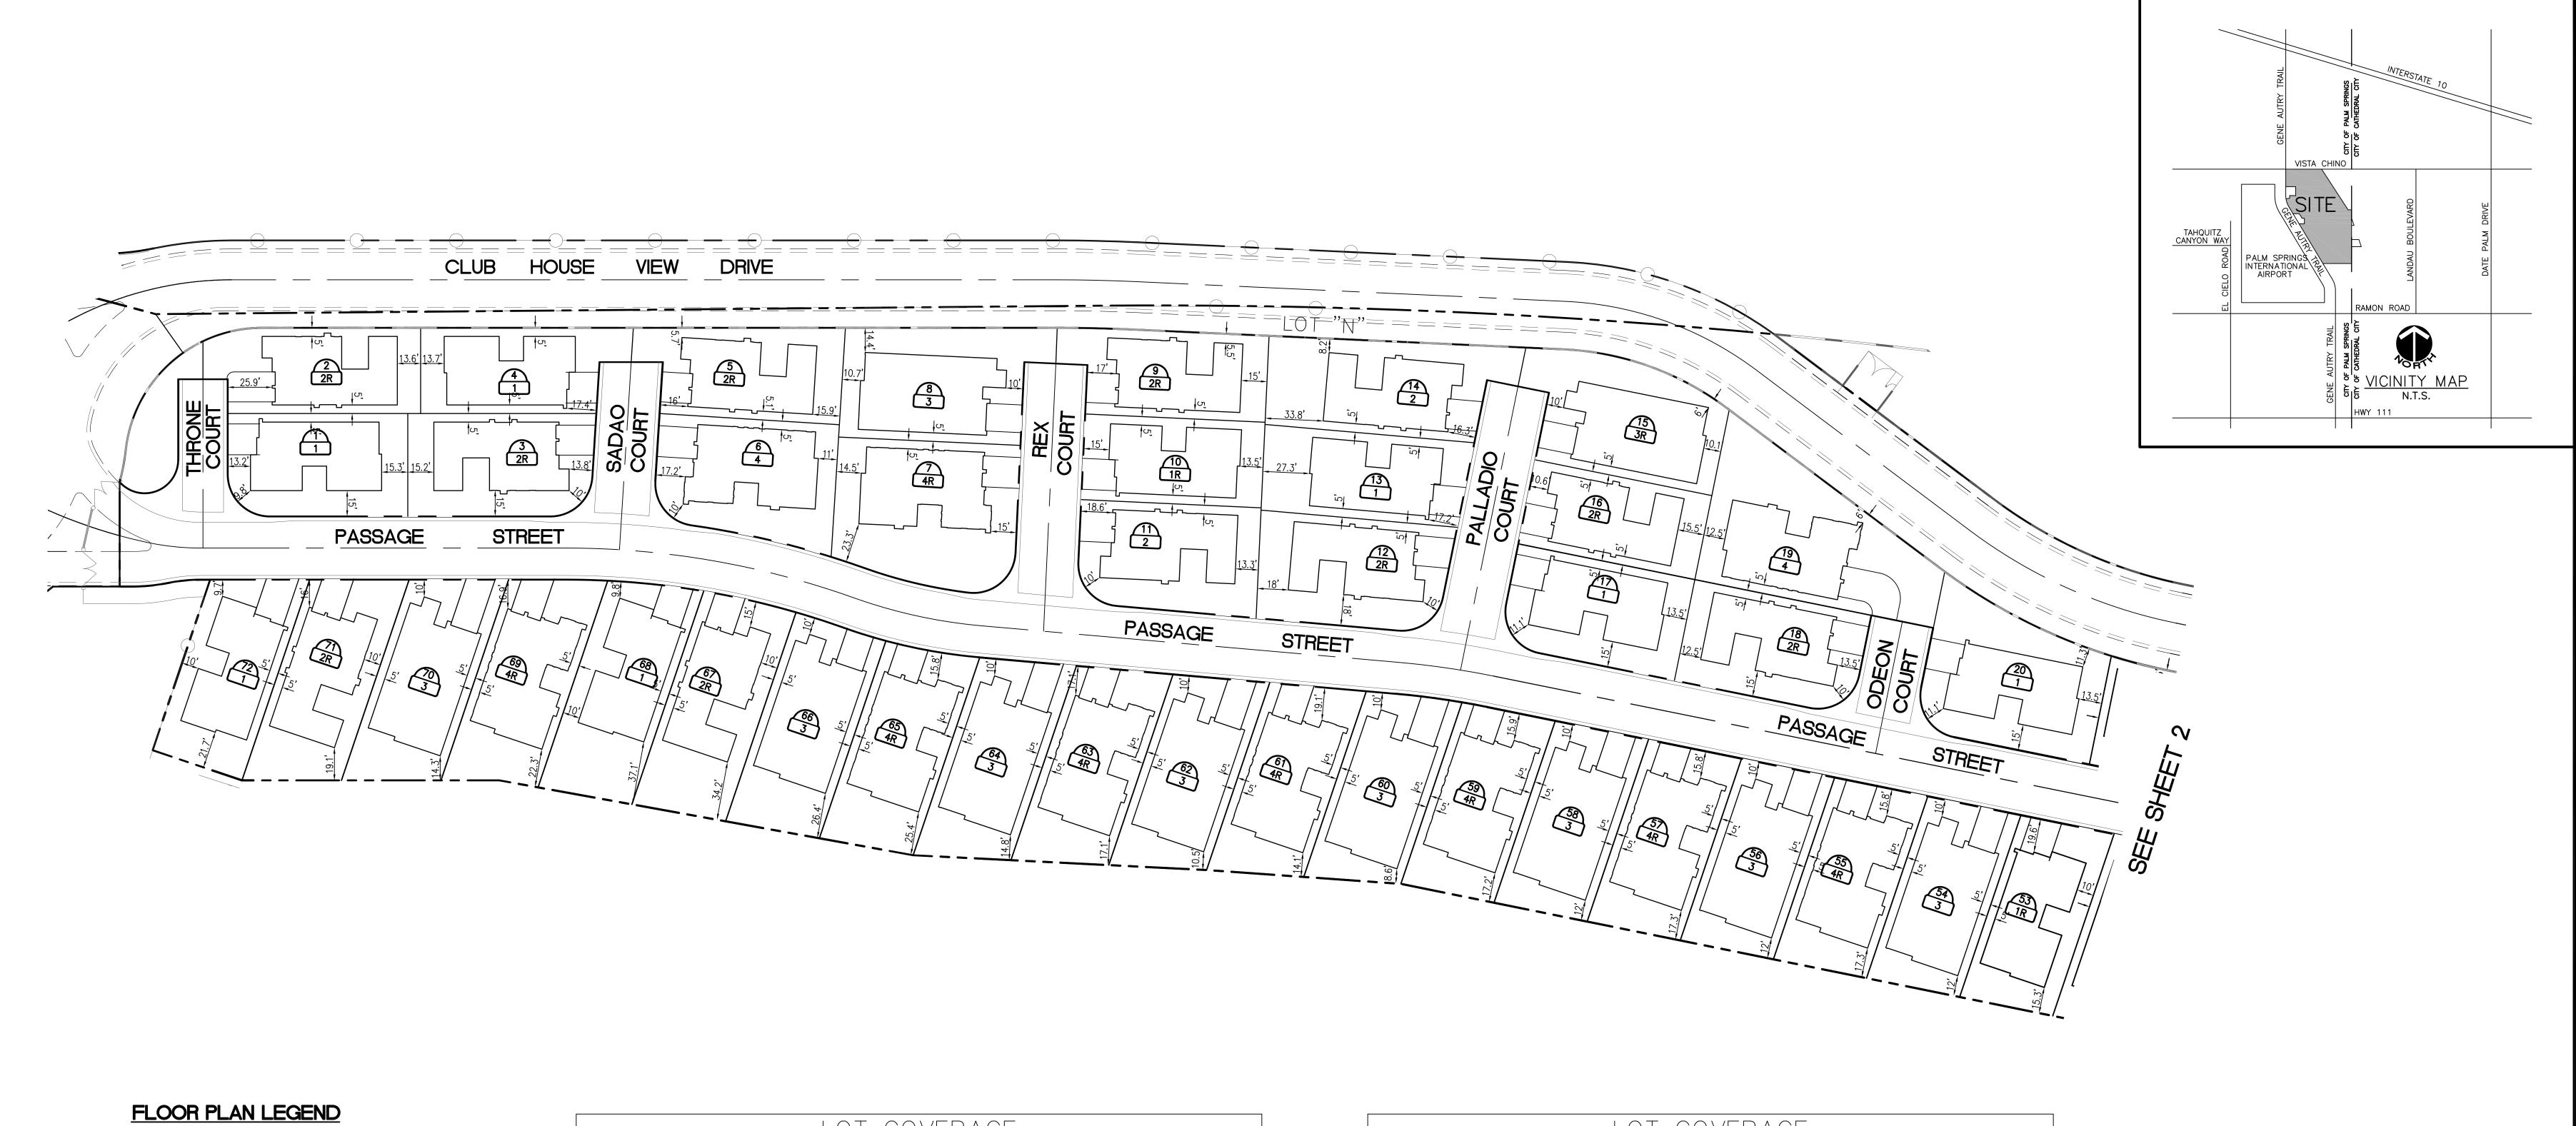




PLAN-1








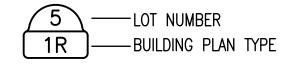


LOT COVERAGE									
LOT NO.	LOT AREA (SF)	PLAN AREA (SF)	PERCENTAGE						
1	6170	2751.21	44.59%						
2	5597	2682.61	47.93%						
3	6372	2682.61	42.10%						
4	5945	2751.21	46.27%						
5	5975	2682.61	44.89%						
6	7038	3080.45	43.77%						
7	7374	3080.45	41.77%						
8	8618	3435.21	39.86%						
9	5695	2682.61	47.10%						
10	5250	2751.21	52.40%						
11	6412	2682.61	41.84%						
12	7302	2682.61	36.74%						
13	5934	2751.21	46.36%						
14	6829	2682.61	39.28%						
15	7195	3435.21	47.74%						
16	5250	2682.61	51.10%						
17	6171	2751.21	44.58%						
18	6171	2682.61	43.47%						
19	9556	3080.45	32.24%						
20	7839	2751.21	35.10%						

LOT COVERAGE									
LOT NO.	LOT AREA (SF)	PLAN AREA (SF)	PERCENTAGE						
53	6155	2751.21	44.70%						
54	6156	3435.21	55.80%						
55	6156	3080.45	50.04%						
56	6156	3435.21	55.80%						
57	6156	3080.45	50.04%						
58	6156	3435.21	55.80%						
59	6154	3080.45	50.06%						
60	6238	3435.21	55.07%						
61	6312	3080.45	48.80%						
62	6398	3435.21	53.69%						
63	6518	3080.45	47.26%						
64	6638	3435.21	51.75%						
65	6645	3080.45	46.36%						
66	6874	3435.21	49.97%						
67	7174	2682.61	37.39%						
68	7137	2751.21	38.55%						
69	6838	3080.45	45.05%						
70	6794	3435.21	50.56%						
71	6794	2682.61	39.48%						
72	6285	2751.21	43.77%						

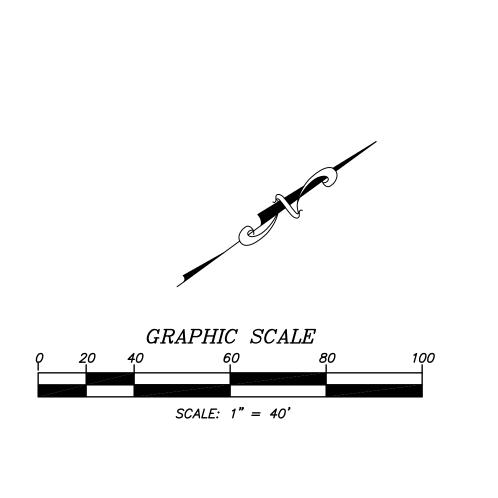


DESIGN B NS		CITY OF PALM SPRINGS, CALIFORNIA	SHEET
DRAWN B	CIVIL ENGINEERS, INC.	SITE PLAN] 1
CHECK B	Ph: 949 474-2330 Fax: 949 474-0251	LOTS 1-20, 53-72 ESCENA - TRACT 32233	OF 2 SHEETS 13-1953

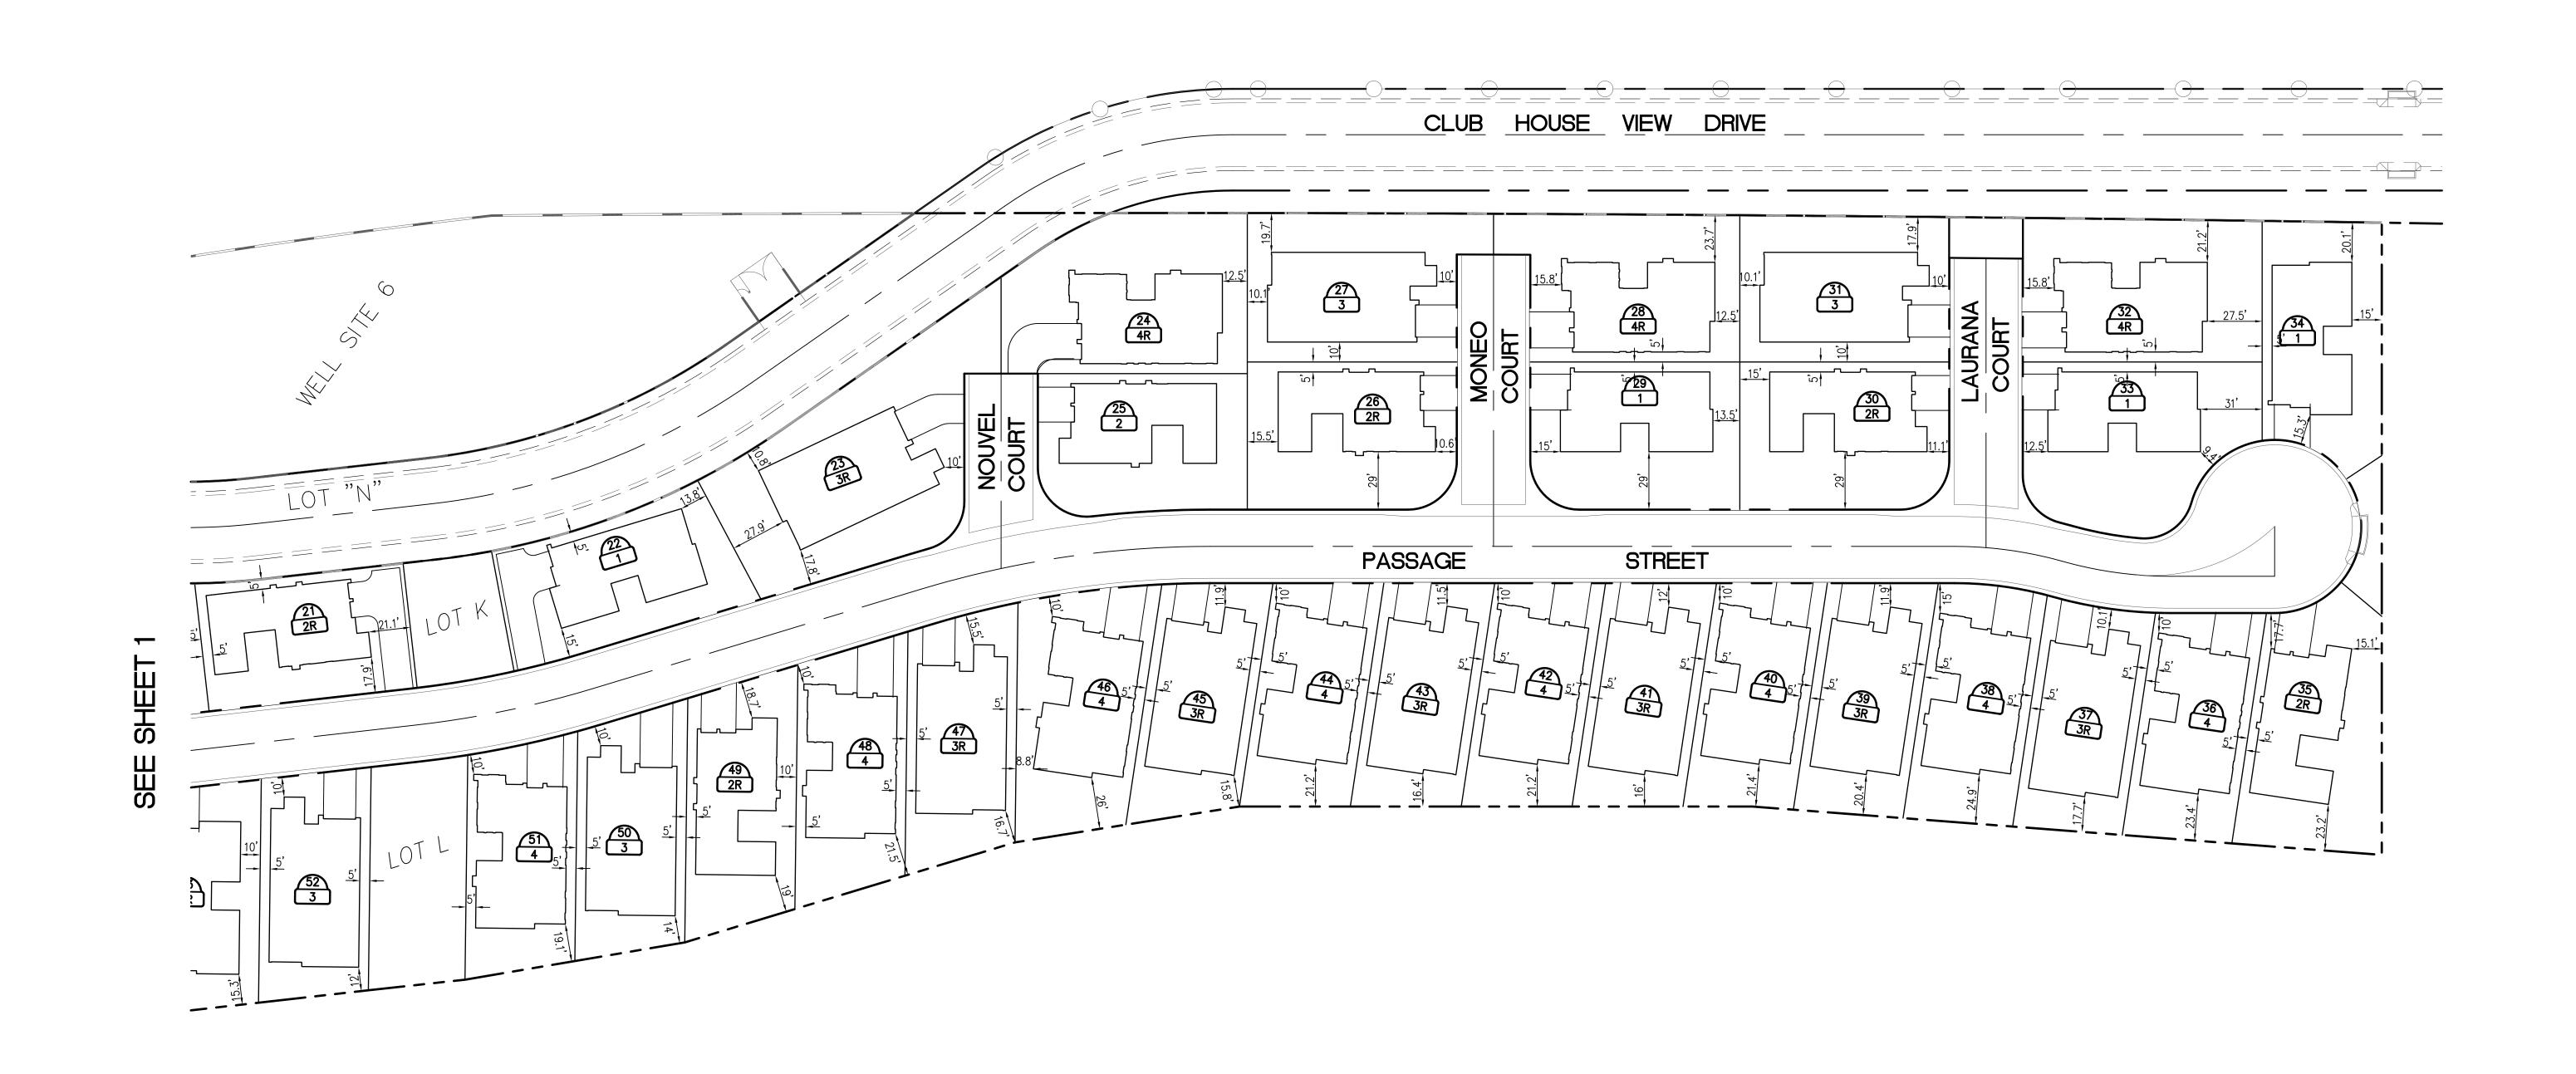



FLOOR PLAN LEGEND

PLAN-1

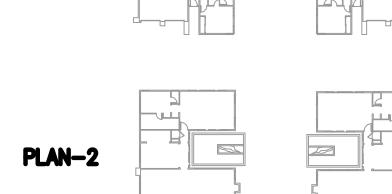




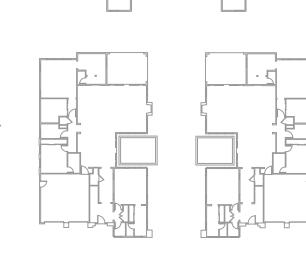

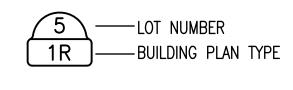

LOT COVERAGE									
LOT NO.	LOT AREA (SF)	PLAN AREA (SF)	PERCENTAGE						
21	6620	2682.61	40.52%						
22	7355	2751.21	37.41%						
23	11920	3435.21	28.81%						
24	9167	3080.45	33.60%						
25	7190	2682.61	37.31%						
26	7641	2682.61	35.11%						
27	8213	3435.21	41.83%						
28	8147	3080.45	37.81%						
29	7641	2751.21	36.01%						
30	7641	2682.61	35.11%						
31	8063	3435.21	42.60%						
32	8968	3080.45	34.35%						
33	8695	2751.21	31.64%						
34	7011	2751.21	39.24%						
35	8200	2682.61	32.71%						
36	6305	3080.45	48.86%						
37	6259	3435.21	54.88%						
38	6573	3080.45	46.87%						
39	6434	3435.21	53.39%						
40	6245	3080.45	49.33%						

LOT COVERAGE										
LOT NO.	LOT AREA (SF)	PLAN AREA (SF)	PERCENTAGE							
41	6229	3435.21	55.15%							
42	6229	3080.45	49.45%							
43	6229	3435.21	55.15%							
44	6229	3080.45	49.45%							
45	6477	3435.21	53.04%							
46	7666	3080.45	40.18%							
47	6702	3435.21	51.26%							
48	6733	3080.45	45.75%							
49	6733	2682.61	39.84%							
50	6531	3435.21	52.60%							
51	6237	3080.45	49.39%							
52	6155	3435.21	55.81%							

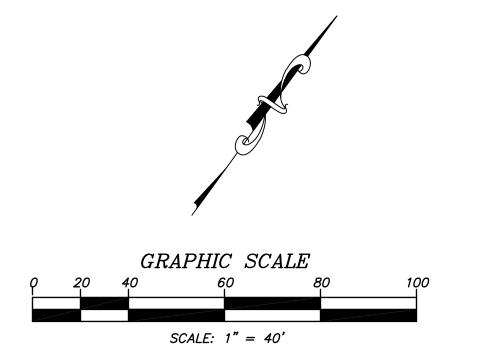

DESIGN BY NS	PREPARED BY:	CITY OF PALM SPRINGS, CALIFORNIA	SHEET
DRAWN BY NS	ADAMS • STREETER CIVIL ENGINEERS, INC.	SITE PLAN	2
CHECK BY NS	15 Corporate Park, Irvine, CÁ 92606 Ph: 949 474-2330 Fax: 949 474-0251	LOTS 21-52 ESCENA - TRACT 32233	OF 2 SHEETS 13-1953

- 3. Nothing in these Plans shall relieve the Contractor from obtaining permits as required by Chapter 14.16 of the City of Palm Springs Municipal Code.
- 4. The Contractor shall set an appointment for inspection with the engineering inspector a minimum of 24 hours prior to the date of inspection.
- 5. All grading shall comply with Section 1804 and Appendix J of the 2010 California
- 6. The location of existing underground utilities are to be shown in a schematic manner only. Subject to the provisions of Section 4215 of the California Government Code, the Contractor shall determine the exact location of all existing utilities before commencing the Work. Contact Underground Service Alert (U.S.A.) at 1-800-227-2600 two working days prior to any excavation.
- '. Dimensioning to curbs shall be to face of curb.
- 8. Contractor shall dispose of all debris off—site daily, unless otherwise specified by the City Engineer.
- 9. Contractor shall remove any abandoned utility facilities and show limits of removals on the record drawings.
- 10. The Contractor shall be responsible for the removal, replacement or relocation of all regulatory, warning and guide signs.
- 11. A 'Record Drawing' (formerly called "As—Built" Drawing) of this Plan shall be submitted by the Project Engineer of record to the City Engineer, for approval prior to acceptance of the Work.
- 12. Construction signing, lighting and barricading shall be provided on all projects as required by City Standards or as directed by the City Engineer. As a minimum, all construction signing, lighting and barricading shall be in accordance with Part 6 "Temporary Traffic Control" of the California Manual on Uniform Traffic Control Devices for Streets and Highways, dated January 13, 2012, or subsequent editions in force at the time of construction.
- 13. The flow line of all curb and gutters and cross gutters shall be water tested before acceptance of the Work.
- 14. Parking stalls shall be clearly delineated with a 4 to 6 inch stripe "hairpin" or elongated "U" design or other approved striping or stall delineation.
- 15. Final site grading and drainage flow lines shall be certified, in writing, by the Engineer of Record to be in conformance to the approved grading plan PRIOR TO FINAL INSPECTION.
- 16. For projects in excess of 1 acre, a Notice of Intent to comply with California General Construction Stormwater Permit (Water Quality Order 2009-0009-DWQ as modified September 2, 2009, as well as a copy of the executed letter issuing a Waste Discharge Identification (WDID) number, is required prior to issuance of Grading or Building Permit, via the California Regional Water Quality Control Board (Phone No. (760) 346-7491). A updated copy of the project-specific Storm Water Pollution Prevention Plan (SWPPP) must be kept at the project site at all times.
- 17. A city approved fugitive dust (PM-10) control plan is required prior to issuance of a grading permit. All dust control measures described in AQMD Rule 403 (BEST AVAILABLE CONTROL MEASURES) and in the City—approved fugitive dust control plan shall be implemented at all times. A wind fence and proper signage, shall be erected, inspected and approved by the City's Dust Control Inspector prior to initiation of clearing, grubbing, grading or import/export of soil, or fill material at the site. Failure to call 760-323-8253, extension 8740 for inspection 72 hours prior to initiating work will result in issuance of citation by the City.
- 18. The block walls, retaining walls, and other structures shown on the grading plan are for location purposes only. Separate permits for the above are required from the Building Department.
- 19. All provisions of the preliminary soils report (with the date of the report specified on the Grading Plan) prepared by a California registered Geotechnical Engineer, shall be complied with.

<u>STREET PAVEMENT</u>

20. The asphalt concrete design shall meet the City of Palm Springs Std. Dwg. No 110 and Standard Specifications for Public Works Construction, 2012 Edition: use Type B for the base lift and Type C2 for the final 1" cap. The design shall have a HVEEM stability of 35 AND 33 respectively per the California Test Method 304 and 366. Performance Grade asphalt (PG 70-10) meeting the 2010 Caltrans Standard Specifications shall be used. The specified miscellaneous base shall be crushed miscellaneous base according to the Standard Specifications for Public Works Construction, 2012 Edition.

TRENCH PAVEMENT

Inderground Service Aler[.]


USA North


OA

- 1. Street cuts shall be paved with temporary A.C. paving immediately. Major and Secondary Thoroughfares shall be permanently paved within 15 days of the initial excavation (30 days on collector and residential streets) per City of Palm Springs Std. Dwg. No. 115. See Ordinance No. 14.16.375.
- 22. Trenches shall be completely backfilled and compacted to support traffic at the end of each work day. The Contractor shall place permanent pavement through intersections at the end of each work day. No trench excavation or pipe laying on Fridays, weekends or holidays will be permitted on major and secondary thoroughfares or collector streets without prior approval of the City Engineer. Contractor shall place permanent paving each Friday.
- 3. If, in the opinion of the City Engineer, the trench backfill is unsafe to traffic, the Contractor shall place permanent paving at the end of each work day.
- 24.Steel trench plating shall conform to the Caltrans Encroachment Permit Manual Section 602.1 as revised July, 2009.
- 25.The specified miscellaneous base shall be crushed miscellaneous base according to the Standard Specifications for Public Works Construction, 2012 Edition.

IN THE CITY OF PALM SPRINGS, COUNTY OF RIVERSIDE, STATE OF CALIFORNIA

TRACT 32233 PRECISE GRADING LOTS 1-72

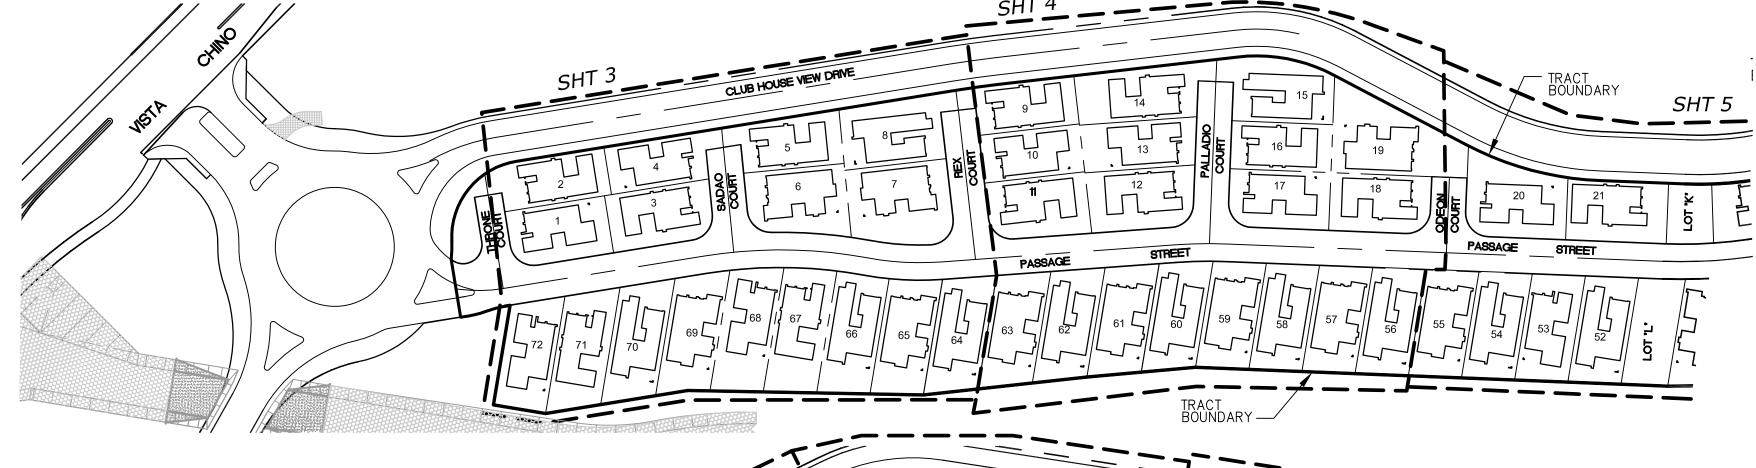

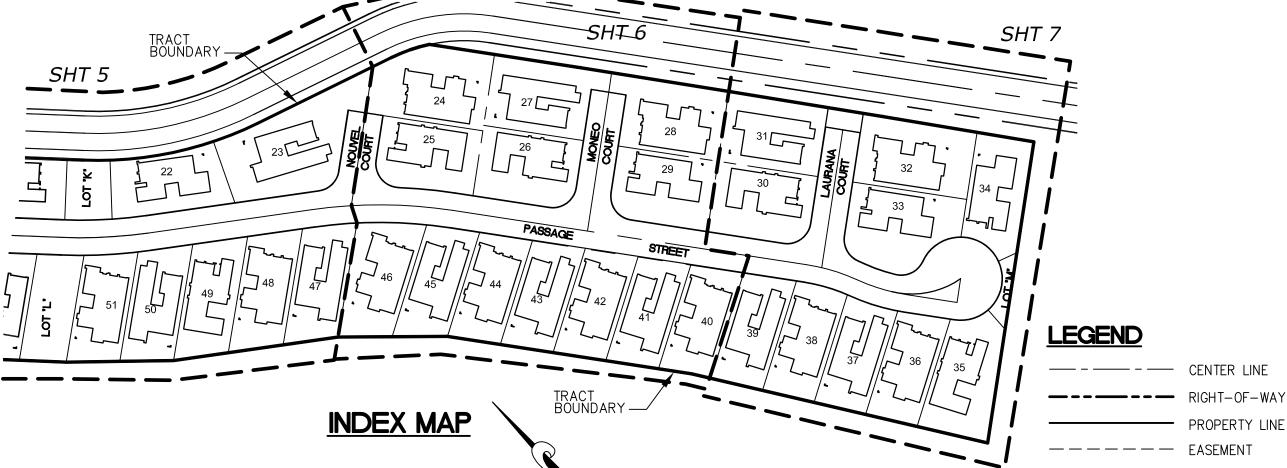

CONTRACTOR'S RESPONSIBILITY FOR SAFETY: IN SUBMITTING A BID FOR THIS WORK THE CONTRACTOR AGREES THAT HE SHALL ASSUME SOLE

RESPONSIBILITY FOR JOB SITE CONDITIONS DURING THE COURSE OF THIS PROJECT: INCLUDING SAFETY OF ALL PERSONS AND PROPERTY: THAT THIS REQUIREMENT SHALL APPLY CONTINUOUSLY AND NOT BE LIMITED TO NORMAL WORKING HOURS. AND THAT THE CONTRACTOR SHALL DEFEND. INDEMNIFY AND HOLD THE OWNERS AND THE ENGINEER HARMLESS FROM ANY AND ALL LIABILITY. REAL OR ALLEGED IN CONNECTION WITH THE PERFORMANCE OF WORK ON THIS PROJECT. EXCEPTING FOR LIABILITY ARISING FROM SOLE NEGLIGENCE OF THE OWNER OR ENGINEER.

ALL CONTRACTORS AND SUBCONTRACTORS PERFORMING WORK SHOWN ON OR RELATED TO THESE PLANS SHALL CONDUCT THEIR OPERATIONS SO THAT THE EMPLOYEES ARE PROVIDED A SAFE PLACE TO WORK AND THE PUBLIC IS PROTECTED. ALL CONTRACTORS AND SUBCONTRACTORS SHALL COMPLY WITH THE "OCCUPATIONAL SAFETY AND HEALTH REGULATIONS" OF THE U.S. DEPARTMENT OF LABOR AND WITH "CONSTRUCTION SAFETY ORDERS." THE CIVIL ENGINEER SHALL NOT BE RESPONSIBLE IN ANY WAY FOR THE CONTRACTOR OR SUBCONTRACTOR'S COMPLIANCE WITH SAID REGULATION AND ORDERS.

PRIVATE ENGINEER'S NOTICE TO CONTRACTOR(S)

THE EXISTENCE AND LOCATION OF ANY UNDERGROUND UTILITIES OR STRUCTURES SHOWN ON THESE PLANS ARE OBTAINED BY A SEARCH OF AVAILABLE RECORDS. TO THE BEST OF OUR KNOWLEDGE THERE ARE NO EXISTING UTILITIES EXCEPT THOSE SHOWN ON THIS PLAN. THE CONTRACTOR IS REQUIRED TO TAKE ALL PRECAUTIONARY MEASURES TO PROTECT THE UTILITIES SHOWN, AND ANY OTHER LINES OR STRUCTURES NOT SHOWN ON THESE PLANS, AND IS RESPONSIBLE FOR THE PROTECTION OF AND ANY DAMAGE TO THESE LINES OR STRUCTURES.

THE ESTIMATED QUANTITIES HEREON ARE ONLY FOR THE PURPOSE OF OBTAINING THE NECESSARY PERMITS, AND ADAMS-STREETER CIVIL ENGINEERS, INC. DOES NOT GUARANTEE THE ACCURACY OF THE ESTIMATED QUANTITIES. THE CONTRACTOR SHALL PERFORM HIS OWN QUANTITY TAKEOFF BEFORE SUBMITTING A BID FOR ANY PORTION OF THE IMPROVEMENTS COVERED BY THESE PLANS. THE CONTRACTOR SHALL VERIFY ALL CONDITIONS AND DIMENSIONS AND SHALL REPORT DISCREPANCIES TO THE ENGINEER PRIOR TO COMMENCEMENT. THE CONTRACTOR SHALL ADHERE TO REGULATIONS REGARDING THE WORK PER SOUTH COAST AIR QUALITY MANAGEMENT DISTRICT RULE NO. 403.


THE PRIVATE ENGINEER SIGNING THESE PLAN IS RESPONSIBLE FOR ASSURING THE ACCURACY AND ACCEPTABILITY OF THE DESIGN HEREON. IN THE EVENT OF DISCREPANCIES ARISING AFTER CITY OF CALIMESA APPROVAL OR DURING CONSTRUCTION, THE PRIVATE ENGINEER SHALL BE RESPONSIBLE FOR DETERMINING AN ACCEPTABLE SOLUTION AND REVISING THE PLANS FOR APPROVAL BY THE CITY OF CALIMESA.

GRAPHIC SCALE

SCALE: 1'' = 100'

- CONSTRUCTION NOTES AND QUANTITIES (1) INSTALL 4" PVC PIPE SCHD. 40 OR EQUAL----(2) INSTALL 4" ROUND GRATE AREA DRAIN PER NDS (PART NO.16) OR EQUAL — 359 EA

(4) CONSTRUCT FENCE OPENING PER DETAIL ON SHEET 2 ______144 EA

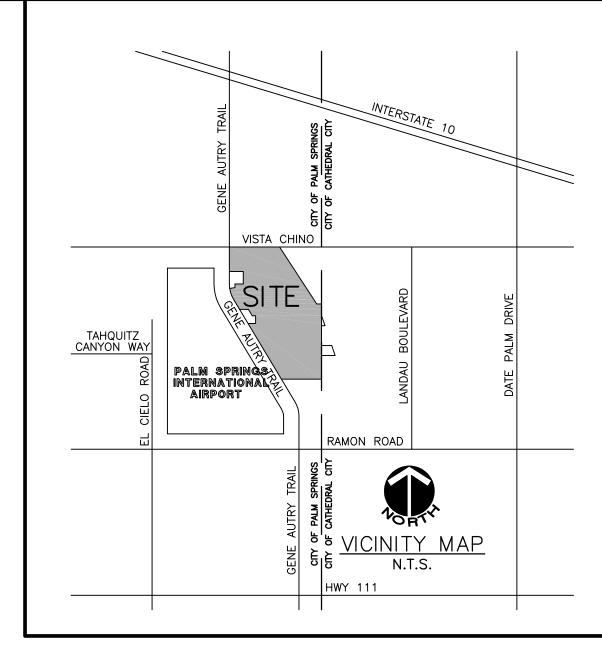

ENGINEER:

ADAMS-STREETER CIVIL ENGINEERS INC. 15 CORPORATE PARK, IRVINE, CA 92606 PH. (949) 474-2330

TOPO SOURCE

INLAND AERIAL

7117 ARLINGTON AVENUE, SUITE A RIVERSIDE, CA 92503 PH. (951) 687-4252 PHOTOGRAPHY DATED: 06/23/04

APPLICANT: BEAZER HOMES 1800E. IMPERIAL HIGHWAY SUITE 1400 BREA, CA 90821 PH. (714) 285-2900

REQUIRED PERMITS

GRADING PERMIT WALL PERMIT

UTILITIES:

#---- DAYLIGHT LINE

───────────────────────FLOW LINE

--- TOP/BOTTOM OF SLOPE

DEEPENED FOOTING

BUBBLER

GRATE INLET

SEWER PIPE

WATER PIPE

STREET SIGN

EXISTING BLOCK WALL

STOP SIGN

RAIL FENCE

PLAN

3 4R

AREA DRAIN PIPE

STORM DRAIN PIPE

AIR RELEASE VALVE & SERVICE LINE

WATER METER & SERVICE LINE

FIRE HYDRANT & SERVICE LINE

STEP AND RISER HEIGHT

IRRIGATION: WHITEWATER MUTUAL WATER DISTRICT (760) 325-5880 DESERT WATER AGENCY (760) 323-4971 CITY OF PALM SPRINGS (760) 323-8253 SEWER: **ELECTRIC:** SOUTHERN CALIFORNIA EDISON (760) 202-4291 THE GAS COMPANY/SEMPRA ENERGY CO. (760) 323-1851 GENERAL TELEPHONE COMPANY (760) 323–1231 TELEPHONE: TIME WARNER CABLE (760) 340-1312 EXT. 281 CABLE TV:

UNDERGROUND SERVICE ALERT

LEGEND


GARAGE FINISHED FLOOR **FINISHED** P PAD ELEVATION HP HIGH POINT R/W RIGHT OF WAY FINISHED GRADE EDGE OF PAVEMENT FLOW LINE FINISHED SURFACE ASPHALT CONCRET GRADE BREAK TOP OF CURB TOP OF BERM INV. INVERT TW TOP OF WALL

BASIS OF BEARING

THE BASIS OF BEARING FOR THIS MAP IS THE NORTHERLY LINE OF THE NORTHEAST QUARTER OF SECTION 7, T. 4 S., R. 5 E., S.B.M.,
ALSO BEING THE CENTERLINE OF VISTA CHINO, AS SHOWN ON TRACT MAP NO. 32233-1, PER P.M.B. 183/35-37, TAKEN AS N 89°51'11" W. ANGLE POINTS, UNLESS OTHERWISE NOTED.



REVISION 445.98 APPROXIMATELY 40 FEET SOUTHEASTERLY OF THE SOUTHEASTERLY CORNER OF BRIDGE OVER THE WHITEWATER RIVER ON VISTA CHINO. IN THE TOP OF THE CONCRETE SLOPE PAVING EASTERLY SIDE OF RIVER SOUTHERLY OF VISTA

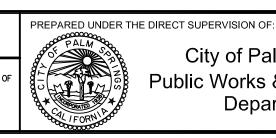

City of Palm Springs Public Works & Engineering Department

design by: NS	CITY CHECK	RIGHT-OF- WAY
DRAWN BY:		TRAFFIC ENG'G
REVIEWED BY:	DATE	FIELD ENG'G


S	CITY CHECK	RIGHT-OF- WAY	INITIAL	DATE	PREPARED BY:		APPROVED BY:	
S		TRAFFIC ENG'G	:		ASSISTANT CIT	Y ENGINEER	CITY ENGIN	NEER
sy: S	DATE	FIELD ENG'G	:		R.C.E. NO.	DATE	R.C.E. NO.	DATE

CITY OF PALM SPRINGS, CALIFORNIA PRECISE GRADING PLAN TITLE SHEET


C.P. XX-XX FILE NO.

(800) 227-2600


SHEET XX - XX - XX

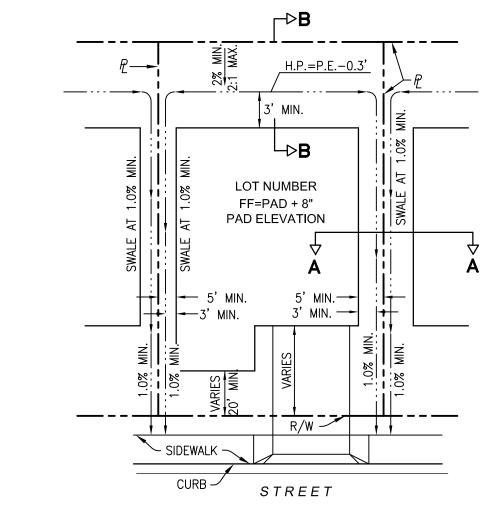


TYPICAL LOT GRADING AND DRAINAGE DETAIL

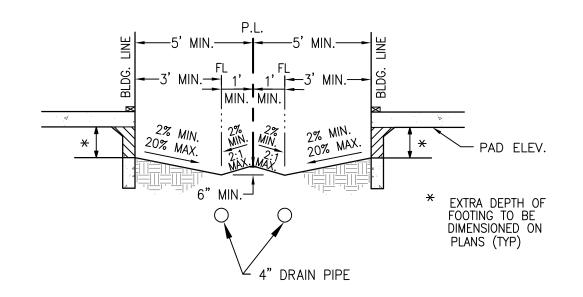

B SECTION A-A TYPICAL SIDEYARD SECTION

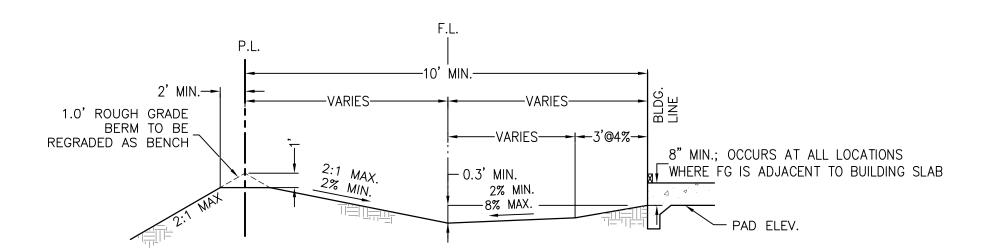


SECTION B-B
TYPICAL REAR YARD SECTION

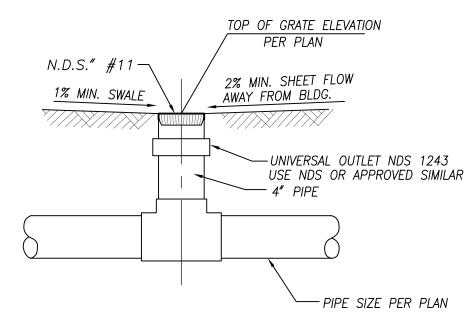

NOTES:

- ALL FITTING BY: NATIONAL DIVERSIFIED SALES INC. (OR EQUAL). 2550 AZURITE CIRCLE
- NEWBURY PARK, CA 91320 2. REFER TO FINISH GRADING.
- 3. DO NOT GLUE GRATE OR RISER TO PIPE.
- 4. GLUE: "I.P.S. WELD ON" # 773 SOLVENT (MEDIUM BODIED FAST SET FOR ABS PIPE THRU 6" \emptyset)
- 5. WHEN MIN. DEPTH REQUIRED IS 0.7', USE ONE 90° ELL.



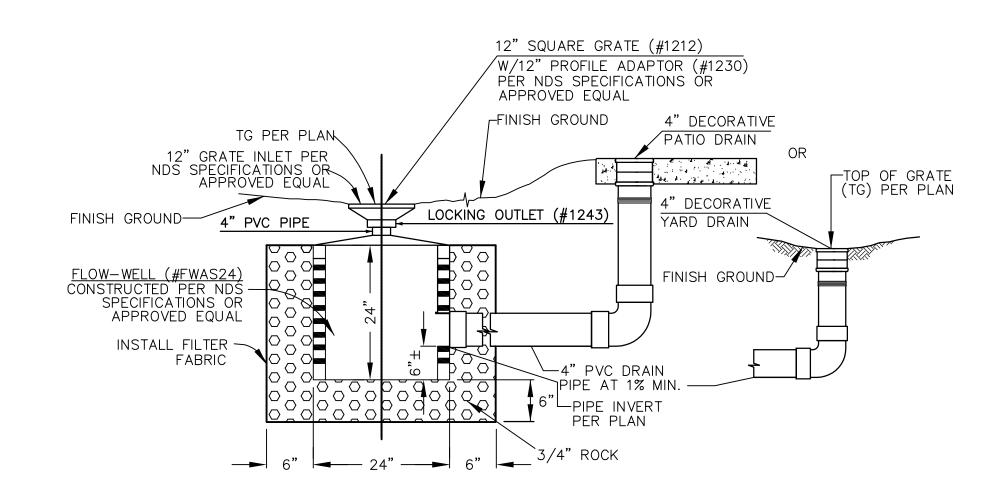

BUBBLER DRAIN DETAILS

NOT TO SCALE

NOMENCLATURE:

BW CF CL DF FF FG FL FS GB	BACK OF WALK CURB FACE CENTER LINE DEEPENED FOOTING FINISHED FLOOR FINISHED GRADE FLOW LINE FINISHED SURFACE GRADE BREAK GARAGE FINISHED FLOOR
HP	HIGH POINT
INV	INVERT
MAX	MAXIMUM
MIN	MINIMUM
$PL_{\underline{\cdot}}$	PROPERTY LINE
R/W	RIGHT-OF-WAY
S=	PIPE SLOPE
ST	STREET
STA	STATION
SW	SIDEWALK
TC	TOP OF CURB
TG	TOP OF GRATE
TF	TOP OF FOOTING
TRW	TOP OF RETAINING WALL

Underground Service Alert
USA North


811


1-800-227-2600


TWO MODELING DAYS REFERENCE YOUR DISC.


1-800-227-2600 TWO WORKING DAYS BEFORE YOU DIG														C.P.)	XX-XX	
REVISION	APPROVED DA	ATE	BENCH MARK 111 ELEV. 445.98	PREPARED UNDER	R THE DIRECT SUPERVISION OF:	DESIGN BY:	CITY CHECK	RIGHT-OF- INITIAL DATE WAY	PREPARED BY:		APPROVED BY:		CITY OF PALM SPRINGS, CALIFORNIA	FILE NO.	SHEET 60	
			LOCATION APPROXIMATELY 40 FEET SOUTHEASTERLY OF THE SOUTHEASTERLY CORNER ON MISTA CHINO IN THE TOP OF THE		City of Palm Springs Public Works & Engineering	DRAWN BY:		TRAFFIC ENG'G	ASSISTANT C	TY ENGINEER	CITY ENGINEER		PRECISE GRADING PLAN	DWG. NO.	2	
			CONCRETE SLOPE PAVING EASTERLY SIDE OF RIVER SOUTHERLY OF VISTA CHINO.	CAL I FORNIA	Department	REVIEWED BY:	DATE	FIELD : ENG'G :	R.C.E. NO.	DATE	R.C.E. NO.	ATE	DETAILS AND SECTIONS	CADD FILE NAME	7 OF 7 SHTS.	,


X Reazer - Ferenal Gradinal Precise / SHT 1-2 dw

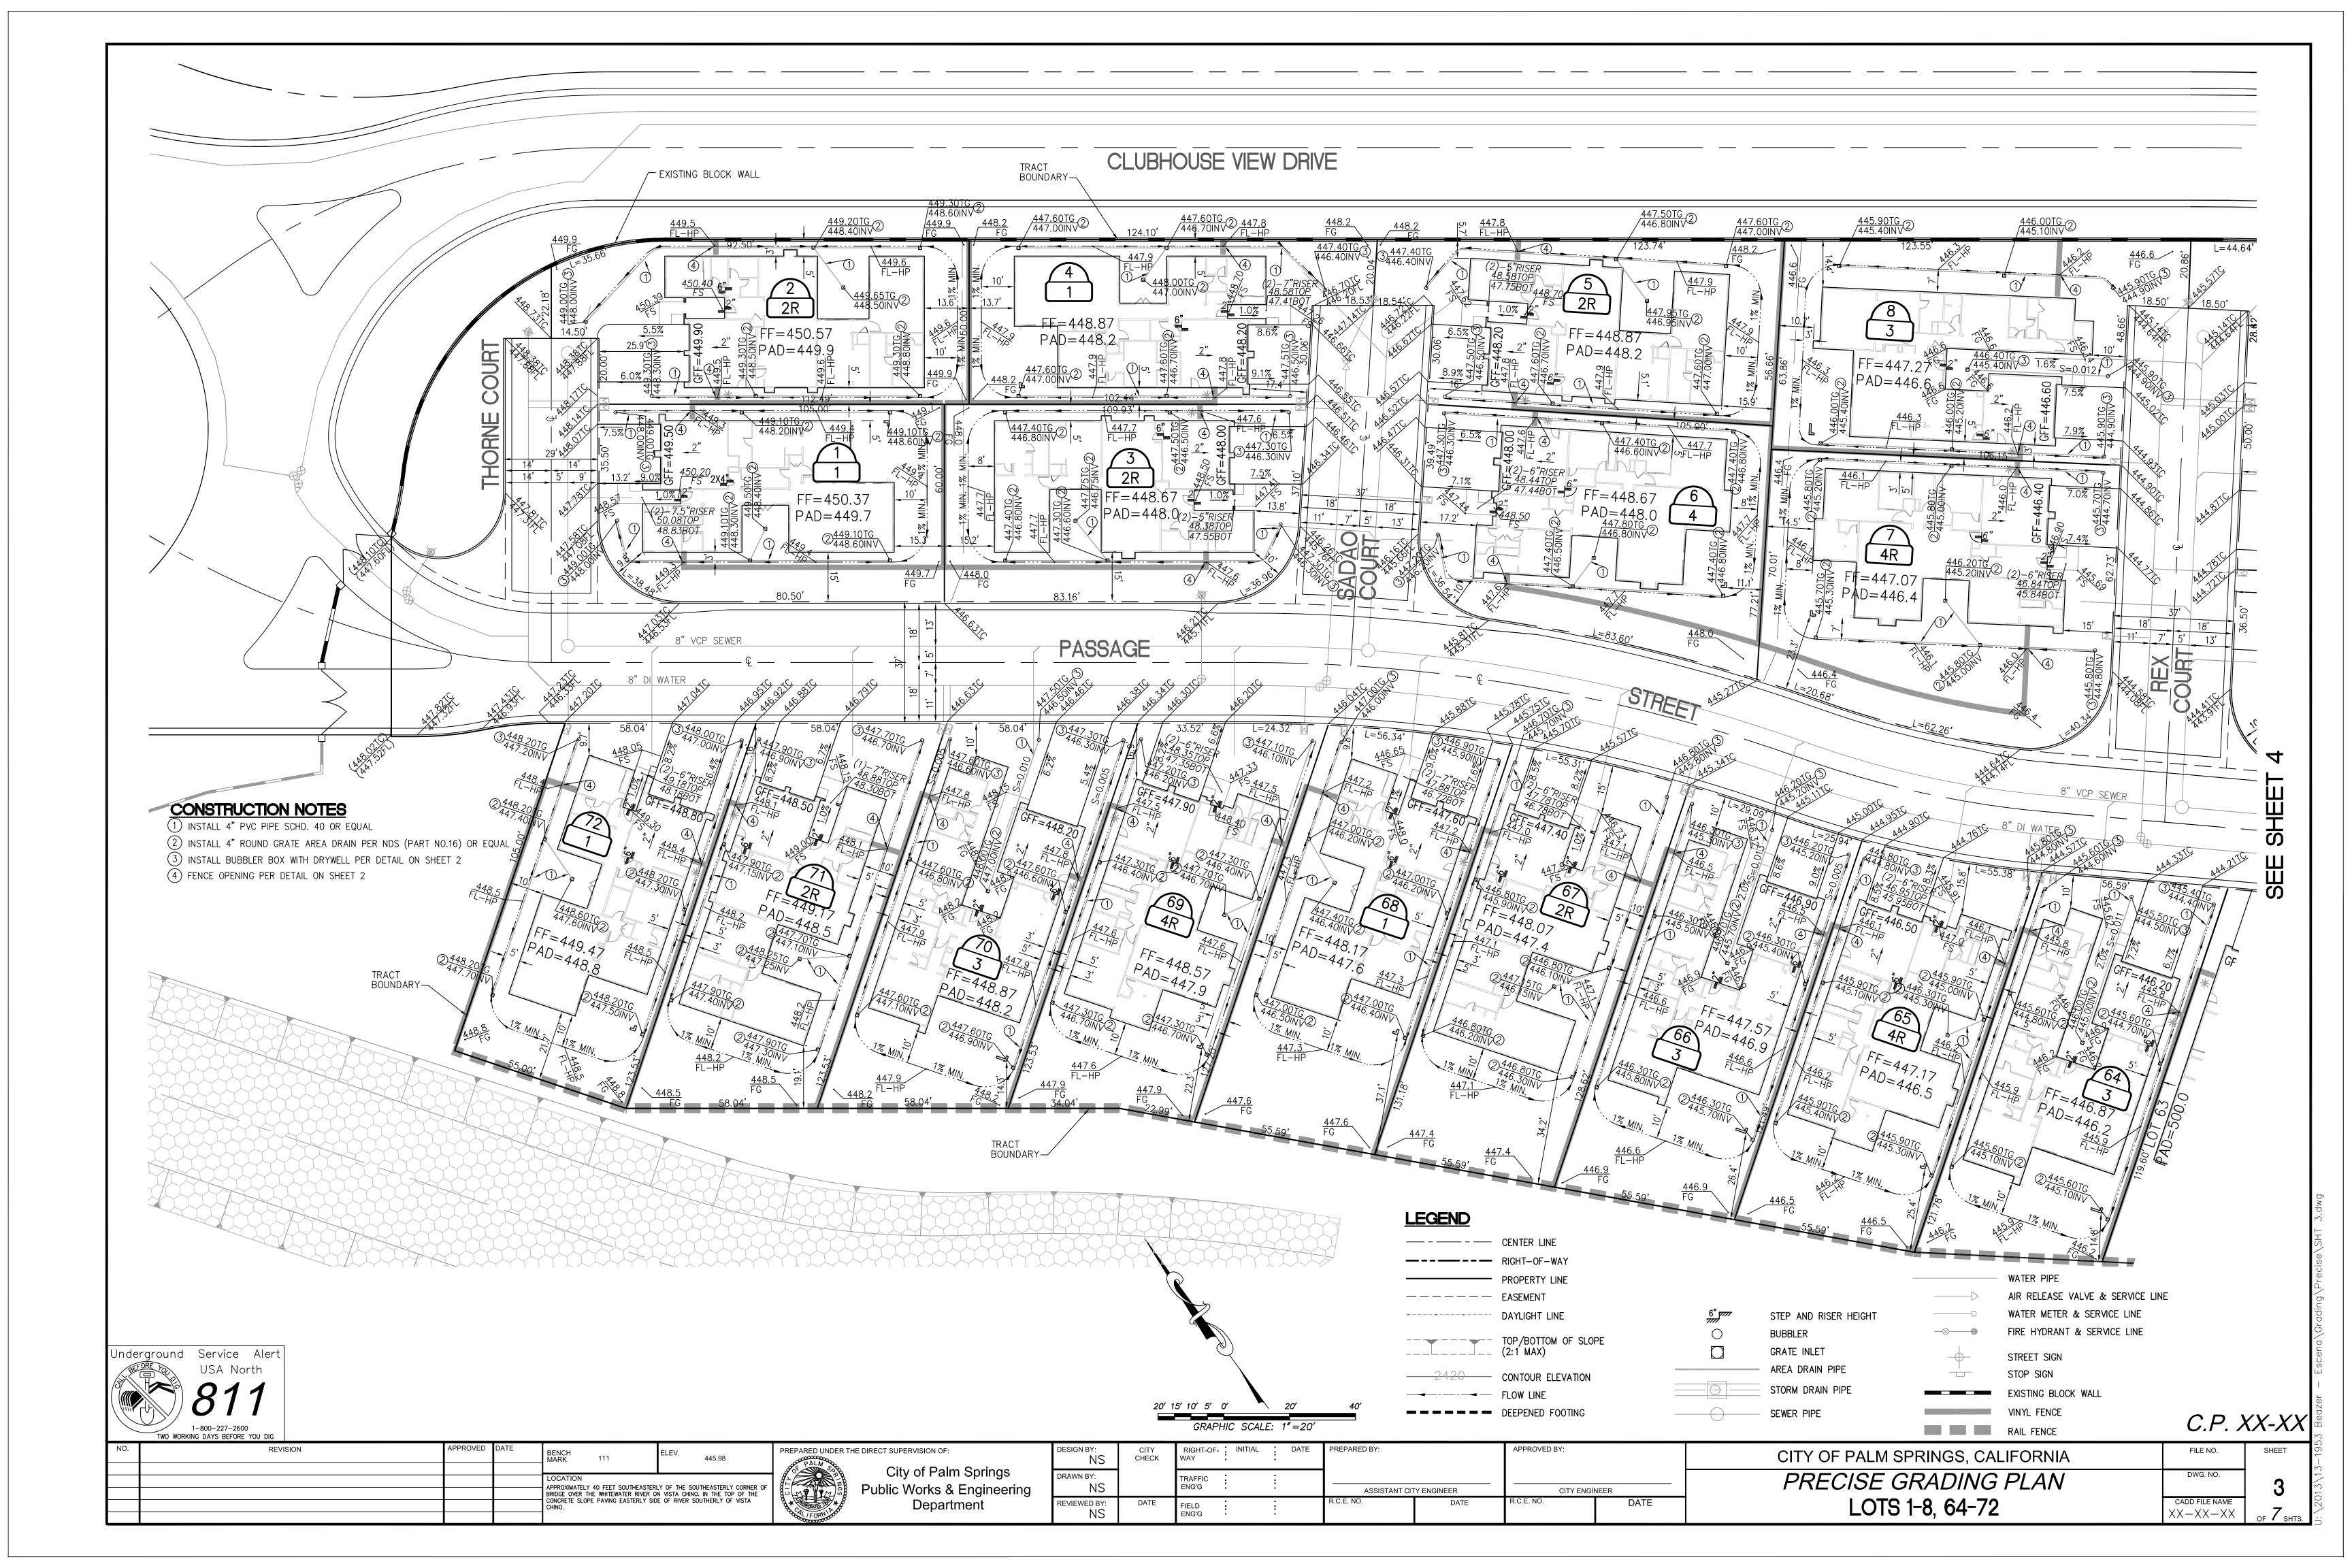

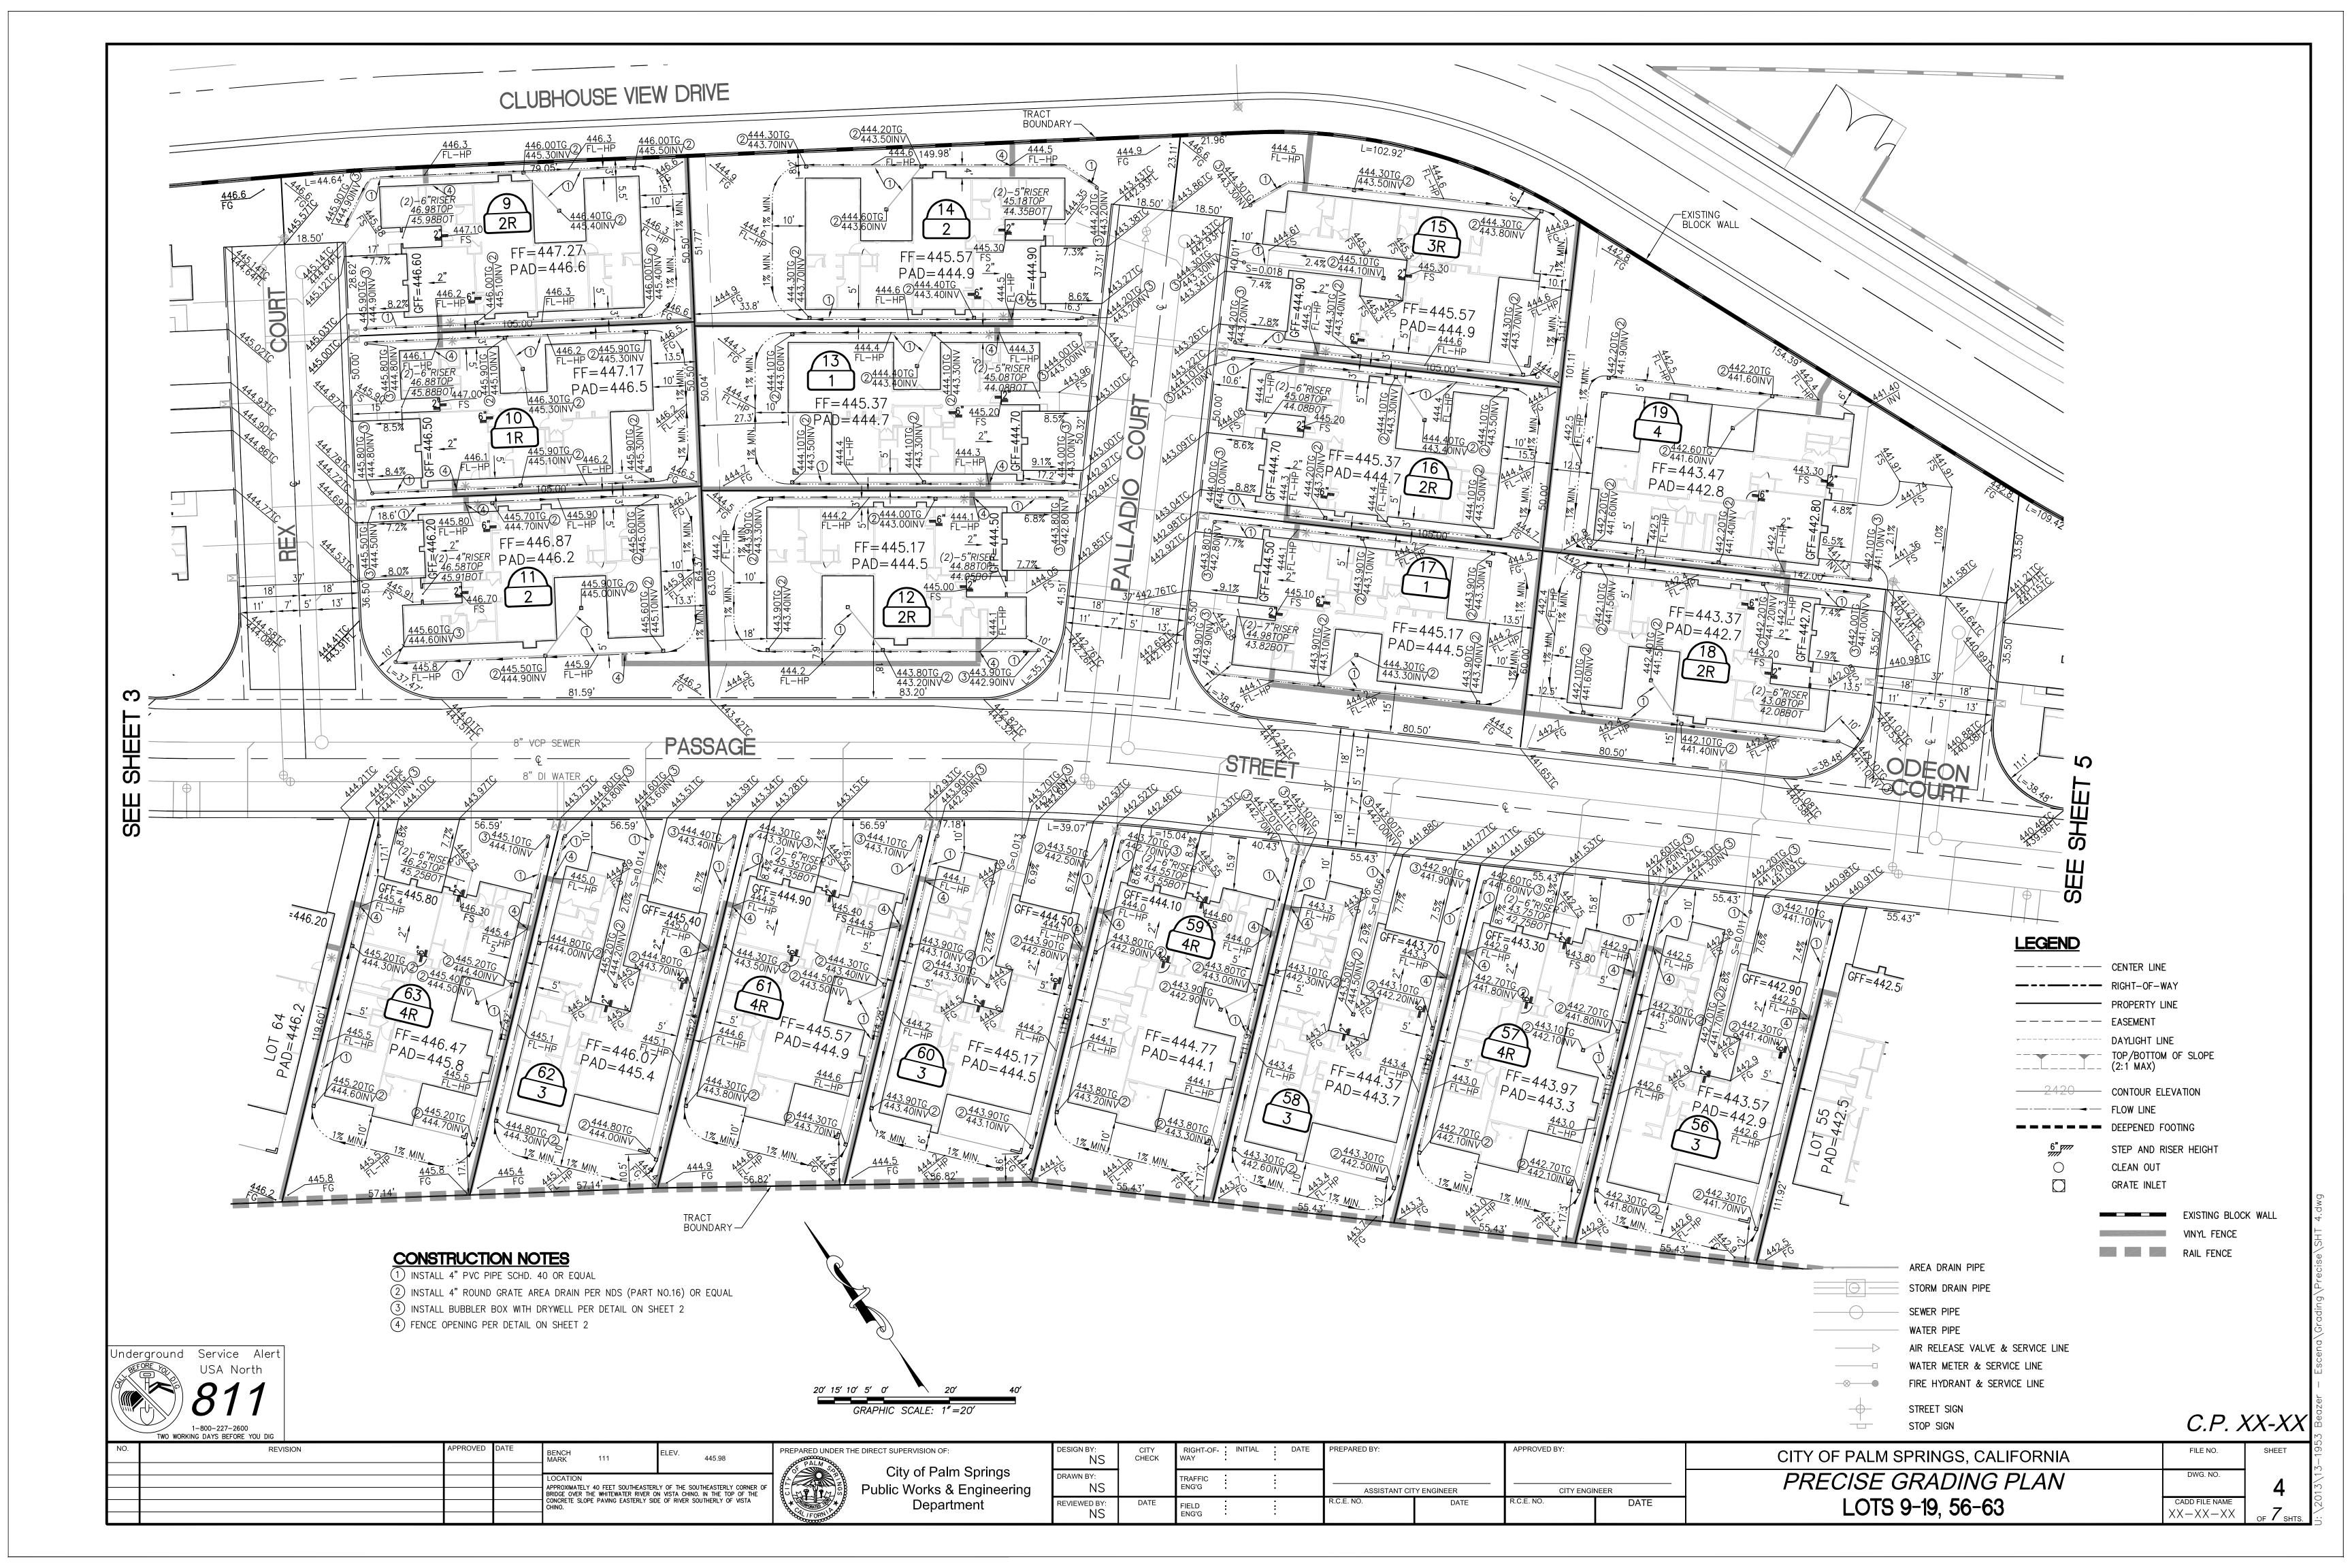

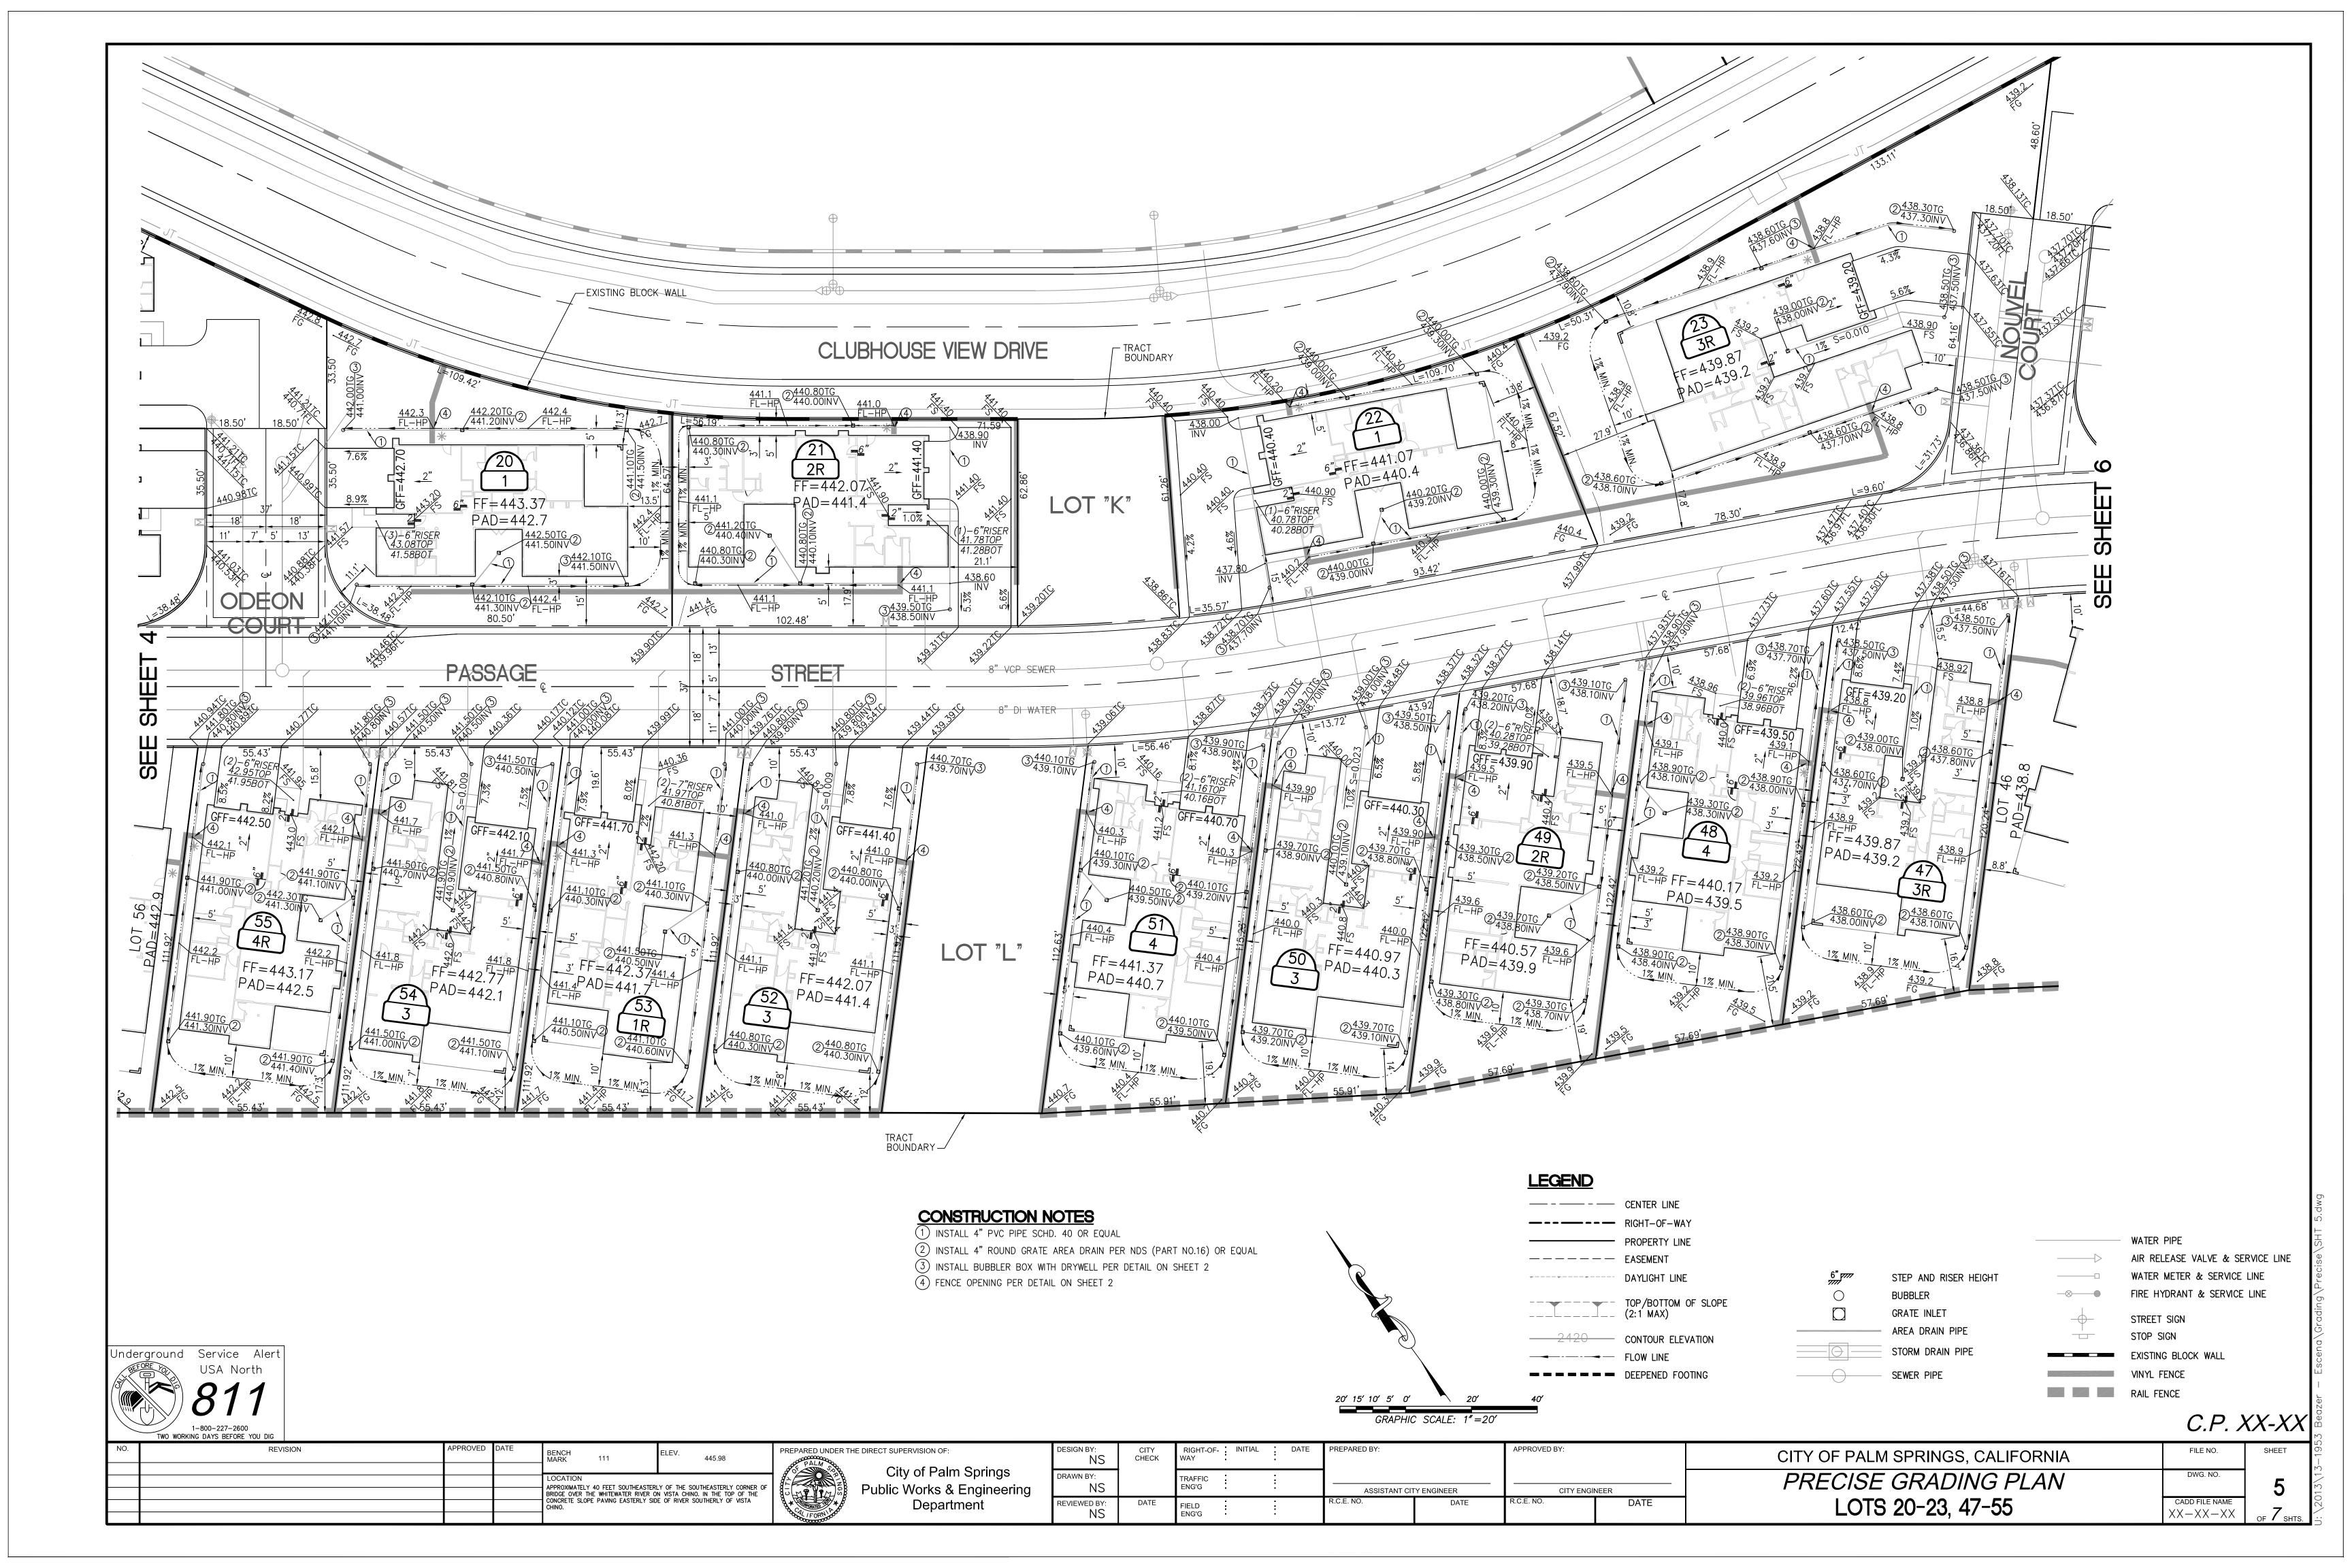

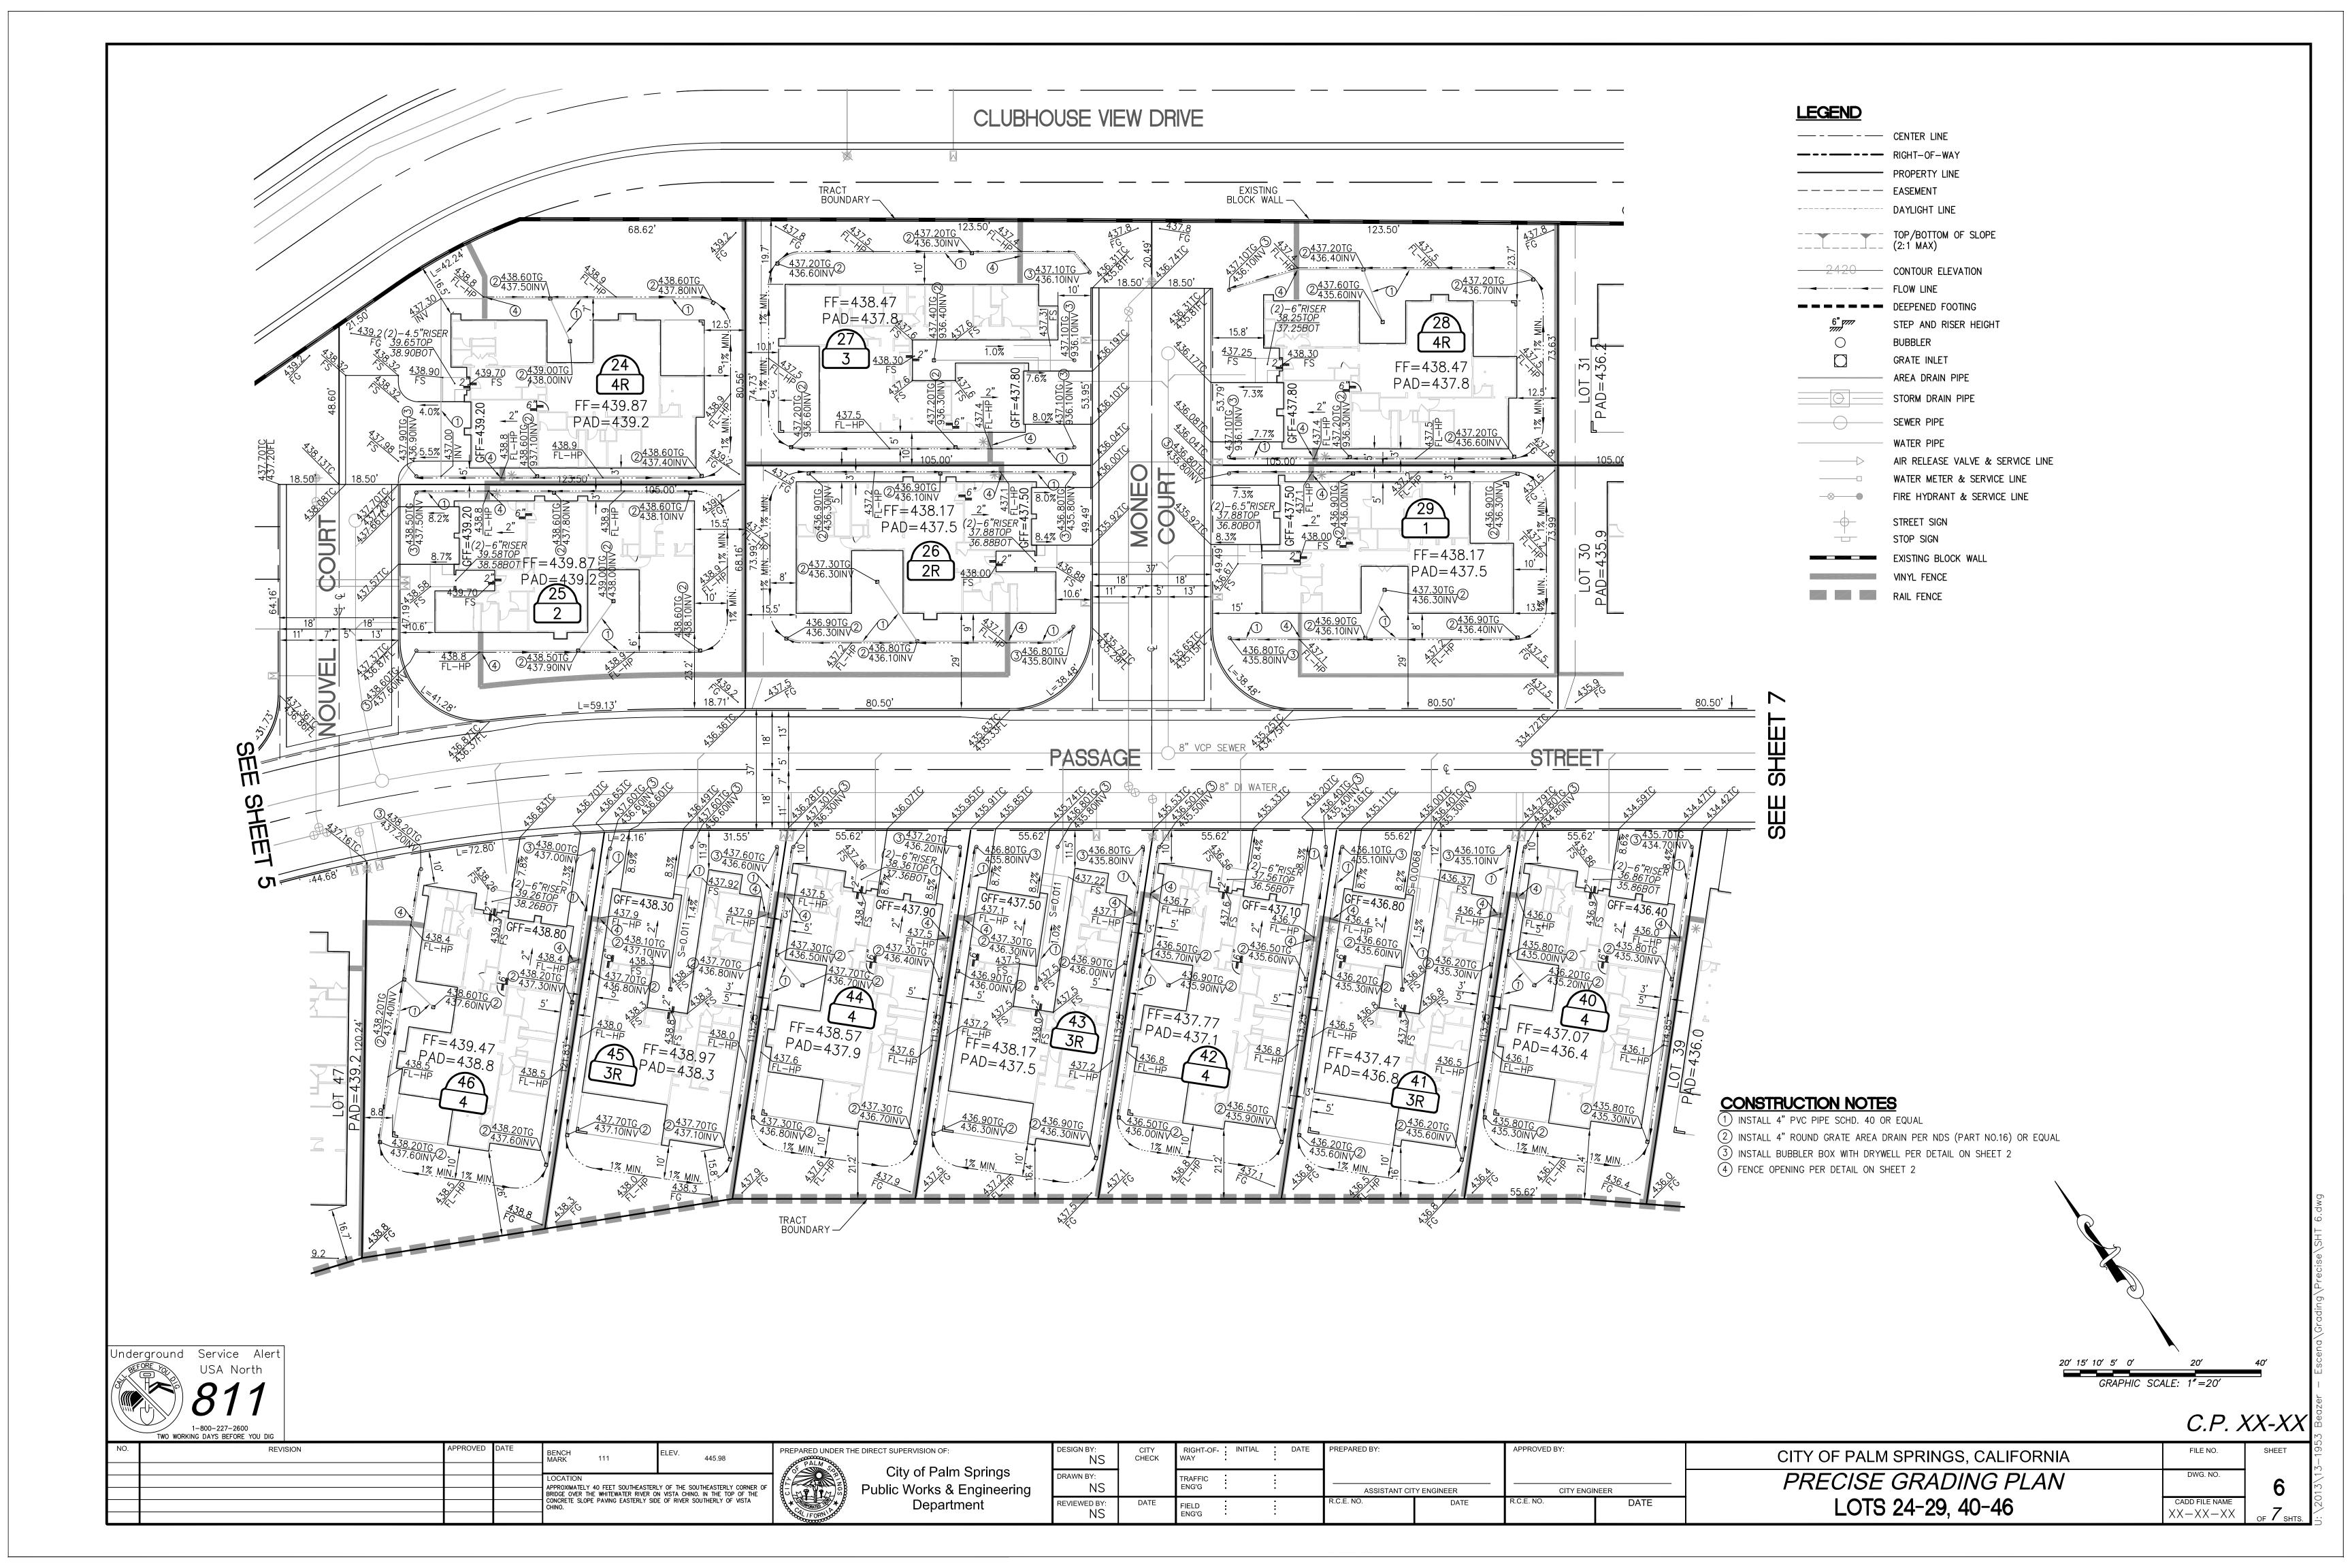

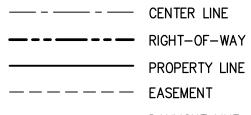

LEGEND

————— EASEMENT DAYLIGHT LINE TOP/BOTTOM OF SLOPE (2:1 MAX) — 2420 CONTOUR ELEVATION DEEPENED FOOTING STEP AND RISER HEIGHT BUBBLER GRATE INLET

STORM DRAIN PIPE SEWER PIPE

----- AREA DRAIN PIPE

WATER PIPE AIR RELEASE VALVE & SERVICE LINE WATER METER & SERVICE LINE FIRE HYDRANT & SERVICE LINE


STREET SIGN


RAIL FENCE

CONSTRUCTION NOTES

- 1) INSTALL 4" PVC PIPE SCHD. 40 OR EQUAL
-) INSTALL 4" ROUND GRATE AREA DRAIN PER NDS (PART NO.16) OR EQUAL 3) INSTALL BUBBLER BOX WITH DRYWELL PER DETAIL ON SHEET 2

(4) FENCE OPENING PER DETAIL ON SHEET 2

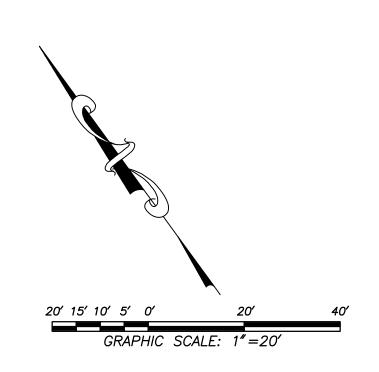

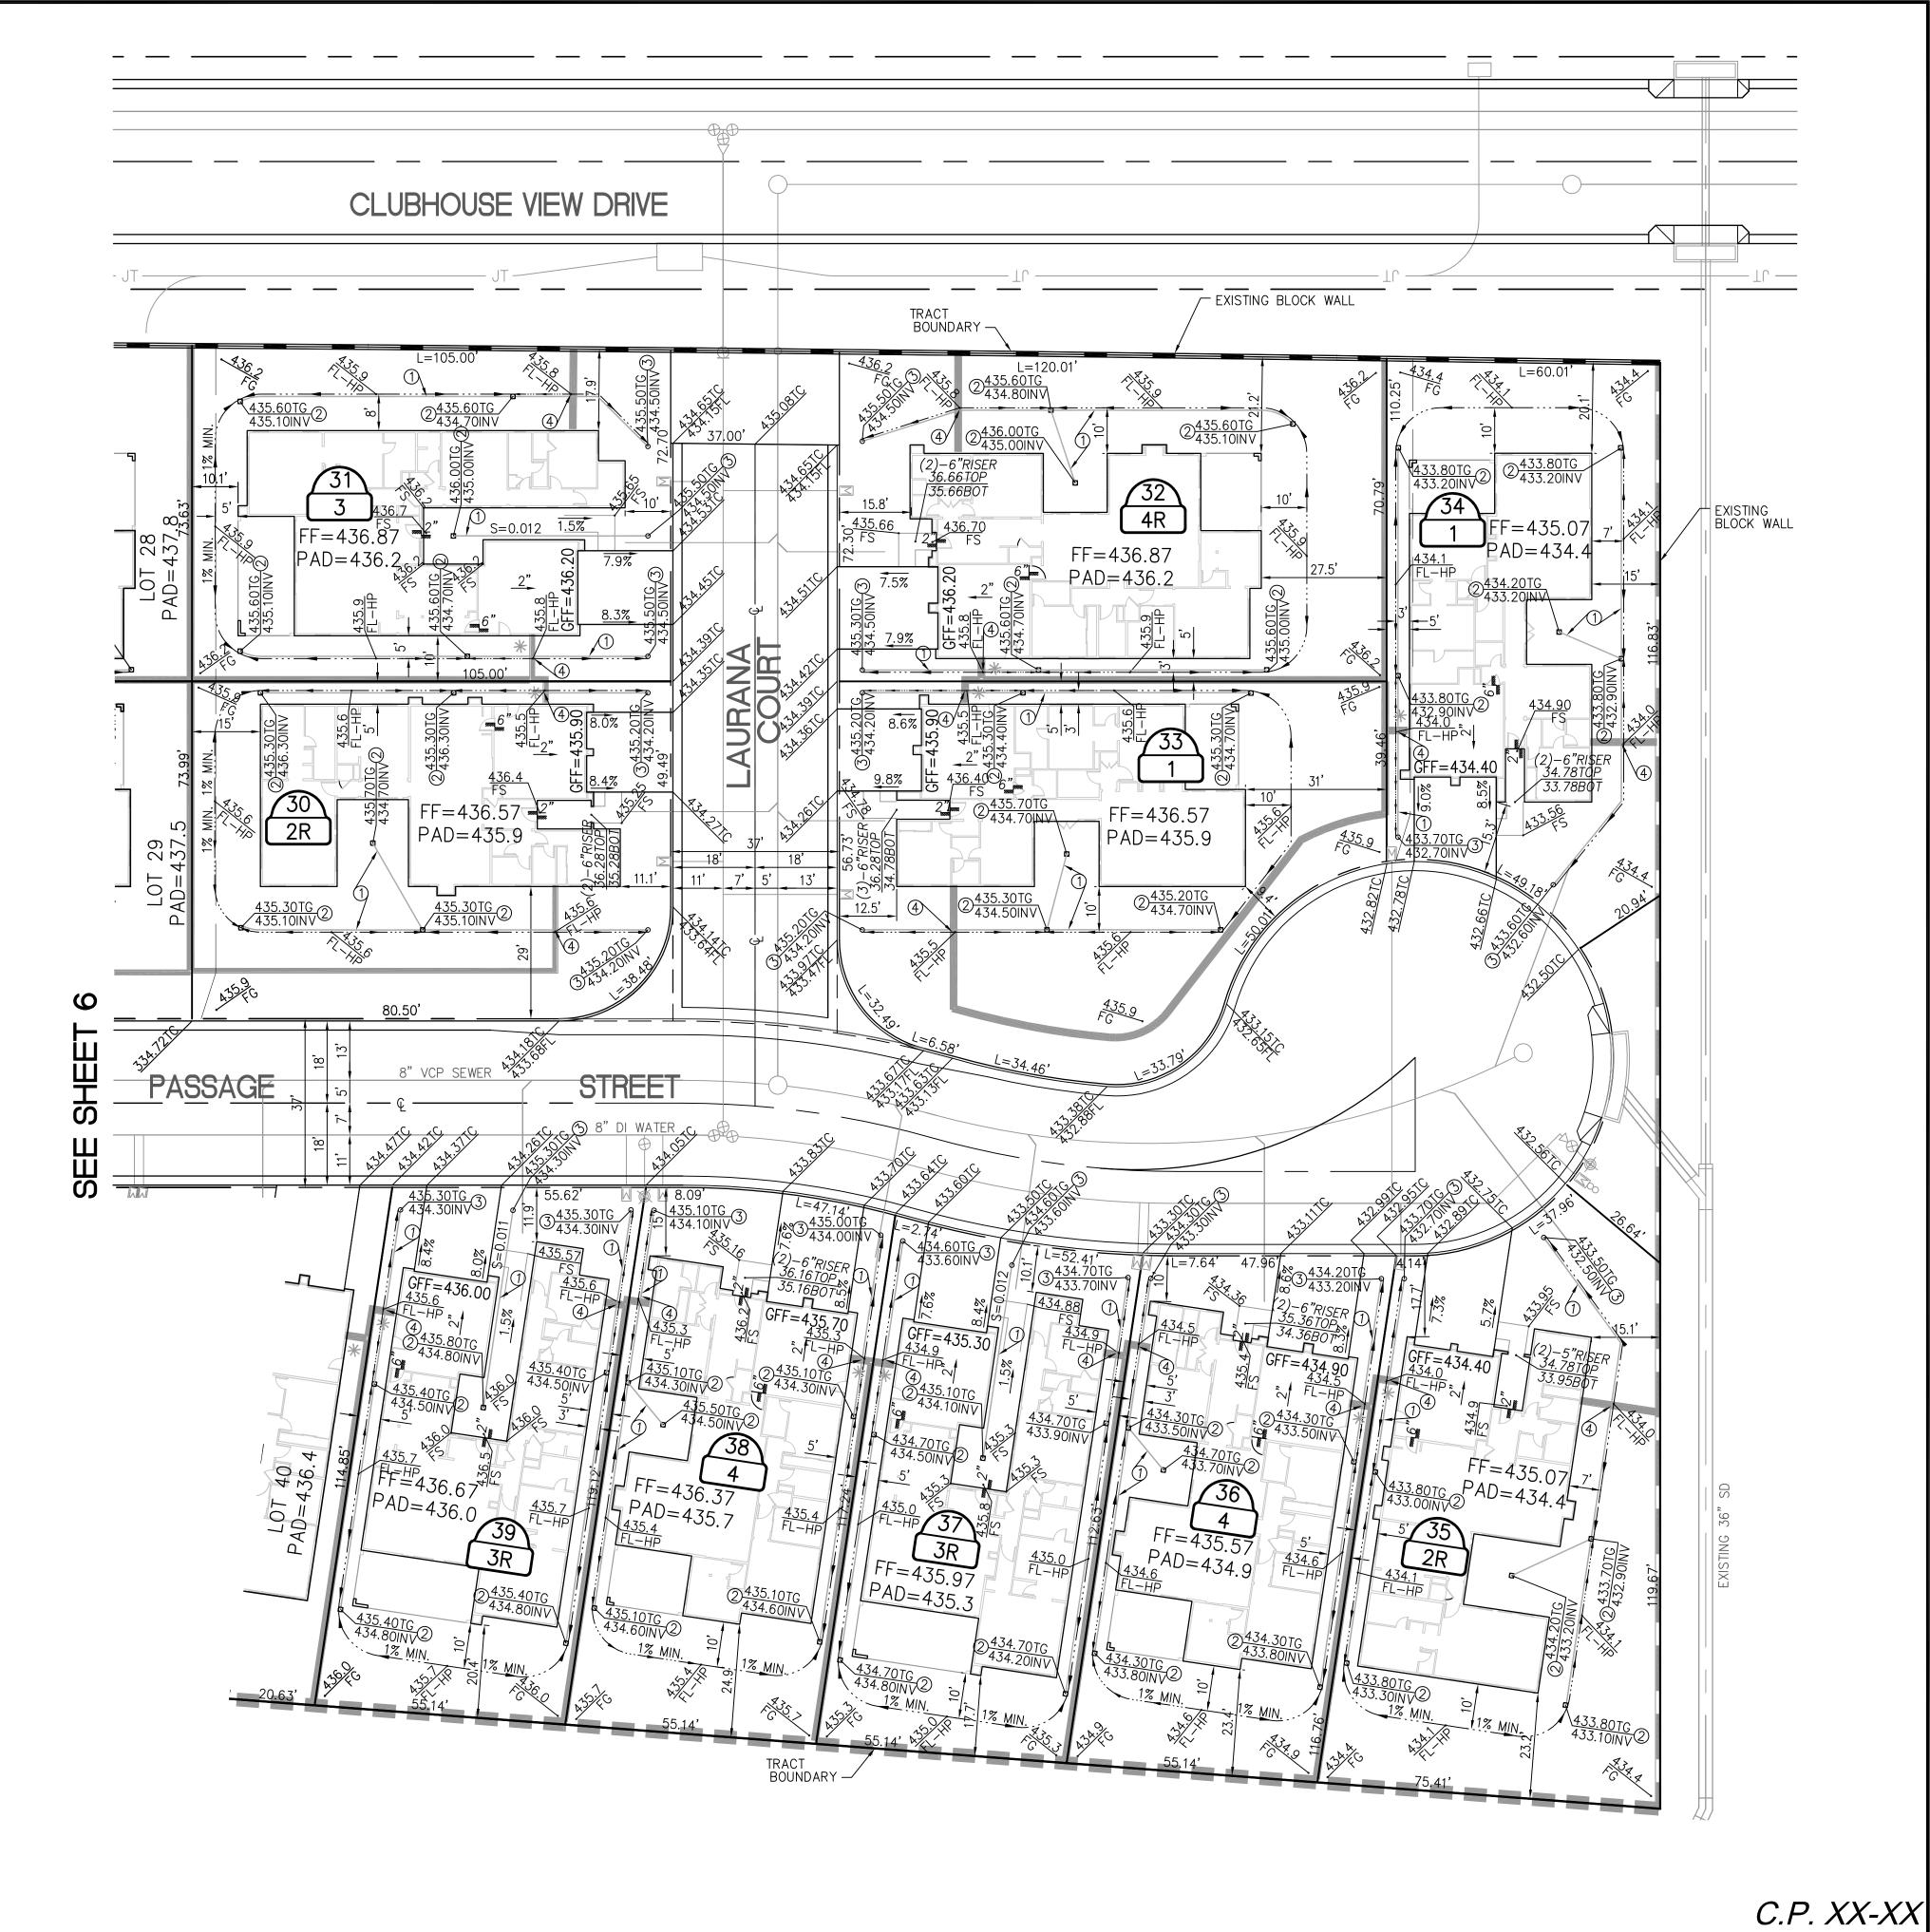



	TWO WORKING DAYS BEFORE YOU DIG															
NO.	REVISION	APPROVED	DATE	BENCH MARK 111	ELEV. 445.98	PREPARED UNDER TH	IE DIRECT SUPERVISION OF:	DESIGN BY:	CITY CHECK	RIGHT-OF- INITIAL DATE WAY	PREPARED BY:		APPROVED BY:		CITY OF PALM SPRINGS, CALIFORNIA	FILE NO.
				LOCATION ADDROVIMATELY 40 FEET SOLITHEASTE	DIV OF THE SOUTHEASTERIY CORNER OF		City of Palm Springs	DRAWN BY:		TRAFFIC ENG'G	1				PRECISE GRADING PLAN	DWG. NO.
				BRIDGE OVER THE WHITEWATER RIVER CONCRETE SLOPE PAVING EASTERLY SI CHINO.	ON VISTA CHINO. IN THE TOP OF THE SIDE OF RIVER SOUTHERLY OF VISTA		Department	REVIEWED BY:	DATE	FIELD	ASSISTANT CIT	TY ENGINEER DATE	R.C.E. NO.	DATE	LOTS 30-39	CADD FILE NAME
						1FORN	·	NS NS		ENG'G •						XX-XX-XX