

ARCHITECTURAL REVIEW COMMITTEE MEMORANDUM

DATE: September 20, 2021

CONSENT

SUBJECT: VALLE VISTA, LLC, OWNER, REQUESTING A MAJOR ARCHITECTURAL APPLICATION TO CONSTRUCT A NEW 2,728-SQUARE FOOT SINGLE-FAMILY RESIDENCE, LOCATED AT 2200 NORTH SUNRISE WAY, ZONE R-1-C, (CASE 3.4283 MAJ). (AP)

FROM: Development Services Department – Planning Division

PROJECT DESCRIPTION:

This is a request for the Architectural Review Committee to review a Major Architectural application for a new 2,728-square foot single-family residence, which includes a pool, spa and new landscaping, at the corner of North Sunrise Way and Via Escuela. The proposed single-family home will have three bedrooms, and a 2-car garage that will take access from Via Escuela. The Palm Springs Zoning Code (PSZC) Section 94.04.00 (E)(1)(a) requires architectural review for single-family residences located on major thoroughfares.

RECOMMENDATION:

That the Architectural Review Committee approve the application as submitted.

BUSINESS PRINCIPAL DISCLOSURE:

The applicant has filed a Public Integrity Disclosure form stating that Jeffrey O Lyon and Christina M. Gomez are the sole members. The Public Integrity Disclosure form is included as an attachment to this report.

BACKGROUND INFORMATION:

Neighbo	orhood	Meeting/Neighborhood Notice
09/16/2	2021	The surrounding neighborhood organizations within a mile of the site were sent notice that the proposed project would be reviewed by the Architectural Review Committee on 09/20/2021.

STAFF ANALYSIS:

Site Area	
Net Acres	0.42 Acres

General Plan and Zoning Designations		
General Plan Designation	Permitted Density	Compliance
VLDR (Very Low Density Residential)	2.1-4.0 DU/AC	Y
Zoning Designation		
R-1-C		

Development Standards:

Pursuant to PSZC Section 92.01.03, the following development standards apply:

Standard	Required/ Allowed	Provided	Compliance
Min. Setbacks			
 Front (Via Escuela) 	25 Feet	28 Feet	Y
Street Side (N. Sunrise Way)	50 Feet	50 Feet	Y
• Side (Interior)	10 Feet	10 Feet	Y
• Rear	15 Feet	15 Feet	Y
Max. Lot Coverage	35%	19%	Y
Max. Building Height	12 Ft. @ PL, 18	15'-6"	Y
	Ft. Max		
Building Separation	6 Feet	N/A	N/A
Perimeter Wall Height			
North	6 Feet	7 Feet	Y (Existing)
 South 	6 Feet	6 Feet	Y
• East	6'	5'-4"	Y
•West	5 Feet	5 Feet	Y
Parking	2 spaces (covered)	2 spaces	Y

Architectural Review Criteria and Findings:

PSZC Section 94.04.00(E) requires the approval authority to evaluate the application and make findings for conformance to the following criteria:

		Criteria and Findings [PSZC 94.04.00(E)]	Compliance
ſ	1.	The architectural treatment is consistent on all four sides of the	V
		proposed building(s), unless otherwise approved by the ARC;	I

	Criteria and Findings [PSZC 94.04.00(E)]	Compliance
	The proposed residence will have consistent architectural treatment on all sides of the building. The treatment will consist of a silver-gray stucco, with a dark brown trim. All windows are vinyl as well as the folding and sliding glass doors.	
2.	The design of accessory structures, such as carports, cabanas, and similar accessory structures, shall be consistent with the form, materials and colors of the principal building(s), unless otherwise approved by the ARC; Accessory structures are not proposed with this project.	N/A
З.	The façade elements and fenestration are composed in a harmonious manner; The residence will enhance the currently undeveloped property. The facade elements, and the arrangement of windows and doors are composed in a harmonious manner to the main house and surrounding neighborhood. The windows and doors facing Via Escuela and North Sunrise Way will be located behind a 5-foothigh block wall.	Y
4.	The proposed materials are consistent with the context of the site, adjacent buildings, and the desert environment; The proposed materials consist of silver stucco, bronze metal framing, metal overhangs, and foam roofing. The surrounding neighborhood consists of stucco homes. The project is consistent with the context of the site and the desert environment.	Y
5.	The proposed color scheme is appropriate to the desert environment and consistent with the site context; The proposed colors consist of silver-gray stucco, dark bronze framing on the windows and patio glass doors, dark brown on the overhangs and metal gates, a light gray roofing. The proposed color scheme is appropriate to the desert environment.	Y
6.	Shading devices and sun control elements, excluding landscape materials, are provided to address environmental conditions and solar orientation; The residence has several overhangs on all sides, which will aid in providing shade to the home.	Y
7.	The proposed landscape plan is consistent with the requirements of PSMC Chapter 8.60; The project consists of a variety of drought-tolerant vegetation and trees that do not require frequent watering. Decomposed granite and gravel are proposed throughout the site, including along North Sunrise Way and Via Escuela. A small area of grass is proposed around the swimming pool and spa. The proposed landscape plan is consistent with the requirements of the PSZC.	Y

	Criteria and Findings [PSZC 94.04.00(E)]	Compliance
8.	The proposed landscape plan is consistent with all applicable zoning requirements, including any streetscape requirements, landscape buffer requirements, and screening requirements; Where new landscape material is proposed, the landscape plan submitted includes the planting of Palo Verde, Bouganvillea Red Shrub, Yellow Lantana, Mexican Bird of Paradise, Tecoma Stans, Mexican Grass Tree, Agave, Mediterranean Fan Palm, and Russellia, all of which are consistent with the Coachella Valley Lush and Efficient handbook. Additionally, proposed turf is less than the maximum 15% of the total landscaped area.	Y
9.	Screening is provided for mechanical equipment and service yards, so as to screen such facilities from view from public rights- of-way and abutting properties; The applicant is not proposing any mechanical equipment on the roof. The pool equipment will be screened behind the perimeter wall. The proposed two HVAC systems will be located within the side rear property. None of the mechanical equipment will be visible from the public right-of-way.	Y

ENVIRONMENTAL ANALYSIS:

The proposed development is considered a "project" pursuant to the terms of the California Environmental Quality Act ("CEQA") and has been determined to be categorically exempt pursuant to Section 15303(a) of the CEQA Guidelines (Class 3, New Single-Family Residence).


CONCLUSION:

The proposed residence will be an enhancement to the undeveloped parcel. The project complies with the development standards of the R-1-C zone. Staff recommends the ARC approve the application, as submitted.

PREPARED BY:	Alex Perez, Assistant Planner
REVIEWED BY:	David Newell, AICP, Assistant Director of Planning

ATTACHMENTS:

- 1. Vicinity Map
- 2. Draft Resolution
- 3. Conditions of Approval
- 4. Public Integrity Disclosure Form
- 5. Architectural Plans
- 6. Renderings

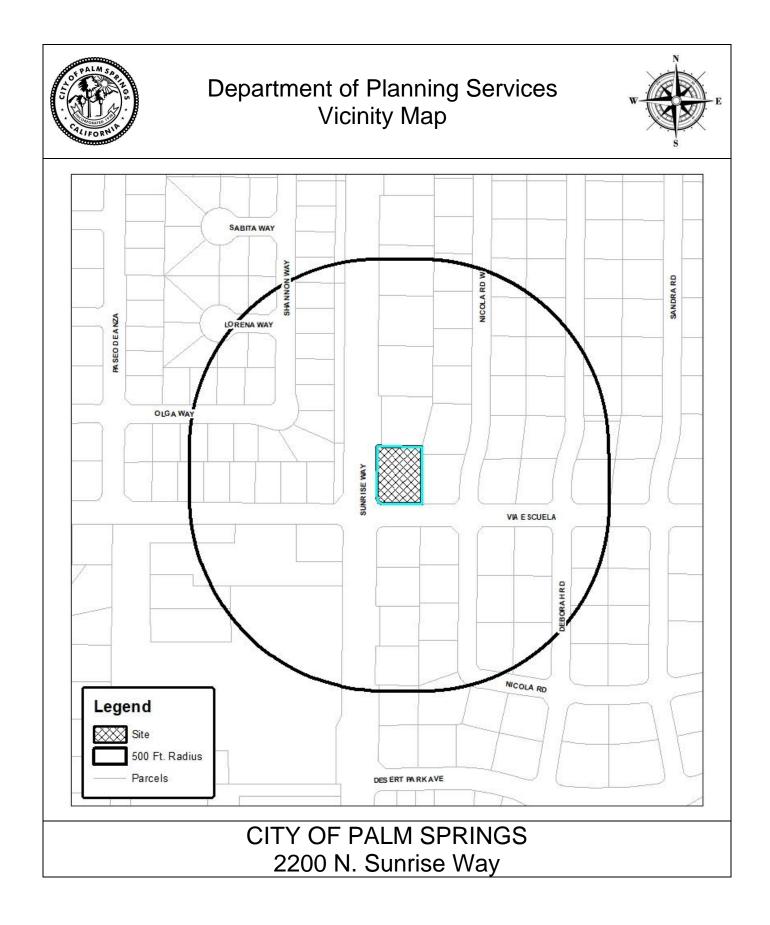

RESOLUTION NO.

A RESOLUTION OF THE ARCHITECTURAL REVIEW COMMITTEE OF THE CITY OF PALM SPRINGS, CALIFORNIA, APPROVING A MAJOR ARCHITECTURAL APPLICATION FOR DEVELOPMENT OF A 2,728-SQUARE FOOT SINGLE FAMILY RESIDENCE ON A MAJOR THOROUGHFARE LOCATED AT 2200 NORTH SUNRISE WAY (CASE 3.4283-MAJ).

THE ARCHITECTURAL REVIEW COMMITTEE FINDS AND DETERMINES AS FOLLOWS:

A. Valle Vista, LLC, Owner ("Applicant") filed an application with the City, pursuant to the Palm Springs Zoning Code (PSZC) Section 94.04.00 (architectural review) of the Palm Springs Zoning Code, for construction of a 2,728-square foot single family residence located at 2200 North Sunrise Way ("the Project").

B. On April 8, 2021, the City Council adopted Ordinance No. 2042, amending Section 94.04.00 of the PSZC to reassign review of Major Architectural Review (MAJ) applications from the City's Planning Commission to the City's Architectural Review Committee.

C. On September 20, 2021, the City's Architectural Review Committee held a public meeting in accordance with applicable public law. At said meeting, the Architectural Review Committee carefully reviewed and considered all of the evidence presented in connection with the Project, including, but not limited to, the staff report, and all written and oral testimony presented.

THE ARCHITECTURAL REVIEW COMMITTEE RESOLVES:

<u>Section 1</u>: The proposed single-family residence is considered a project pursuant to the California Environmental Quality Act (CEQA). The Architectural Review Committee has evaluated the Project pursuant to CEQA and determined it to be Categorically Exempt from further analysis under CEQA Guidelines Section 15303(a) (Class 3, New Construction or Conversion of Small Structures).

<u>Section 2:</u> As demonstrated in the staff report, the Project conforms to the Architectural Guidelines of PSZC Section 94.04.00 ("architectural review").

<u>Section 3:</u> Based upon the foregoing, the Architectural Review Committee hereby approves Case 3.4283 MAJ, for the construction of a 2,728-square foot single-family residence on a major thoroughfare located at 2200 North Sunrise Way, subject to the conditions of approval attached herein as Exhibit A.

ADOPTED this 20th day of SEPTEMBER 2021.

AYES: NOES: Architectural Review Committee Resolution No. _____ Case 3.4283 MAJ – 2200 North Sunrise Way

ABSENT:

ATTEST:

CITY OF PALM SPRINGS, CALIFORNIA

David Newell, AICP Assistant Planning Director

CONDITIONS OF APPROVAL

Case 3.4283 MAJ Proposed Single Family Residence. Located at 2200 N. Sunrise Way R-1-C Zone

September 20, 2021

CONDITIONS OF APPROVAL

Before final acceptance of the project, all conditions listed below shall be completed to the satisfaction of the City Engineer, the Director of Planning Services, the Director of Building and Safety, the Chief of Police, the Fire Chief or their designee, depending on which department recommended the condition.

Any agreements, easements or covenants required to be entered into shall be in a form approved by the City Attorney.

ADMINISTRATIVE CONDITIONS

- ADM 1. <u>Project Description</u>. This approval is for the project described per Case (3.4283 MAJ).
- ADM 2. <u>Reference Documents</u>. The site shall be developed and maintained in accordance with the approved plans, date stamped (August 24, 2021), including site plans, architectural elevations, exterior materials and colors, landscaping, and grading on file in the Planning Division except as modified by the approved Mitigation Measures and conditions below.
- ADM 3. <u>Conform to all Codes and Regulations</u>. The project shall conform to the conditions contained herein, all applicable regulations of the Palm Springs Zoning Ordinance, Municipal Code, and any other City County, State and Federal Codes, ordinances, resolutions and laws that may apply.
- ADM 4. <u>Minor Deviations</u>. The Director of Planning or designee may approve minor deviations to the project description and approved plans in accordance with the provisions of the Palm Springs Zoning Code.
- ADM 5. <u>Indemnification</u>. The owner shall defend, indemnify, and hold harmless the City of Palm Springs, its agents, officers, and employees from any claim, action, or proceeding against the City of Palm Springs or its agents, officers or employees to attach, set aside, void or annul, an approval of the City of Palm Springs, its legislative body, advisory agencies, or administrative officers concerning Case 3.4283 MAJ. The City of Palm Springs will promptly

notify the applicant of any such claim, action, or proceeding against the City of Palm Springs and the applicant will either undertake defense of the matter and pay the City's associated legal costs or will advance funds to pay for defense of the matter by the City Attorney. If the City of Palm Springs fails to promptly notify the applicant of any such claim, action or proceeding or fails to cooperate fully in the defense, the applicant shall not, thereafter, be responsible to defend, indemnify, or hold harmless the City of Palm Springs. Notwithstanding the foregoing, the City retains the right to settle or abandon the matter without the applicant's consent but should it do so, the City shall waive the indemnification herein, except, the City's decision to settle or abandon a matter following an adverse judgment or failure to appeal, shall not cause a waiver of the indemnification rights herein.

- ADM 6. <u>Maintenance and Repair</u>. The property owner(s) and successors and assignees in interest shall maintain and repair the improvements including and without limitation all structures, sidewalks, bikeways, parking areas, landscape, irrigation, lighting, signs, walls, and fences between the curb and property line, including sidewalk or bikeway easement areas that extend onto private property, in a first class condition, free from waste and debris, and in accordance with all applicable law, rules, ordinances and regulations of all federal, state, and local bodies and agencies having jurisdiction at the property owner's sole expense. This condition shall be included in the recorded covenant agreement for the property if required by the City.
- ADM 7. <u>Time Limit on Approval</u>. Approval of the Major Architectural Approval shall be valid for a period of two (2) years from the effective date of the approval. Extensions of time may be granted by the Planning Commission upon demonstration of good cause.
- ADM 8. <u>Right to Appeal</u>. Decisions of an administrative officer or agency of the City of Palm Springs may be appealed in accordance with Municipal Code Chapter 2.05.00. Permits will not be issued until the appeal period has concluded.

ENVIRONMENTAL ASSESSMENT CONDITIONS

- ENV 1. <u>Coachella Valley Multiple-Species Habitat Conservation Plan (CVMSHCP)</u> <u>Local Development Mitigation Fee (LDMF) required</u>. All projects within the City of Palm Springs, not within the Agua Caliente Band of Cahuilla Indians reservation are subject to payment of the CVMSHCP LDMF prior to the issuance of certificate of occupancy.
- ENV 2. <u>Notice of Exemption</u>. The project is exempt from the California Environmental Quality Act (CEQA); therefore, an administrative fee of \$50 shall be submitted by the applicant in the form of a money order or a cashier's check payable to

the Riverside County Clerk within two business days of the Commission's final action on the project. This fee shall be submitted by the City to the County Clerk with the Notice of Exemption. Action on this application shall not be considered final until such fee is paid (projects that are Categorically Exempt from CEQA).

PLANNING DEPARTMENT CONDITIONS

- PLN 1. Architectural Review Committee changes: N/A.
- PLN 2. <u>Outdoor Lighting Conformance</u>. Exterior lighting plans, including a photometric site plan showing the project's conformance with Section 93.21.00 Outdoor Lighting Standards of the Palm Springs Zoning ordinance, shall be submitted for approval by the Department of Planning prior to issuance of a building permit. Manufacturer's cut sheets of all exterior lighting on the building and in the landscaping shall be included. If lights are proposed to be mounted on buildings, down-lights shall be utilized. No lighting of hillsides is permitted.
- PLN 3. <u>Water Efficient Landscaping Conformance</u>. The project is subject to the Water Efficient Landscape Ordinance (Chapter 8.60.00) of the Palm Springs Municipal Code and all other water efficient landscape ordinances. The applicant shall submit a landscape and irrigation plan to the Director of Planning for review and approval prior to the issuance of a building permit. Landscape plans shall be wet stamped and approved by the Riverside County Agricultural Commissioner's Office prior to submittal. Prior to submittal to the City, landscape plans shall also be certified by the local water agency that they are in conformance with the water agency's and the State's Water Efficient Landscape Ordinances.
- PLN 4. <u>Flat Roof Requirements</u>. Roof materials on flat roofs (less than 2:12) must conform to California Title 24 thermal standards for "Cool Roofs". Such roofs must have a minimum initial thermal emittance of 0.75 or a minimum SRI of 64 and a three-year aged solar reflectance of 0.55 or greater. Only matte (non-specular) roofing is allowed in colors such as beige or tan.
- PLN 5. <u>Maintenance of Awnings & Projections</u>. All awnings shall be maintained and periodically cleaned.
- PLN 6. <u>Screen Roof-mounted Equipment</u>. All roof mounted mechanical equipment shall be screened per the requirements of Section 93.03.00 of the Zoning Ordinance.

- PLN 7. <u>Surface Mounted Downspouts Prohibited</u>. No exterior downspouts shall be permitted on any facade on the proposed building(s) that are visible from adjacent streets or residential and commercial areas.
- PLN 8. <u>Pool Enclosure Approval Required</u>. Details of fencing or walls around pools (material and color) and pool equipment areas shall be submitted for approval by the Planning Department prior to issuance of Building Permits.
- PLN 9. <u>Exterior Alarms & Audio Systems</u>. No sirens, outside paging or any type of signalization will be permitted, except approved alarm systems.
- PLN 10. <u>Outside Storage Prohibited</u>. No outside storage of any kind shall be permitted except as approved as a part of the proposed plan.
- PLN 11. <u>No off-site Parking</u>. Vehicles associated with the operation of the proposed development including company vehicles or employees vehicles shall not be permitted to park off the proposed building site unless a parking management plan has been approved.
- PLN 12. <u>Pad Elevations</u>. Final building pad elevations shall not vary more than 12 inches above or below the pad elevation established by the approved preliminary grading plan and / or tentative map. Any deviations from this provision shall require approval by the Planning Commission.

BUILDING DEPARTMENT CONDITIONS

BLD 1. Prior to any construction on-site, all appropriate permits must be secured.

ENGINEERING CONDITIONS

The Engineering Services Department recommends that if this application is approved, such approval is subject to the following conditions being completed in compliance with City standards and ordinances.

Before final acceptance of the project, all conditions listed below shall be completed to the satisfaction of the City Engineer.

All Grading Plans, Improvement Plans, Required Studies and Documents listed below, must be submitted to Engineering Services Department for review and approval.

STREETS

- ENG 1. The Engineering Services Department recommends deferral of off-site improvement items (identified as "*Deferred*") at this time due to lack of full improvements in the immediate area. The owner shall execute a street improvement covenant agreeing to construct all required street improvements upon the request of the City of Palm Springs City Engineer at such time as deemed necessary. The covenant shall be executed and notarized by the property owner(s) prior to approval of the Grading Plan or issuance of grading or building permits. A current title report; or a copy of a current tax bill and a copy of a vesting grant deed shall be provided to verify current property ownership. <u>A covenant preparation fee in effect at the time that the covenant is submitted shall be paid by the applicant prior to issuance of any grading or building permits.</u>
- ENG 2. Any improvements within the public right-of-way require a City of Palm Springs Encroachment Permit. All improvements are subject to inspection and a 48-hour inspection notification is required.
- ENG 3. Submit street improvement plans prepared by a registered California civil engineer to the Engineering Services Department. The plan(s) shall be approved by the City Engineer prior to issuance of any building permits. *Deferred.*
- ENG 4. **Provide proposed finish floor elevations of all proposed structures,** existing structures on site, and all adjacent off-site structures. This information required prior to site plan approval.

SUNRISE WAY

- ENG 5. Dedicate an additional 10 feet to provide the ultimate half street right-ofway width of 50 feet along the entire frontage, together with a property line - corner cut-back at the northeastern corner of the intersection of Sunrise Way and Via Escuela, in accordance with City of Palm Springs Standard Drawing No. 105. A current title report; or a copy of a current tax bill and a copy of a vesting grant deed shall be provided to verify current property ownership. <u>A right-of-way plan check fee shall be paid by the applicant in effect at the time that the dedication is submitted.</u>
- ENG 6. Remove the existing 6 inch curb and gutter located 32 feet east of centerline and replace with a 6 inch curb and gutter located 38 feet east of centerline along the entire frontage, with a 35 feet radius curb return at the northeast corner of the intersection of Sunrise Way and Via Escuela in

accordance with City of Palm Springs Standard Drawing No. 200, 206, and 340. (Future) *Deferred.*

- ENG 7. Construct the north half of a 8 feet wide cross gutter and spandrel at the northeast corner of the intersection of Sunrise Way and Via Escuela with a flow line parallel with and located 38 feet east of the centerline of Sunrise Way in accordance with City of Palm Springs Standard Drawing No. 200 and 206. (Future) **Deferred.**
- ENG 8. Construct a 5 feet wide sidewalk behind the existing curb along the entire frontage in accordance with City of Palm Springs Standard Drawing No. 210.
- ENG 9. Construct a future 5 feet wide sidewalk behind the future curb along the entire frontage in accordance with City of Palm Springs Standard Drawing No. 210. *Deferred.*
- ENG 10. Remove and replace the existing curb ramp at the northeast corner of Sunrise Way and Via Escuela, upon review and a determination by the City Engineer that the existing curb ramp does not meet current ADA standards. If required, construct a Type-A curb ramp meeting current California State Accessibility standards in accordance with City of Palm Springs Standard Drawing No. 212. **Deferred.**
- ENG 11. Construct pavement with a minimum pavement section of 5 inches asphalt concrete pavement over 4 inches crushed miscellaneous base with a minimum subgrade of 24 inches at 95% relative compaction, or equal, from edge of proposed gutter to clean sawcut edge of pavement along the entire frontage in accordance with City of Palm Springs Standard Drawing No. 110 and 340. (Additional pavement removal and replacement may be required upon review of existing pavement cross-sections, and to ensure grade breaks of the pavement cross-section do not occur within a travel lane.) If an alternative pavement section is proposed, the proposed pavement section shall be designed by a California registered Geotechnical Engineer using "R" values from the project site and submitted to the City Engineer for approval. (Future) **Deferred.**
- ENG 12. Remove and replace existing asphalt concrete pavement where required, in accordance with applicable City standards.
- ENG 13. All broken or off grade street improvements along the project frontage shall be repaired or replaced.

VIA ESCUELA

- ENG 14. Remove the existing roll curb located 18 feet north of centerline and replace with a 6 inch curb and gutter located 20 feet north of centerline along the entire frontage, in accordance with City of Palm Springs Standard Drawing No. 200, 206, and 315. (Future) **Deferred.**
- ENG 15. Construct a driveway approach in accordance with City of Palm Springs Standard Drawing No. 201.
- ENG 16. Construct a future driveway approach in accordance with City of Palm Springs Standard Drawing No. 201. *Deferred.*
- ENG 17. Construct a 5 feet wide sidewalk behind the existing curb along the entire frontage in accordance with City of Palm Springs Standard Drawing No. 210.
- ENG 18. Construct a future 5 feet wide sidewalk behind the future curb along the entire frontage in accordance with City of Palm Springs Standard Drawing No. 210. *Deferred.*
- ENG 19. Construct pavement with a minimum pavement section of 3 inches asphalt concrete pavement over 6 inches crushed miscellaneous base with a minimum subgrade of 24 inches at 95% relative compaction, or equal, from edge of proposed gutter to clean sawcut edge of pavement along the entire frontage in accordance with City of Palm Springs Standard Drawing No. 110 and 315. (Additional pavement removal and replacement may be required upon review of existing pavement cross-sections, and to ensure grade breaks of the pavement cross-section do not occur within a travel lane.) If an alternative pavement section is proposed, the proposed pavement section shall be designed by a California registered Geotechnical Engineer using "R" values from the project site and submitted to the City Engineer for approval. (Future) **Deferred.**
- ENG 20. Remove and replace existing asphalt concrete pavement where required, in accordance with applicable City standards.
- ENG 21. All broken or off grade street improvements along the project frontage shall be repaired or replaced.

SANITARY SEWER

ENG 22. All sanitary facilities shall be connected to the public sewer system. New laterals shall not be connected at manholes.

GRADING

ENG 23. Submit cut and fill quantities to City Engineer to determine if a Grading Plan is required. If required, the Grading Plan shall be submitted to the Engineering Services Department for review and approval by the City Engineer prior to issuance of grading permit. If the earthwork quantity is less than 50 cubic yards, a formal grading plan is not required. To qualify for the exemption, a signed original written statement of design earthwork quantities from the owner (or design professional, prepared on company letterhead) shall be provided to the Engineering Services Department. Exemption of a formal Grading Plan reviewed and approved by the City Engineer does not exempt the applicant from a site grading plan that may be required from the Building Department, or any other requirement that may be necessary to satisfy the California Building Code.

Fugitive Dust Control Plan shall be prepared by the applicant a. and/or its grading contractor and submitted to the Engineering Services Department for review and approval. The applicant and/or its grading contractor shall be required to comply with Chapter 8.50 of the City of Palm Springs Municipal Code, and shall be required to utilize one or more "Coachella Valley Best Available Control Measures" as identified in the Coachella Valley Fugitive Dust Control Handbook for each fugitive dust source such that the applicable performance standards are met. The applicant's or its contractor's Fugitive Dust Control Plan shall be prepared by staff that has completed the South Coast Air Quality Management District (AQMD) Coachella Valley Fugitive Dust Control Class. The applicant and/or its grading contractor shall provide the Engineering Services Department with current and valid Certificate(s) of Completion from AQMD for staff that have completed the required training. information on attending a Fugitive Dust Control Class and information on the Coachella Valley Fugitive Dust Control Handbook and related "PM10" Dust Control issues, please contact AQMD at (909) 396-3752, or at http://www.AQMD.gov. A Fugitive Dust Control Plan. in conformance with the Coachella Valley Fugitive Dust Control Handbook, shall be submitted to and approved by the Engineering Services Department prior to approval of the Grading plan.

b. The first submittal of the Grading Plan shall include the following information: a copy of final approved conformed copy of Conditions of Approval; a copy of a final approved conformed copy of the Site Plan; a copy of current Title Report; and a copy of Soils Report.

- ENG 24. Prior to approval of a Grading Plan (or issuance of a Grading Permit), the applicant shall obtain written approval to proceed with construction from the Agua Caliente Band of Cahuilla Indians, Tribal Historic Preservation Officer or Tribal Archaeologist (a copy of the written approval must be provided to the City). The applicant shall contact the Tribal Historic Preservation Officer the Tribal Archaeologist or at ACBCI-THPO@aguacaliente.net to determine their requirements, if anv. associated with grading or other construction. The applicant is advised to contact the Tribal Historic Preservation Officer or Tribal Archaeologist as early as possible. If required, it is the responsibility of the applicant to coordinate scheduling of Tribal monitors during grading or other construction, and to arrange payment of any required fees associated with Tribal monitoring.
- ENG 25. In accordance with an approved PM-10 Dust Control Plan, temporary dust control perimeter fencing shall be installed. Fencing shall have screening that is tan in color; green screening will not be allowed. Temporary dust control perimeter fencing shall be installed prior to issuance of Grading Permit and commencement of grading operations.
- ENG 26. Temporary dust control perimeter fence screening shall be appropriately maintained, as required by the City Engineer. Cuts (vents) made into the perimeter fence screening <u>shall not be allowed</u>. Perimeter fencing shall be adequately anchored into the ground to resist wind loading.
- ENG 27. Within 10 days of ceasing all construction activity and when construction activities are not scheduled to occur for at least 30 days, the disturbed areas on-site shall be permanently stabilized, in accordance with Palm Springs Municipal Code Section 8.50.022. Following stabilization of all disturbed areas, perimeter fencing shall be removed, as required by the City Engineer.
- ENG 28. Drainage swales shall be provided adjacent to all curbs and sidewalks to keep nuisance water from entering the public streets, roadways, or gutters.
- ENG 29. In accordance with City of Palm Springs Municipal Code, Section 8.50.022 (h), the applicant shall post with the City a cash bond of eight hundred dollars (\$800) (if there is disturbance of 5,000 square feet or more) at the time of issuance of grading permit for mitigation measures for erosion/blowsand relating to this property and development.

- ENG 30. A Geotechnical/Soils Report prepared by a California registered Geotechnical Engineer shall be required for and incorporated as an integral part of the grading plan for the proposed development. A copy of the Geotechnical/Soils Report shall be submitted to the Engineering Services Department with the first submittal of a grading plan. (if required)
- ENG 31. The applicant shall provide all necessary geotechnical/soils inspections and testing in accordance with the Geotechnical/Soils Report prepared for the project. All backfill, compaction, and other earthwork shown on the approved grading plan shall be certified by a California registered geotechnical or civil engineer, certifying that all grading was performed in accordance with the Geotechnical/Soils Report prepared for the project. Documentation of all compaction and other soils testing are to be provided <u>even though there may not be a grading plan for the</u> project. Prior to issuance of Building Permits.
- ENG 32. The applicant shall provide Grading Certification for all building (or structure) pads in conformance with the approved grading plan (if required), to the Engineering Services Department for review and approval.
- ENG 33. In cooperation with the California Agricultural Commissioner and the California Department of Food and Agriculture Red Imported Fire Ant Project, applicants for grading permits involving a grading plan and involving the export of soil will be required to present a clearance document from a Department of Food and Agriculture representative in the form of an approved "Notification of Intent To Move Soil From or Within Quarantined Areas of Orange, Riverside, and Los Angeles Counties" (Revised RIFA Form CA-1) prior to approval of the Grading Plan (if required). The California Department of Food and Agriculture office is located at 6819 East Gage Avenue, Commerce, CA 90040 (Phone (760) 782-3271, (562) 505-6415), Sonia.Oran@cdfa.ca.gov.

DRAINAGE

- ENG 34. All stormwater runoff across the property shall be accepted and conveyed in a manner acceptable to the City Engineer and released to an approved drainage system. Stormwater runoff may not be released directly to the adjacent streets without first intercepting and treating with approved Best Management Practices (BMPs).
- ENG 35. The project is subject to flood control and drainage implementation fees. The acreage drainage fee at the present time is \$7,287.76 per acre in accordance with Resolution No. 15189. Fees shall be paid prior to issuance of a building permit.

GENERAL

- ENG 36. Any utility trenches or other excavations within existing asphalt concrete pavement of off-site streets required by the proposed development shall be backfilled and repaired in accordance with City of Palm Springs Standard Drawing No. 115.
- ENG 37. All proposed utility lines shall be installed underground.
- ENG 38. The record property owner shall enter into a covenant agreeing to underground all of the existing overhead utilities required by the Municipal Code in the future upon request of the City of Palm Springs City Engineer at such time as deemed necessary. The covenant shall be executed and notarized by the property owner and submitted to the City Engineer prior to issuance of a grading permit. A current title report or a copy of a current tax bill and a copy of a vesting grant deed shall be provided to verify current property ownership. A covenant preparation fee in effect at the time that the covenant is submitted shall be paid by the applicant prior to issuance of any grading or building permits.
- ENG 39. All existing utilities shall be shown on the improvement plans if required for the project. The existing and proposed service laterals shall be shown from the main line to the property line.
- ENG 40. Upon approval of any improvement plan (if required) by the City Engineer, the improvement plan shall be provided to the City in digital format, consisting of a DWG (AutoCAD 2004 drawing file), DXF (AutoCAD ASCII drawing exchange file), and PDF (Adobe Acrobat 6.0 or greater) formats. Variation of the type and format of the digital data to be submitted to the City may be authorized, upon prior approval by the City Engineer.
- ENG 41. The original improvement plans prepared for the proposed development and approved by the City Engineer (if required) shall be documented with record drawing "as-built" information and returned to the Engineering Services Department prior to issuance of a final certificate of occupancy. Any modifications or changes to approved improvement plans shall be submitted to the City Engineer for approval prior to construction.

- ENG 42. Nothing shall be constructed or planted in the corner cut-off area of any intersection or driveway which does or will exceed the height required to maintain an appropriate sight distance per City of Palm Springs Zoning Code Section 93.02.00, D.
- ENG 43. All proposed trees within the public right-of-way and within 10 feet of the public sidewalk and/or curb shall have City approved deep root barriers installed in accordance with City of Palm Springs Standard Drawing No. 904.
- ENG 44. This property is subject to the Coachella Valley Multiple Species Habitat Conservation Plan Local Development Mitigation Fee (CVMSHCP-LDMF). The LDMF shall be paid prior to issuance of Building Permit.

TRAFFIC

- ENG 45. All damaged, destroyed, or modified pavement legends, traffic control devices, signing, striping, and streetlights, associated with the proposed development shall be replaced as required by the City Engineer prior to issuance of a Certificate of Occupancy.
- ENG 46. Relocate and modify the existing traffic signal poles, conduit, pull boxes and all appurtenances located on the northeast corner of Sunrise Way and Via Escuela in accordance with the requirements of the City of Palm Springs. The applicant shall submit traffic signal modification plans prepared by a California registered civil engineer or traffic engineer for review and approval by the City Engineer. The traffic signal shall be installed and operational prior to issuance of the Certificate of Occupancy, unless otherwise allowed by the City Engineer. (Future) **Deferred.**
- ENG 47. Relocate the existing street name sign at the northeastern corner of Sunrise Way and Via Escuela in accordance with City of Palm Springs Standard Drawing No. 622 and 624.
- ENG 48. Construction signing, lighting and barricading shall be provided during all phases of construction as required by City Standards or as directed by the City Engineer. As a minimum, all construction signing, lighting and barricading shall be in accordance with Part 6 "Temporary Traffic Control" of the California Manual on Uniform Traffic Control Devices (CAMUTCD), dated November 7, 2014, or subsequent editions in force at the time of construction.
- ENG 49. This property is subject to the Transportation Uniform Mitigation Fee which shall be paid prior to issuance of building permit.

FIRE DEPARTMENT CONDITIONS

- FID 1. These Fire Department conditions may not provide all requirements. Owner/developer is responsible for all applicable state and locally adopted fire codes. Detailed plans are still required for review. Conditions are subject to final plan check and review.
- FID 2. Fire Department Conditions were based on the 2019 California Fire Code as adopted by City of Palm Springs, Palm Springs Municipal Code, PSFD Appendix "T" Development Requirements. This building will require fire sprinklers.
- FID 3. **Conditions of Approval** "Conditions of Approval" received from the Palm Springs Planning Department must be submitted with each plan set. Failure to submit will result in a delay of plan approval.

FID 4. Plans and Permits (CFC 105.1):

Permits and scaled drawings are required for this project. Plan reviews can take up to 20 working days. Submit a minimum of three (3) sets of drawings for review. Upon approval, the Fire Prevention Bureau will retain one set. Plans shall be submitted to:

City of Palm Springs Building and Safety Department 3200 E. Tahquitz Canyon Way Palm Springs, CA 92262

Counter Hours: 8:00 AM – 6:00 PM, Monday – Thursday

A deposit for Plan Check and Inspection Fees is required at the time of Plan Submittal. These fees are established by Resolution of the Palm Springs City Council.

Complete listings and manufacturer's technical data sheets for all system materials shall be included with plan submittals. All system materials shall be UL listed or FM approved for fire protection service and approved by the Fire Prevention Bureau prior to installation.

Plans shall include all necessary engineering features, including all hydraulic reference nodes, pipe lengths and pipe diameters as required by the appropriate codes and standards. Plans and supporting data, (calculations and manufacturers technical data sheets) including fire flow data, shall be

submitted with each plan submittal. Complete and accurate legends for all symbols and abbreviations shall be provided on the plans.

- FID 5. Access During Construction (CFC 503): Access for firefighting equipment shall be provided to the immediate job site at the start of construction and maintained until all construction is complete. Fire apparatus access roads shall have an unobstructed width of not less than 24 feet and an unobstructed vertical clearance of not less than 13'-6". Fire Department access roads shall have an all-weather driving surface and support a minimum weight of 73,000 lbs.
- FID 6. **Required access (CFC 504.1):** Exterior doors and openings required by this code or the California Building Code shall be maintained readily accessible for emergency access by the fire department. An approved access walkway leading from fire apparatus access roads to exterior openings shall be provided when required by the fire code official.
- FID 7. NFPA 13D Fire Sprinklers Required: An automatic fire sprinkler system is required. Only a C-16 licensed fire sprinkler contractor shall perform system design and installation. System to be designed and installed in accordance with NFPA standard 13D, 2016 Editions, as modified by local ordinance.
- FID 8. **Residential Smoke Alarms Required:** Shall be interconnected so that operation of any smoke alarm or fire sprinkler flow switch causes all smoke alarms within the dwelling & guest house to sound and activate the exterior horn/strobe
- FID 9. **Carbon Monoxide Detector**: Shall be installed in location as stated in California Fire Code Section 915
- FID 11. Provide planting list associated with the landscape plan.

END OF CONDITIONS



PUBLIC INTEGRITY DISCLOSURE APPLICANT DISCLOSURE FORM

1. Name of Entity	
VALLE VISTA, LLC	
2. Address of Entity (Principle Place of Busin	ess)
780 Nonth 4th STREE	T ELCENTRO, CA 92243
3. Local or California Address (if different the	an #2)
4. State where Entity is Registered with Secr	etary of State
CALIFORNIA	
	the Entity also registered in California? 🗌 Yes 🗌 No
5. Type of Entity	
Corporation Limited Liability Company	artnership 🔲 Trust 🗌 Other (please specify)
Note: If any response is not a natural	, Trustees, Other Fiduciaries (please specify) person, please identify all officers, directors, for the member, manager, trust or other entity
Jeffrey O. Lyon [name]	_ Cofficer Constructor Member Manager Construction Constr
CHIRISTING M. GOMEZ	Officer _ Director I Member _ Manager
[name]	🗌 General Partner 🔲 Limited Partner
	Other
(name)	_ [] Officer [] Director [] Member [] Manager
furnet.	🗋 General Partner 🗋 Limited Partner
	[] Other

. Owners/Investors with a 5% beneficial inter-	est in the Applicant Entity or a related entity
EXAMPLE	East in the Applicant Linity of a related entity
JANE DOE	50%, ABC COMPANY, Inc.
[name of owner/investor]	[percentage of beneficial interest in entity and name of entity]
A. SEFFREY O. Lyon	70% VALIE VIERS ALC
[name of owner/investor]	[percentage of beneficial interest in entity and name of entity]
B. CHRISTING M. GOMEZ	30% VALLE VISTZLIC
[name of owner/investor]	[percentage of beneficial interest in entity and name of entity]
C. [name of owner/investor]	[percentage of beneficial interest in entity and name of entity]
D.	
[name of owner/investor]	[percentage of beneficial interest in entity and name of entity]
Ε.	
[name of owner/investor]	[percentage of beneficial interest in entity and name of entity]


I DECLARE UNDER PENALTY OF PERJURY UNDER THE LAWS OF THE STATE OF CALIFORNIA THAT THE FOREGOING IS TRUE AND CORRECT.

Signature of Disclosing Party, Printed Name, Title	Date
Abolitan	12/2/19

PENALTIES Falsification of information or failure to report information required to be reported may subject you to administrative action by the City.

CITY OF PALM SPRINGS – PUBLIC INTEGRITY DISCLOSURE APPLICANT DISCLOSURE FORM Page 1 of 2


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2200 SUNRISE MAY HOUSE PALM SPRINGS, CA 92262 PROJECT INFORMATION VALLE VISTA LLC. 780 NORTH 4TH. STREET EL CENTRO, CA 92243 PHONE (760) 370-3000 Ш 50|-283-0|0 LOT (28) DESERT PARK ESTATES NO. 3, LAN MAY IN THE CITY OF PALM SPRINGS, COUNTY OF RIVERSIDE, STATE OF CALIFORNIA, AS SHOWN BY MAP ON FILE IN BOOK 29, PAGE 43, OF MAPS, IN THE OFFICE Щ OF THE RECORDER OF SAID COUNTY. ₩₽¥ $\overline{\mathcal{O}}$ $\overline{\mathcal{O}}$ SQUARE FOOTAGE SUMMARY LIVING AREA: 2728 S.F. 590 S.F. GARAGE AREA: \mathbf{O} \mathbf{N} MECHANICAL: 32 S.F. TOTAL BUILDING: 3,350 S.F. 18,750 S.F. LOT SIZE: - 1,500 S.F. OF LOT DEDICATION = 17,250 S.F. LOT COVERAGE: 19 % OCCUPANCY: R-3/U TYPE OF CONSTRUCTION: V-B SPRINKLERED: YES STORIES: 1 ZONING: R ALL. 5 TOTAL BUILDING AREA: 3,350 S.F. INDEX OF DRAWINGS LINDA AUN DESCRIPTION SITE PLAN

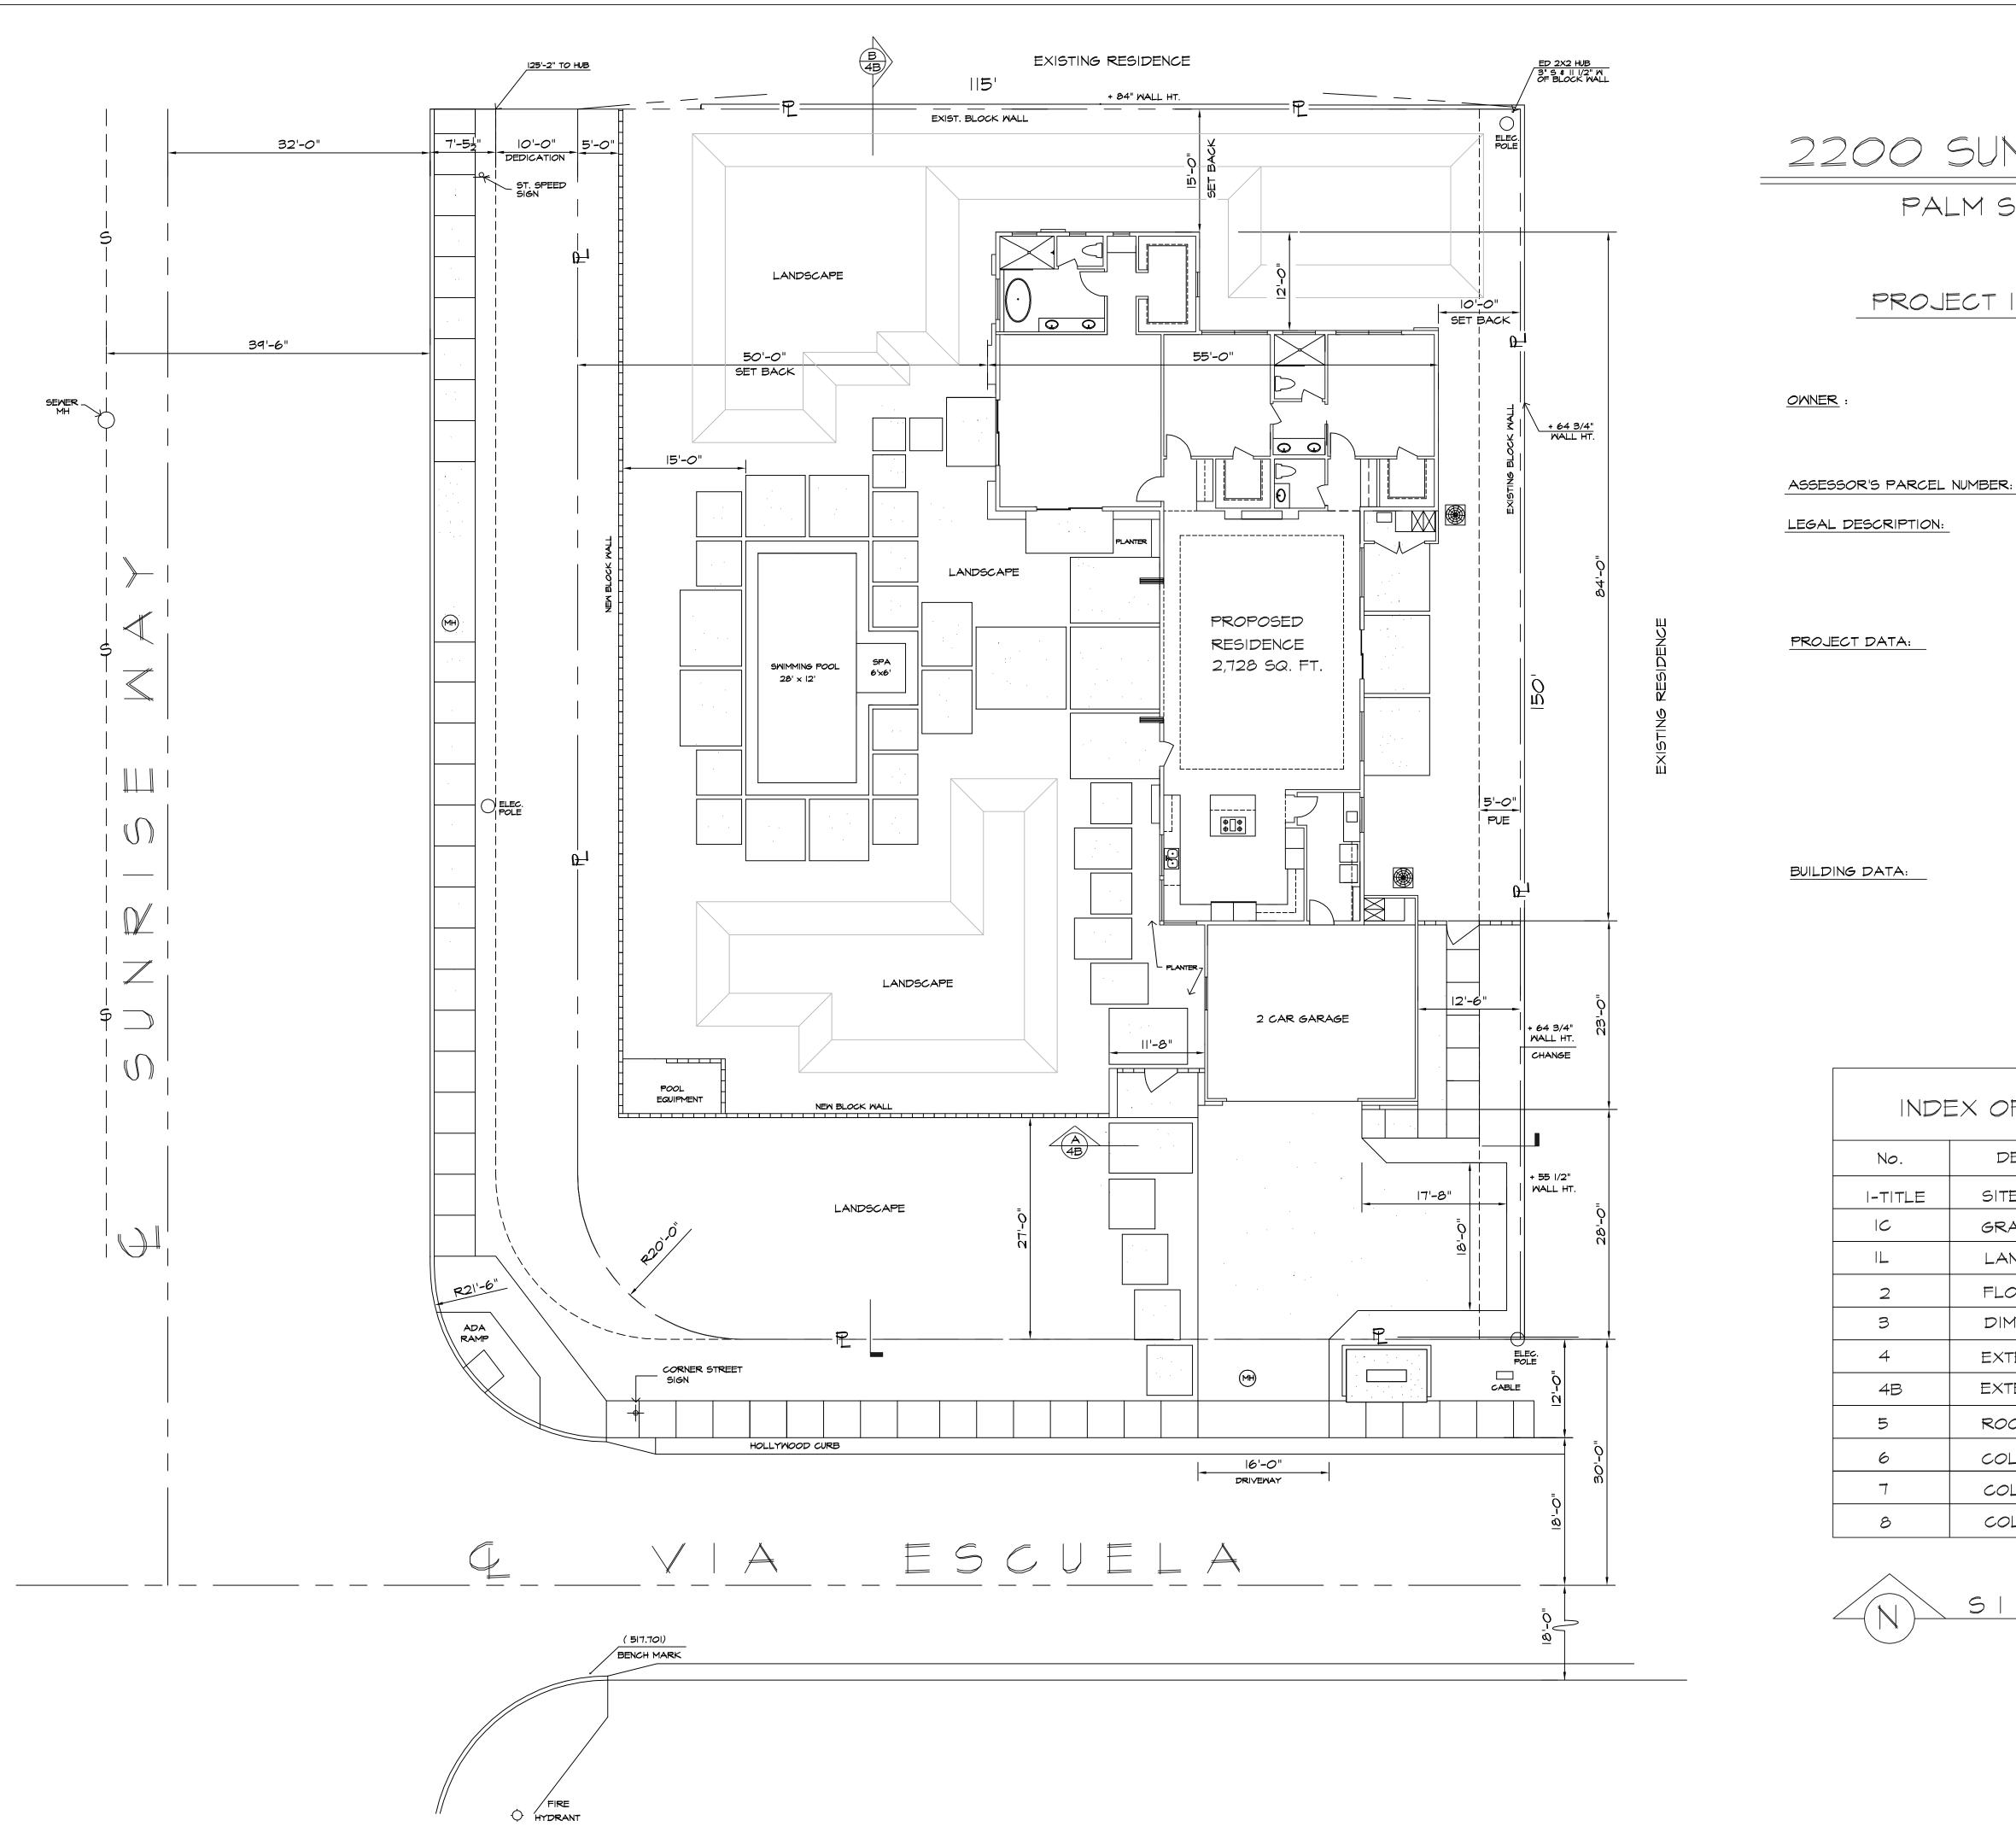ADING PLAN
NDSCAPE PLAN
OOR PLAN
MENSIONED PLAN
TERIOR ELEVATIONS
TERIOR ELEVATIONS
OF PLAN
LOR PERSPECTIVE
LOR ELEVATIONS
LOR LANDSCAPE PLAN

2200 3 PALM D@\$igr c. # 660445 ں ن $\overline{}$ \square 1Ctio δ ΰ Ľ ₽ 0 \bigcirc DATE:7/21 SCALE: AS SHOWN DRAWN BY: L.J.A SHEET



CITY OF PALM SPRINGS ENGINEERING DIVISION GRADING PLAN GENERAL NOTES (REVISED APRIL 16, 2012)

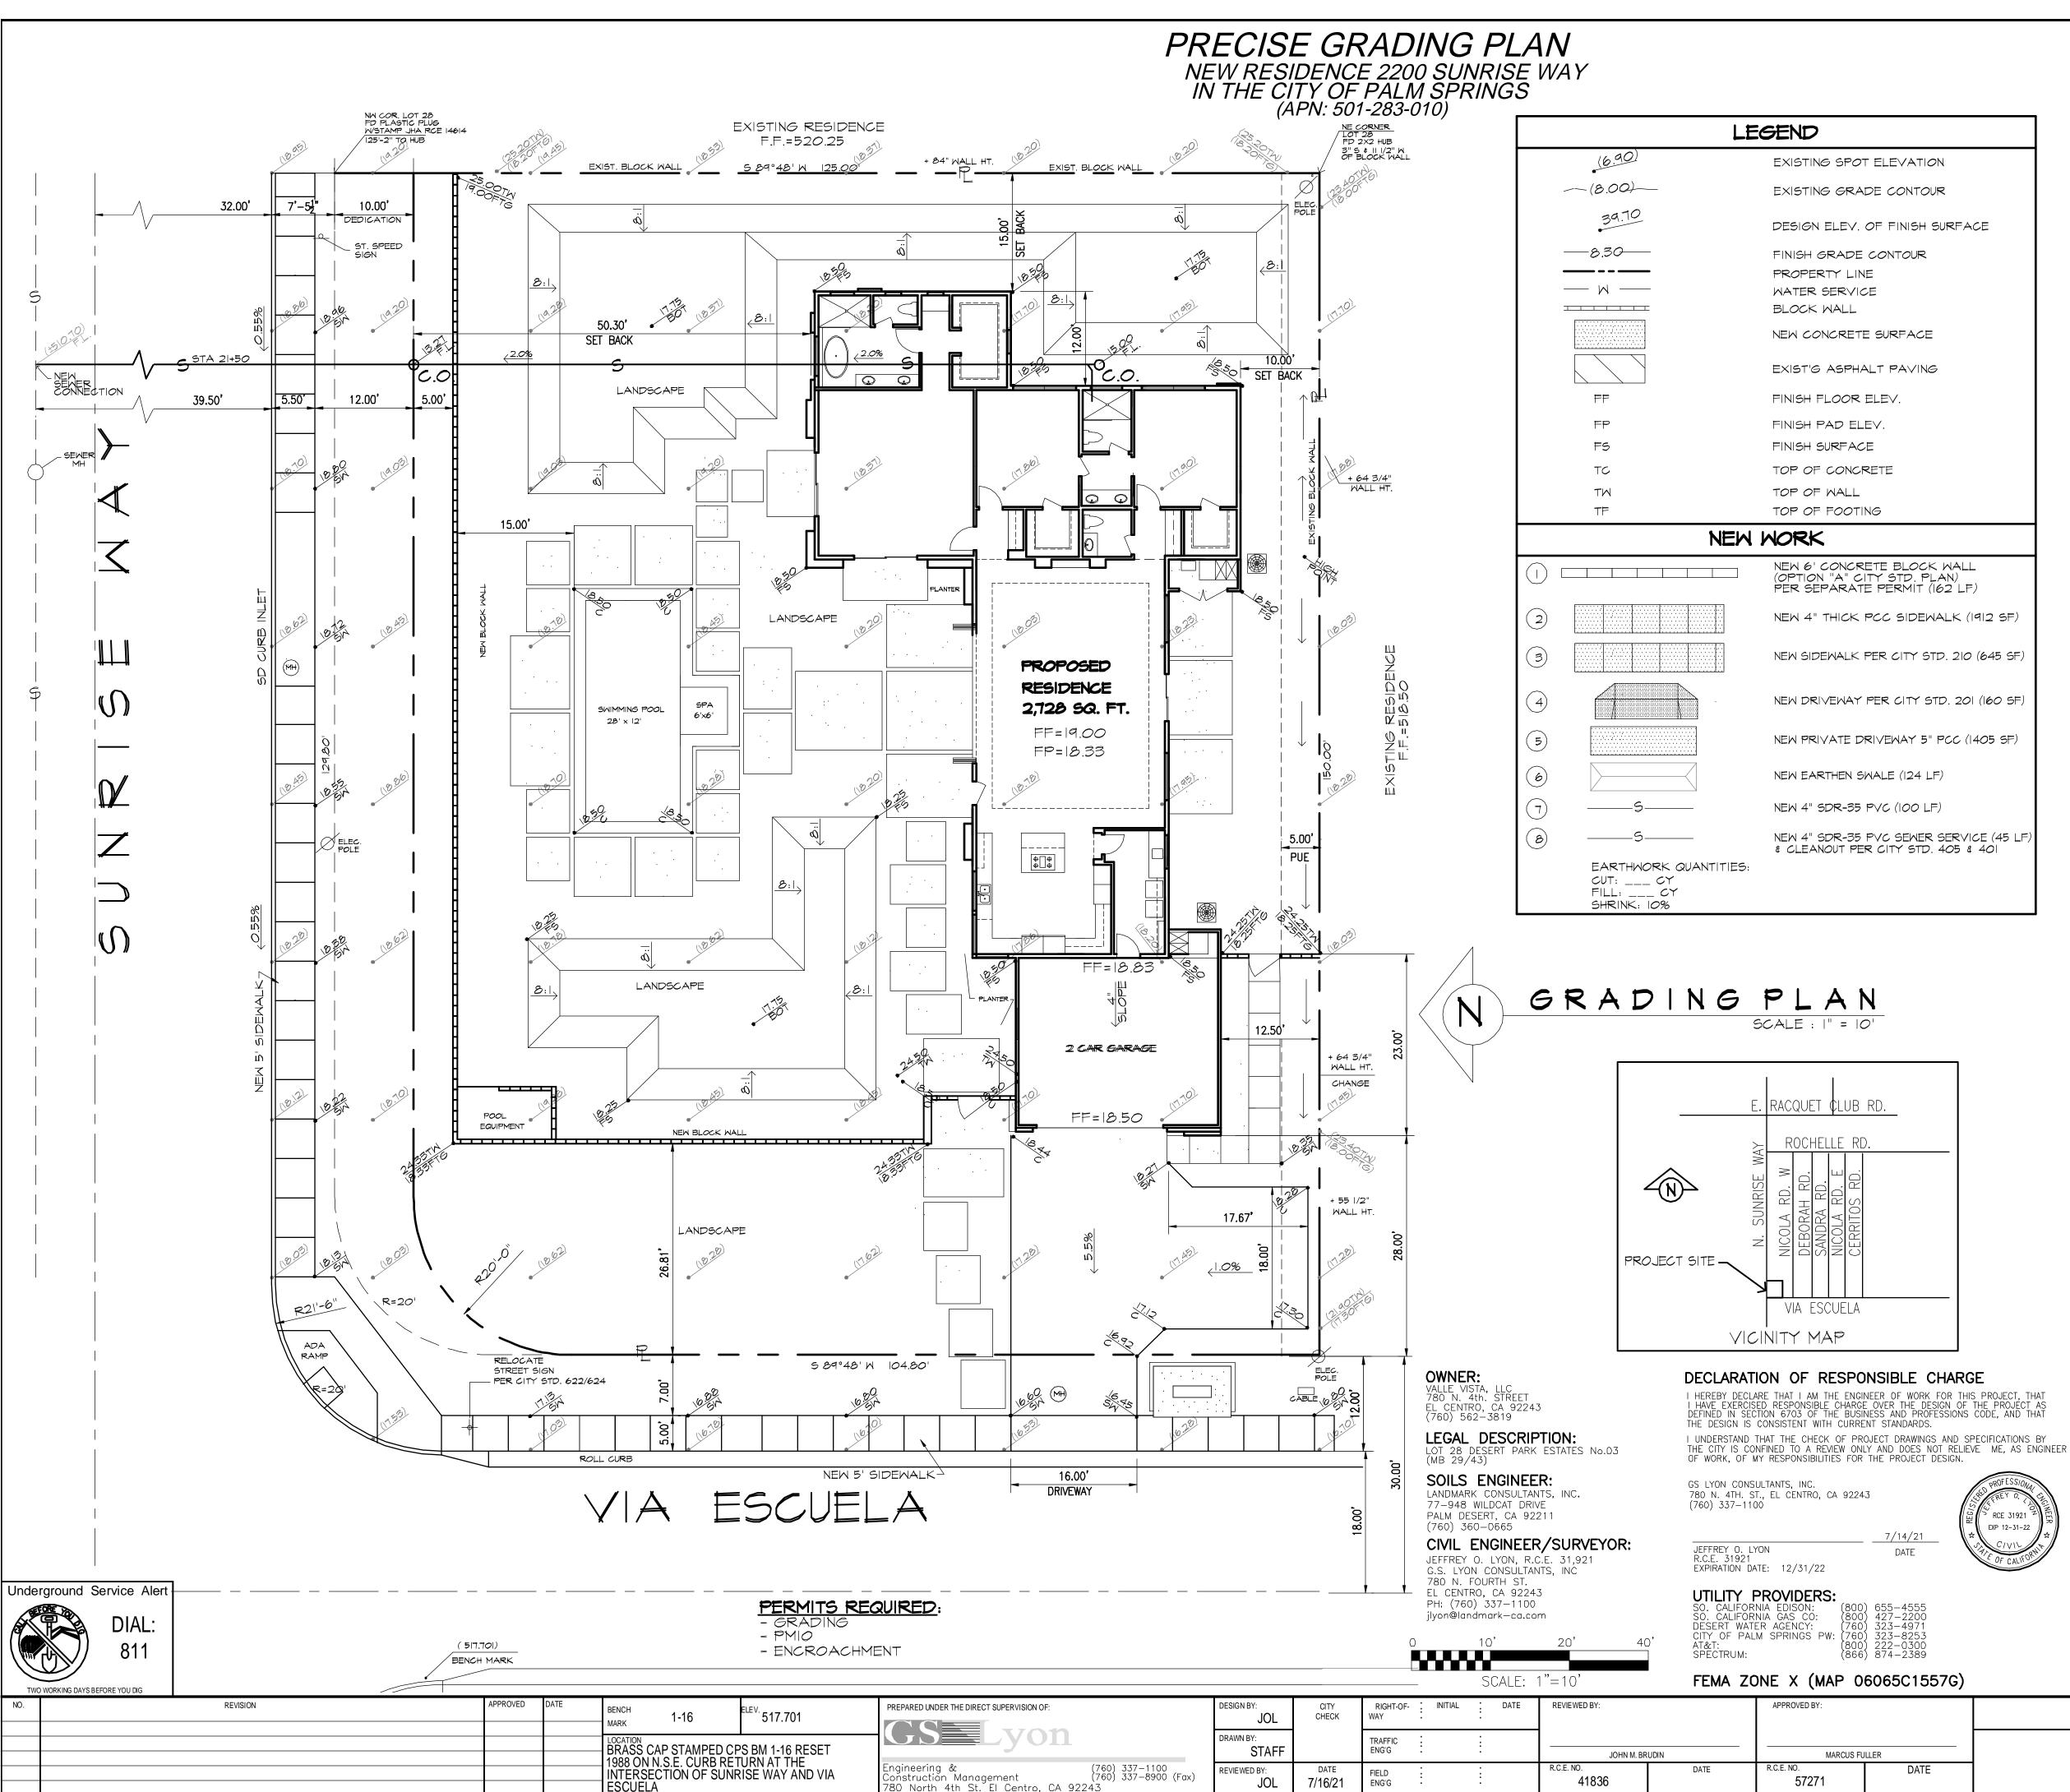1. THE WORK SHALL BE DONE IN ACCORDANCE WITH THE STANDARD DRAWINGS OF THE CITY OF PALM SPRINGS AND THE STANDARD SPECIFICATIONS FOR PUBLIC WORKS CONSTRUCTION, 2012 EDITION. 2. THE CONTRACTOR SHALL BE RESPONSIBLE FOR PROVIDING AN EFFECTIVE MEANS OF DUST CONTROL WHICH SHALL INCLUDE PROVISIONS FOR ADEQUATE WATERING DURING THE GRADING PROCESS AND PROVISIONS FOR CONTINUANCE OF DUST CONTROL UNTIL THE GRADED SURFACE PRESENTS SUFFICIENT COVER AGAINST WIND OR WATER EROSION, SO THAT SPECIAL DUST CONTROL MEASURES ARE NO LONGER NECESSARY. 3. NOTHING IN THESE PLANS SHALL RELIEVE THE CONTRACTOR FROM OBTAINING PERMITS AS REQUIRED BY CHAPTER 14.16 OF THE CITY OF PALM SPRINGS MUNICIPAL CODE. 4. THE CONTRACTOR SHALL SET AN APPOINTMENT FOR INSPECTION WITH THE ENGINEERING INSPECTOR A MINIMUM OF 24 HOURS PRIOR TO THE DATE OF INSPECTION. 5. ALL GRADING SHALL COMPLY WITH SECTION 1804 AND APPENDIX J OF THE 2010 CALIFORNIA BUILDING

6. THE LOCATION OF EXISTING UNDERGROUND UTILITIES ARE TO BE SHOWN IN A SCHEMATIC MANNER ONLY. SUBJECT TO THE PROVISIONS OF SECTION 4215 OF THE CALIFORNIA GOVERNMENT CODE, THE CONTRACTOR SHALL DETERMINE THE EXACT LOCATION OF ALL EXISTING UTILITIES BEFORE COMMENCING THE WORK. CONTACT UNDERGROUND SERVICE ALERT (U.S.A.) AT 1-800-421-4133 TWD WORKING DAYS PRIOR TO ANY **EXCAVATION**

7. DIMENSIONING TO CURBS SHALL BE TO FACE OF CURB. 8. CONTRACTOR SHALL DISPOSE OF ALL DEBRIS OFF-SITE DAILY, UNLESS OTHERWISE SPECIFIED BY THE CITY FNGINFFR 9. CONTRACTOR SHALL REMOVE ANY ABANDONED UTILITY FACILITIES AND SHOW LIMITS OF REMOVALS ON THE RECORD DRAWINGS. 10. THE CONTRACTOR SHALL BE RESPONSIBLE FOR THE REMOVAL, REPLACEMENT OR RELOCATION OF ALL REGULATORY, WARNING AND GUIDE SIGNS.

11. A 'RECORD DRAWING' (FORMERLY CALLED "AS-BUILT" DRAWING) OF THIS PLAN SHALL BE SUBMITTED BY THE PROJECT ENGINEER OF RECORD TO THE CITY ENGINEER, FOR APPROVAL PRIOR TO ACCEPTANCE OF THE WORK. 12. CONSTRUCTION SIGNING, LIGHTING AND BARRICADING SHALL BE PROVIDED ON ALL PROJECTS AS REQUIRED BY CITY STANDARDS OR AS DIRECTED BY THE CITY ENGINEER. AS A MINIMUM, ALL CONSTRUCTION SIGNING, LIGHTING AND BARRICADING SHALL BE IN ACCORDANCE WITH PART 6 ?TEMPORARY TRAFFIC CONTROL? OF THE CALIFORNIA MANUAL ON UNIFORM TRAFFIC CONTROL DEVICES FOR STREETS AND HIGHWAYS. DATED JANUARY 13. 2012, OR SUBSEQUENT EDITIONS IN FORCE AT THE TIME OF CONSTRUCTION. 13. THE FLOW LINE OF ALL CURB AND GUTTERS AND CROSS GUTTERS SHALL BE WATER TESTED BEFORE ACCEPTANCE OF THE WORK.

14. PARKING STALLS SHALL BE CLEARLY DELINEATED WITH A 4 TO 6 INCH STRIPE "HAIRPIN" OR ELONGATED "U" DESIGN OR OTHER APPROVED STRIPING OR STALL DELINEATION. 15. FINAL SITE GRADING AND DRAINAGE FLOW LINES SHALL BE CERTIFIED, IN WRITING, BY THE ENGINEER OF

RECORD TO BE IN CONFORMANCE TO THE APPROVED GRADING PLAN PRIOR TO FINAL INSPECTION. 16. FOR PROJECTS IN EXCESS OF 1 ACRE, A NOTICE OF INTENT TO COMPLY WITH CALIFORNIA GENERAL CONSTRUCTION STORMWATER PERMIT (WATER QUALITY ORDER 2009-0009-DWQ AS MODIFIED SEPTEMBER 2, 2009, AS WELL AS A COPY OF THE EXECUTED LETTER ISSUING A WASTE DISCHARGE IDENTIFICATION (WDID) NUMBER, IS REQUIRED PRIOR TO ISSUANCE OF GRADING OR BUILDING PERMIT, VIA THE CALIFORNIA REGIONAL WATER QUALITY CONTROL BOARD (PHONE NO. (760) 346-7491). A UPDATED COPY OF THE PROJECT-SPECIFIC STORM WATER POLLUTION PREVENTION PLAN (SWPPP) MUST BE KEPT AT THE PROJECT SITE AT ALL TIMES.

17. A CITY APPROVED FUGITIVE DUST (PM-10) CONTROL PLAN IS REQUIRED PRIOR TO ISSUANCE OF A GRADING PERMIT. ALL DUST CONTROL MEASURES DESCRIBED IN AQMD RULE 403 (BEST AVAILABLE CONTROL MEASURES) AND IN THE CITY-APPROVED FUGITIVE DUST CONTROL PLAN SHALL BE IMPLEMENTED AT ALL TIMES. A WIND FENCE AND PROPER SIGNAGE, SHALL BE ERECTED, INSPECTED AND APPROVED BY THE CITY?S DUST CONTROL INSPECTOR PRIOR TO INITIATION OF CLEARING, GRUBBING, GRADING OR IMPORT/EXPORT OF SOIL, OR FILL MATERIAL AT THE SITE. FAILURE TO CALL 760-323-8253, EXTENSION 8740 FOR INSPECTION 72 HOURS PRIOR TO INITIATING WORK WILL RESULT IN ISSUANCE OF CITATION BY THE CITY. 18. THE BLOCK WALLS, RETAINING WALLS, AND OTHER STRUCTURES SHOWN ON THE GRADING PLAN ARE FOR LOCATION PURPOSES ONLY. SEPARATE PERMITS FOR THE ABOVE ARE REQUIRED FROM THE BUILDING DEPARTMENT.

19. ALL PROVISIONS OF THE PRELIMINARY SDILS REPORT (WITH THE DATE OF THE REPORT SPECIFIED ON THE GRADING PLAN) PREPARED BY A CALIFORNIA REGISTERED GEOTECHNICAL ENGINEER, SHALL BE COMPLIED WITH.

STREET PAVEMENT

20. THE ASPHALT CONCRETE DESIGN SHALL MEET THE CITY OF PALM SPRINGS STD. DWG. NO 110 AND STANDARD SPECIFICATIONS FOR PUBLIC WORKS CONSTRUCTION, 2012 EDITION; USE TYPE B FOR THE BASE LIFT AND TYPE C2 FOR THE FINAL 1" CAP. THE DESIGN SHALL HAVE A HVEEM STABILITY OF 35 AND 33 RESPECTIVELY PER THE CALIFORNIA TEST METHOD 304 AND 366. PERFORMANCE GRADE ASPHALT (PG 70-10) MEETING THE 2010 CALTRANS STANDARD SPECIFICATIONS SHALL BE USED. THE SPECIFIED MISCELLANEOUS BASE SHALL BE CRUSHED MISCELLANEOUS BASE ACCORDING TO THE STANDARD SPECIFICATIONS FOR PUBLIC WORKS CONSTRUCTION, 2012 EDITION.

TRENCH PAVEMENT

21. STREET CUTS SHALL BE PAVED WITH TEMPORARY A.C. PAVING IMMEDIATELY. MAJOR AND SECONDARY THOROUGHFARES SHALL BE PERMANENTLY PAVED WITHIN 15 DAYS OF THE INITIAL EXCAVATION (30 DAYS ON COLLECTOR AND RESIDENTIAL STREETS) PER CITY OF PALM SPRINGS STD. DWG. NO. 115. SEE ORDINANCE NO. 14.16.375.

22. TRENCHES SHALL BE COMPLETELY BACKFILLED AND COMPACTED TO SUPPORT TRAFFIC AT THE END OF EACH WORK DAY. THE CONTRACTOR SHALL PLACE PERMANENT PAVEMENT THROUGH INTERSECTIONS AT THE END OF EACH WORK DAY. NO TRENCH EXCAVATION OR PIPE LAYING ON FRIDAYS, WEEKENDS OR HOLIDAYS WILL BE PERMITTED ON MAJOR AND SECONDARY THOROUGHFARES OR COLLECTOR STREETS WITHOUT PRIOR APPROVAL OF THE CITY ENGINEER. CONTRACTOR SHALL PLACE PERMANENT PAVING EACH FRIDAY. 23. IF. IN THE OPINION OF THE CITY ENGINEER, THE TRENCH BACKFILL IS UNSAFE TO TRAFFIC, THE CONTRACTOR SHALL PLACE PERMANENT PAVING AT THE END OF EACH WORK DAY. 24. STEEL TRENCH PLATING SHALL CONFORM TO THE CALTRANS ENCROACHMENT PERMIT MANUAL SECTION 602.1

AS REVISED JULY, 2009. 25. THE SPECIFIED MISCELLANEOUS BASE SHALL BE CRUSHED MISCELLANEOUS BASE ACCORDING TO THE STANDARD SPECIFICATIONS FOR PUBLIC WORKS CONSTRUCTION, 2012 EDITION. WQMP GENERAL NOTES (FOR USE ON GRADING PLANS ONLY IF PROJECT HAS WQMP REQUIREMENT) 26. EROSION CONTROL BEST MANAGEMENT PRACTICES (BMPS) SHALL BE IMPLEMENTED AND MAINTAINED TO MINIMIZE AND/OR PREVENT THE ENTRAINMENT OF SOIL IN RUNOFF FROM DISTURBED SOIL AREAS ON

CONSTRUCTION SITES. 27. SEDIMENT CONTROL BMPS SHALL BE IMPLEMENTED AND MAINTAINED TO PREVENT AND/OR MINIMIZE THE TRANSPORT OF SOIL FROM THE CONSTRUCTION SITE.

28. STOCKPILES OF SOIL SHALL BE PROPERLY CONTAINED TO ELIMINATE OR REDUCE SEDIMENT TRANSPORT FROM THE SITE TO STREETS, DRAINAGE FACILITIES OR ADJACENT PROPERTIES VIA RUNOFF, VEHICLE TRACKING, OR WIND. 29. APPROPRIATE BMPS FOR CONSTRUCTION-RELATED MATERIALS, WASTES, SPILLS OR RESIDUES SHALL BE IMPLEMENTED TO ELIMINATE OR REDUCE TRANSPORT FROM THE SITE TO STREETS, DRAINAGE FACILITIES, OR ADJOINING PROPERTIES BY WIND OR RUNOFF.

30. BMPS SHALL BE INSPECTED PRIOR TO PREDICTED STORM EVENTS AND FOLLOWING STORM EVENTS, AND SHALL BE PROPERLY MAINTAINED. 31. RUNOFF FROM EQUIPMENT AND VEHICLE WASHING SHALL BE CONTAINED AT CONSTRUCTION SITES AND MUST NOT BE DISCHARGED TO RECEIVING WATERS, ADJACENT ROADWAYS, CATCH BASINS, OR OTHER COMPONENTS

OF THE LOCAL STORM DRAIN SYSTEM. 32. ALL CONSTRUCTION CONTRACTOR AND SUBCONTRACTOR PERSONNEL ARE TO BE MADE AWARE OF THE REQUIRED BEST MANAGEMENT PRACTICES AND GOOD HOUSEKEEPING MEASURES FOR THE PROJECT SITE AND ANY

ASSOCIATED CONSTRUCTION STAGING AREAS. 33. AT THE END OF EACH DAY OF CONSTRUCTION ACTIVITY, ALL CONSTRUCTION DEBRIS AND WASTE MATERIALS SHALL BE COLLECTED AND PROPERLY DISPOSED OF IN COVERED TRASH OR RECYCLE BINS. 34. CONSTRUCTION SITES SHALL BE MAINTAINED IN SUCH A CONDITION THAT A STORM DOES NOT CARRY WASTES OR POLLUTANTS OFF THE SITE. DISCHARGES OTHER THAN STORMWATER (I.E., NON-STORMWATER DISCHARGES)


ARE PROHIBITED, EXCEPT AS AUTHORIZED BY AN INDIVIDUAL NATIONAL POLLUTION DISCHARGE ELIMINATION SYSTEM (NPDES) PERMIT, THE GENERAL PERMIT FOR STORMWATER DISCHARGES ASSOCIATED WITH CONSTRUCTION ACTIVITY, OR THE GENERAL PERMIT FOR STORMWATER DISCHARGES ASSOCIATED WITH CONSTRUCTION ACTIVITY FROM SMALL LINEAR UNDERGROUND/OVERHEAD PROJECTS. POTENTIAL POLLUTANTS INCLUDE BUT ARE NOT LIMITED TO: SOLID OR LIQUID CHEMICAL SPILLS; WASTES FROM PAINTS, STAINS,

SEALANTS, SOLVENTS, DETERGENTS, GLUES, LIME, PESTICIDES, HERBICIDES, FERTILIZERS, WOOD PRESERVATIVES, ASBESTOS FIBERS, PAINT FLAKES OR STUCCO FRAGMENTS; FUELS, OILS, LUBRICANTS, AND HYDRAULIC, RADIATOR OR BATTERY FLUIDS; CONCRETE AND RELATED CUTTING OR CURING RESIDUES; CONCRETE WASHOUT; FLOATABLE WASTES; WASTES FROM ENGINE/EQUIPMENT STEAM CLEANING OR CHEMICAL DEGREASING; WASTES FROM STREET CLEANING; AND SUPER-CHLORINATED POTABLE WATER FROM LINE FLUSHING AND TESTING. DURING CONSTRUCTION, DISPOSAL OF SUCH MATERIALS SHOULD OCCUR IN A SPECIFIED AND CONTROLLED TEMPORARY AREA ON-SITE, PHYSICALLY SEPARATED FROM POTENTIAL STORMWATER RUNOFF, WITH ULTIMATE DISPOSAL IN ACCORDANCE WITH LOCAL, STATE AND FEDERAL

REQUIREMENTS. 35. DISCHARGING CONTAMINATED GROUNDWATER PRODUCED BY DEWATERING GROUNDWATER THAT HAS INFILTRATED INTO THE CONSTRUCTION SITE IS PROHIBITED. DISCHARGING OF CONTAMINATED SOILS VIA SURFACE EROSION IS ALSO PROHIBITED. DISCHARGING NON-CONTAMINATED GROUNDWATER PRODUCED BY DEWATERING ACTIVITIES MAY REQUIRE A NATIONAL POLLUTANT DISCHARGE ELIMINATION SYSTEM (NPDES) PERMIT OR WASTE DISCHARGE REQUIREMENTS (WDRS) ISSUED BY THE COLORADO RIVER BASIN REGIONAL WATER QUALITY CONTROL BOARD. 36. CONSTRUCTION SITES SHALL BE MANAGED TO MINIMIZE THE EXPOSURE TIME OF DISTURBED SOIL AREAS


THROUGH PHASING AND SCHEDULING OF GRADING TO THE EXTENT FEASIBLE AND THE USE OF TEMPORARY AND PERMANENT SOIL STABILIZATION.

FILE NO. SHEET CITY OF PALM SPRINGS, CALIFORNIA DWG.NO. PRECISE GRADING PLAN NEW RESIDENCE 2200 SUNRISE WAY CADD FILE NAME i2113ViaEscue

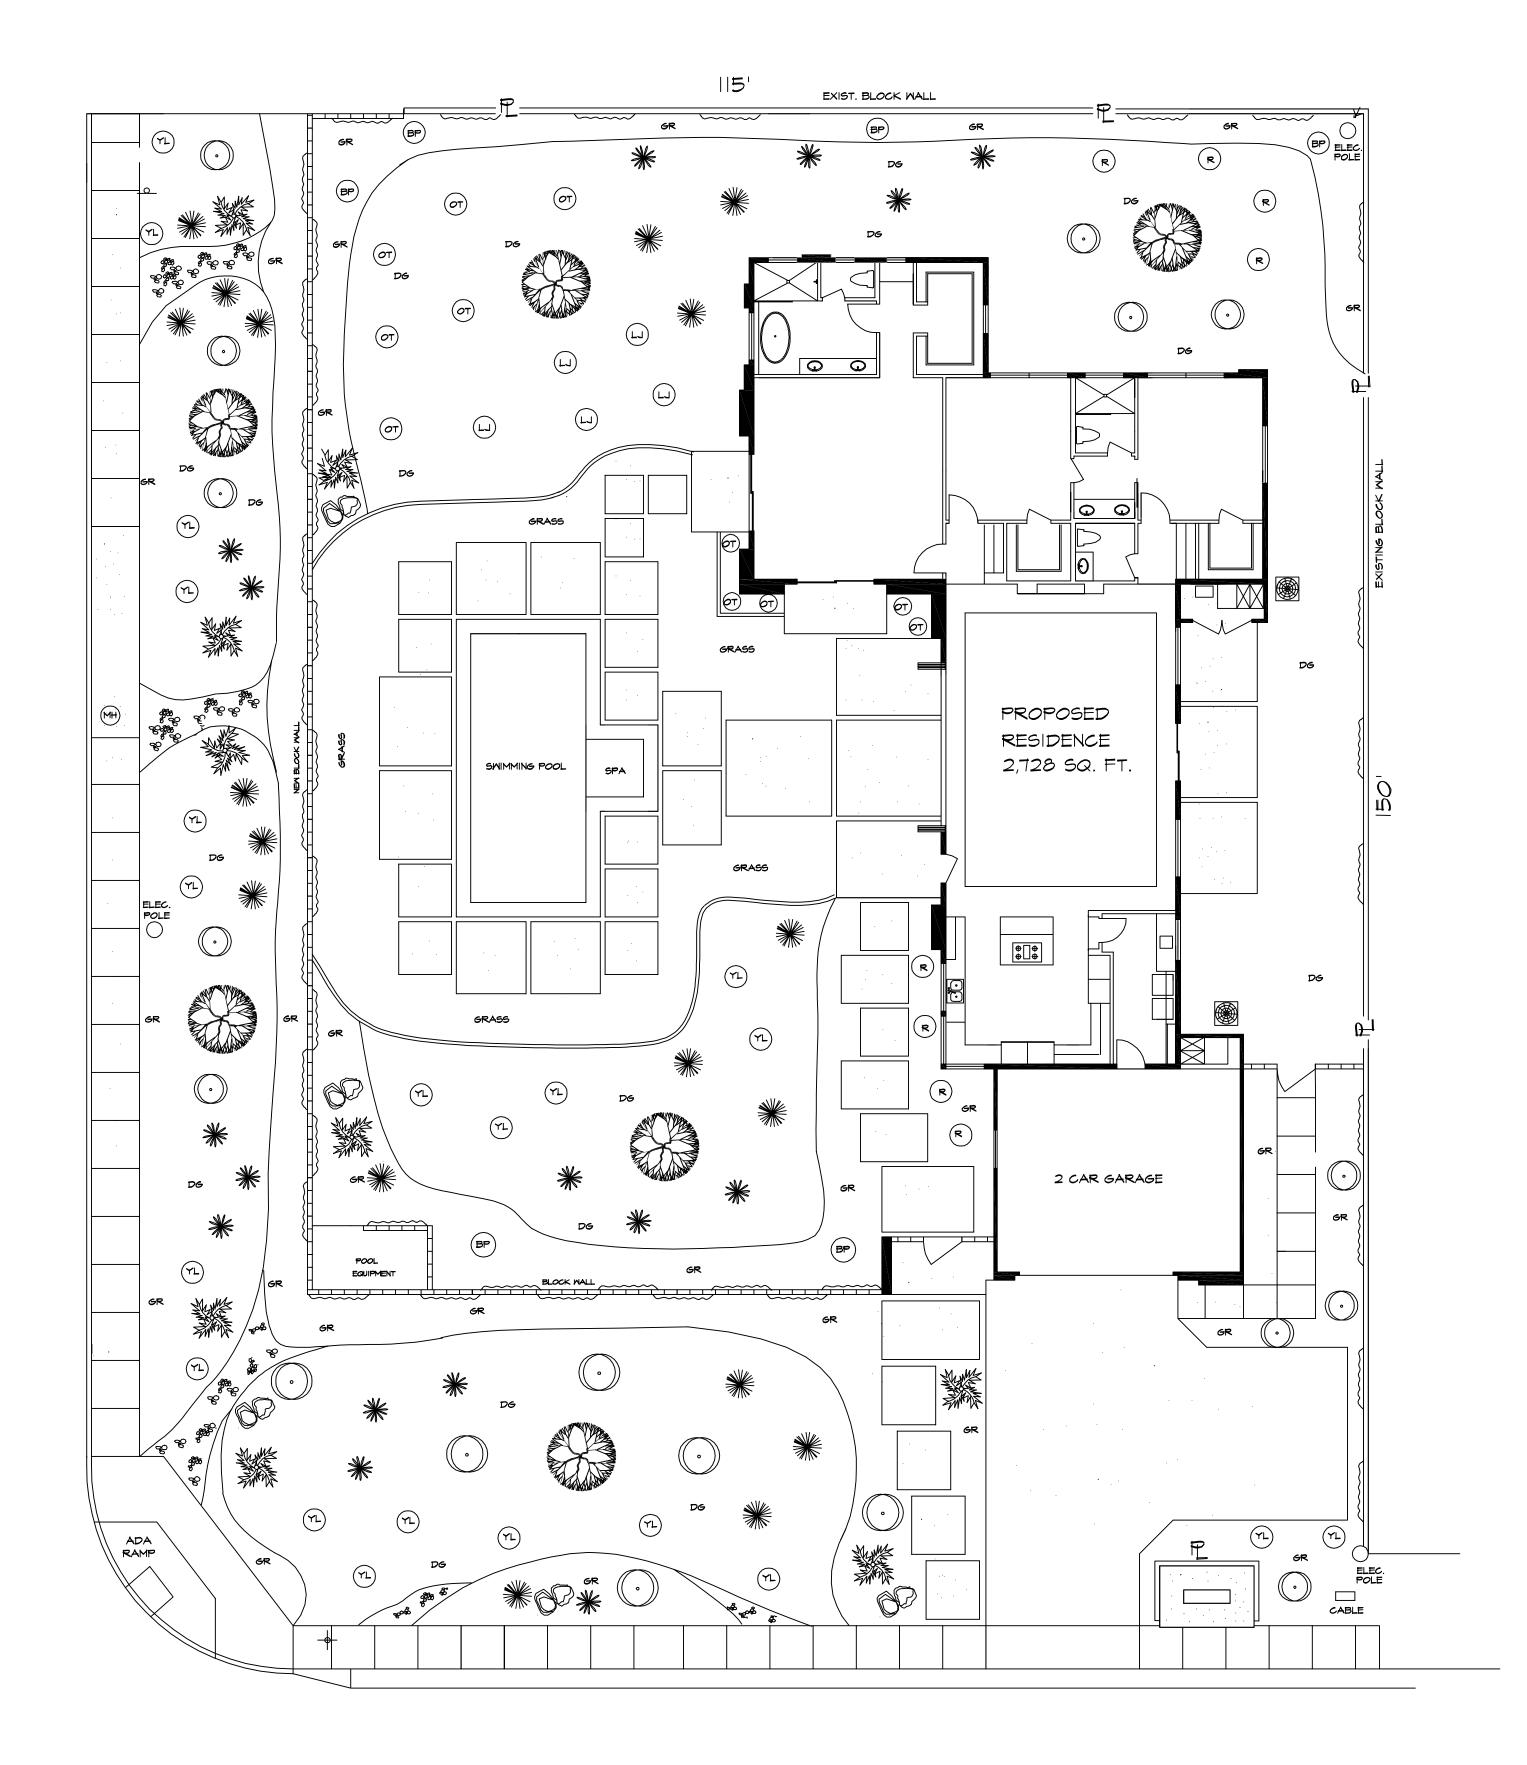

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VIA ESCUELA

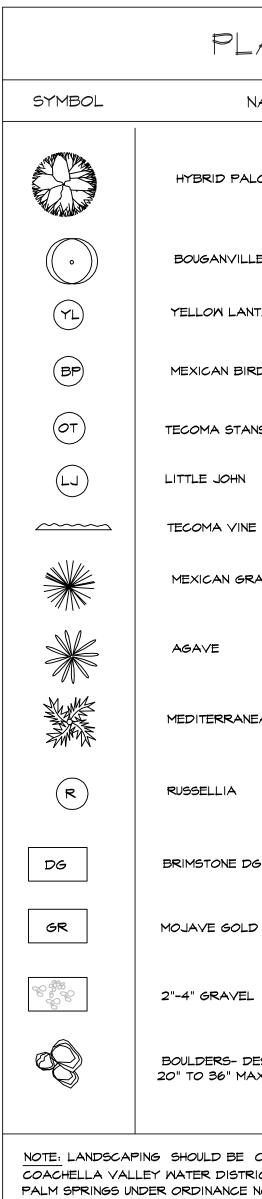


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AME	SIZE	QUANTITY
O VERDE TREE	24" BOX	6
A RED SHRUB	5 GAL	18
ANA	5 GAL	21
D OF PARADISE	5 GAL	5
S -ORANGE BELLS	5 GAL	П
	5 GAL	5
-YELLOW BELLS	15 GAL	41
ASS TREE	15 GAL	18
	5 GAL	16
AM FAN PAN	15 GAL	٩
	5 GAL	8
3/4" GRAVEL		
SERT GOLD K. WIDTH	20" ТО 36" МАХ. ШФТН	

PALM SPRINGS UNDER ORDINANCE NO. 686 "WATER EFFICIENT LANDSCAPE ORDINANCE" AS RECOMMENDED FOR THE LANDSCAPE MATERIALS: "LUSH AND EFFICIENT: LANDSCAPE GARDENING IN COACHELLA VALLEY" BY THE COACHELLA VALLEY WATER DISTRICT, 2006.

> LANDSCAPE PLAN SCALE : ||' = |O'|

DESIGNER: Description L.A. Construction / Design Image: Section / Description L.A. Construction / Design Image: Section / Description InDa aun Lic. # 660445 State contents: Image: Section / Description InDa aun Lic. # 660445 State contents: Image: Section / Description InDa aun Lic. # 660445 State contents: Image: Section / Description InDa aun Lic. # 660445 State contents: Image: Section / Description InDa aun Lic. # 660445 State contents: Image: Section / Description State contents: Image: Section / Description Indicate contents: Image: Section / Description	DATE			
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GNER: A. CONSTRUCTION / DOSIGN LINDA AUN LINDA AUN CATHEDRAL CITY, CA 92234 PHONE (160) 409-1956 PHONE (160) 409-1956	SHEET CONTENTS:		LANDSCAPE PLAN	1
GNER: A. CONSTRUCTION / DOSIGN LINDA AUN LIC. # 660445 67-100 MEDANO RD., CATHEDRAL CITY, CA 92234 PHONE (160) 409-7956	OMNER:	VALLE VISTA LLC.	PROJECT ADDRESS:	2200 SUNRISE WAY PALM SPRING, CA
		.A. Construction / Design	LIC. # 660445	
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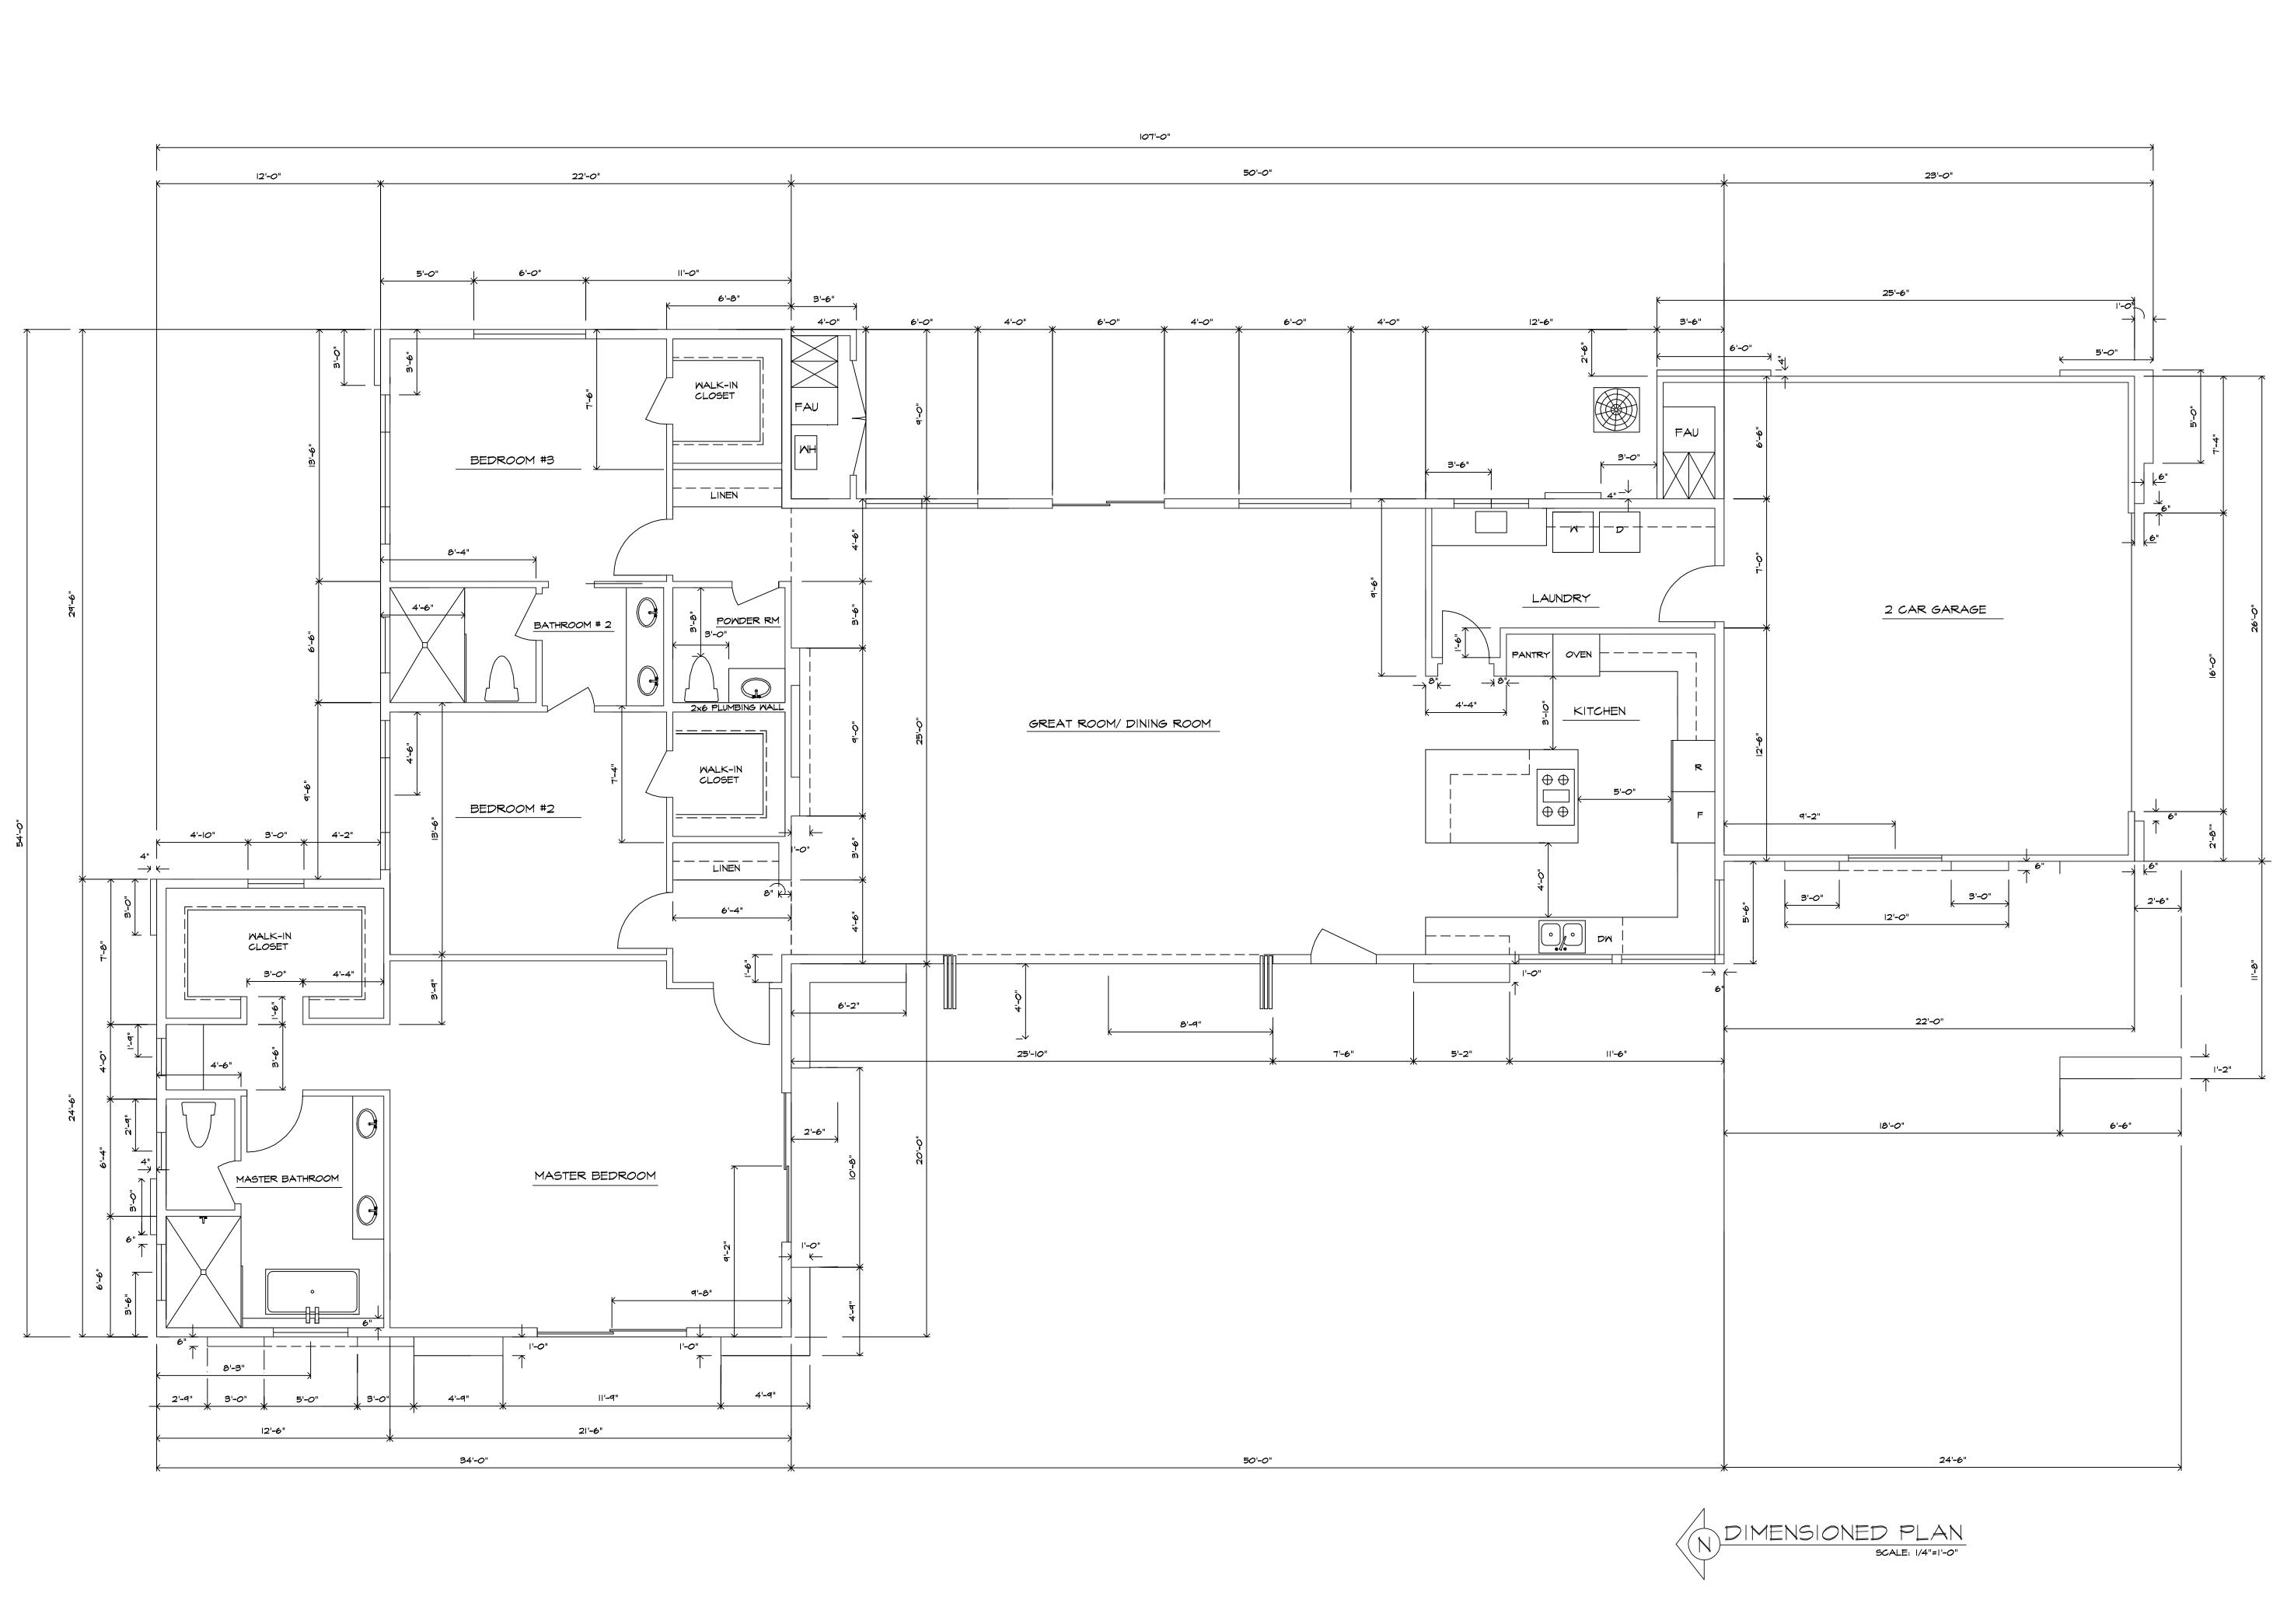
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SYMBOL		NSION HEIGHT	FRAME	REMARKS	SYMBOL		ENSION HEIGHT	FRAME	THICK	REMARKS			
	6'-0"	5'-0"	VINYL	DUAL GLAZED, SLIDER	A	3'-6"	8'-0"	WOOD	3/4"	FRENCH DR., SOLID CORE, LOCKING HARDWARE		2x6 WALL W/ STUDS @16" O.C. W/ R-21 FIBERGLASS BATT INSULATION W/ STUCCO AS EXTERIOR FINISH AND 5/8" GYPSUM BOARD AS INTERIOR FINISH	LAUNDRY ROOM SH AIR AS PER UMC SE
	5'-0"	5'-0"	VINYL	DUAL GLAZED, SLIDER	В	3'-0"	6'-8"	WOOD	3/4"	IHR. FIRE RATED-SELF CLOSING LOCKING HARDWARE			2 ELECTRICAL MAIN
3	4'-0"	5'-0"	VINYL	DUAL GLAZED, SLIDER		3'-0"	8'-0"	WOOD	3/4"	INTERIOR		2x4 WALL W/ STUDS @ 16" O.C. W/ R-15 FIBERGLASS BATT INSULATION W/ STUCCO AS EXTERIOR	3 TANKLESS WATER
4	4'-0"	4'-0"	VINYL	DUAL GLAZED, SLIDER	D	17-8"	8'-0"	VINYL	LAC	ANTINA FOLDING DOOR SYSTEM DUAL GLAZED		FINISH AND 5/8" TYPE "X" GYPSUM BOARD AS INTERIOR FINISH	4 CONDENSER LOCA MANUF. REQ.
5	4'-0"	5'-0"	VINYL	DUAL GLAZED, TEMPER, FIXED	E	8'-0"	8'-0"	VINYL		SLIDING, TEMPER., DUAL GLAZED		INTERIOR 2 X 4 WALL W/ STUDS © 16" O.C. W/ 5/8" GYPSUM BOARD ON BOTH SIDES.	5 GAS SERVICE, VER
6	3'-0"	2'-6"	VINYL	DUAL GLAZED, TEMPER, SLIDER	F	2'-6"	8'-0"	WOOD	3/4"	INTERIOR POCKET		INTERIOR 2 X 4 WALL W/ STUDS @ 16" O.C.	
(7)	8'-0"	5'-0"	VINYL	DUAL GLAZED, DOUBLE SLIDER	G	3'-0"	8'-0"	MTL		METAL, VENTED DOOR		W/R-15 FIBERGALSS INSULATION AND W/ 5/8" GYPSUM BOARD ON BOTH SIDES.	6 PRO SERIES ELEC MODEL ERC4060 THIS APPLIANCE H
8	2'-0"	3'-0"	VINYL	DUAL GLAZED, SINGLE HANG	H	6'-0"	8'-0"	MTL		SLIDING, TEMPER., DUAL GLAZED	• • • • • • •	PLUMBING WALL W/ 2 X 6" STUDS @ 16" O.C. \$ 1/2" BOARD MOISTURE RESISTAND ON	CSA C22.2 NO. 46
(a)	6'-0"	2'-0"	VINYL	DUAL GLAZED, FIXED	\bigcirc	2'-6"	8'-0"	WOOD	3/4"	INTERIOR		BATHROOM SIDE	KitchenAid 36" o W/300 CFM EXH. MECHANICAL PL
	з"- <i>0</i> "	2'-0"	VINYL	DUAL GLAZED, FIXED									


VERIFY W/ UTILITY COMPANY

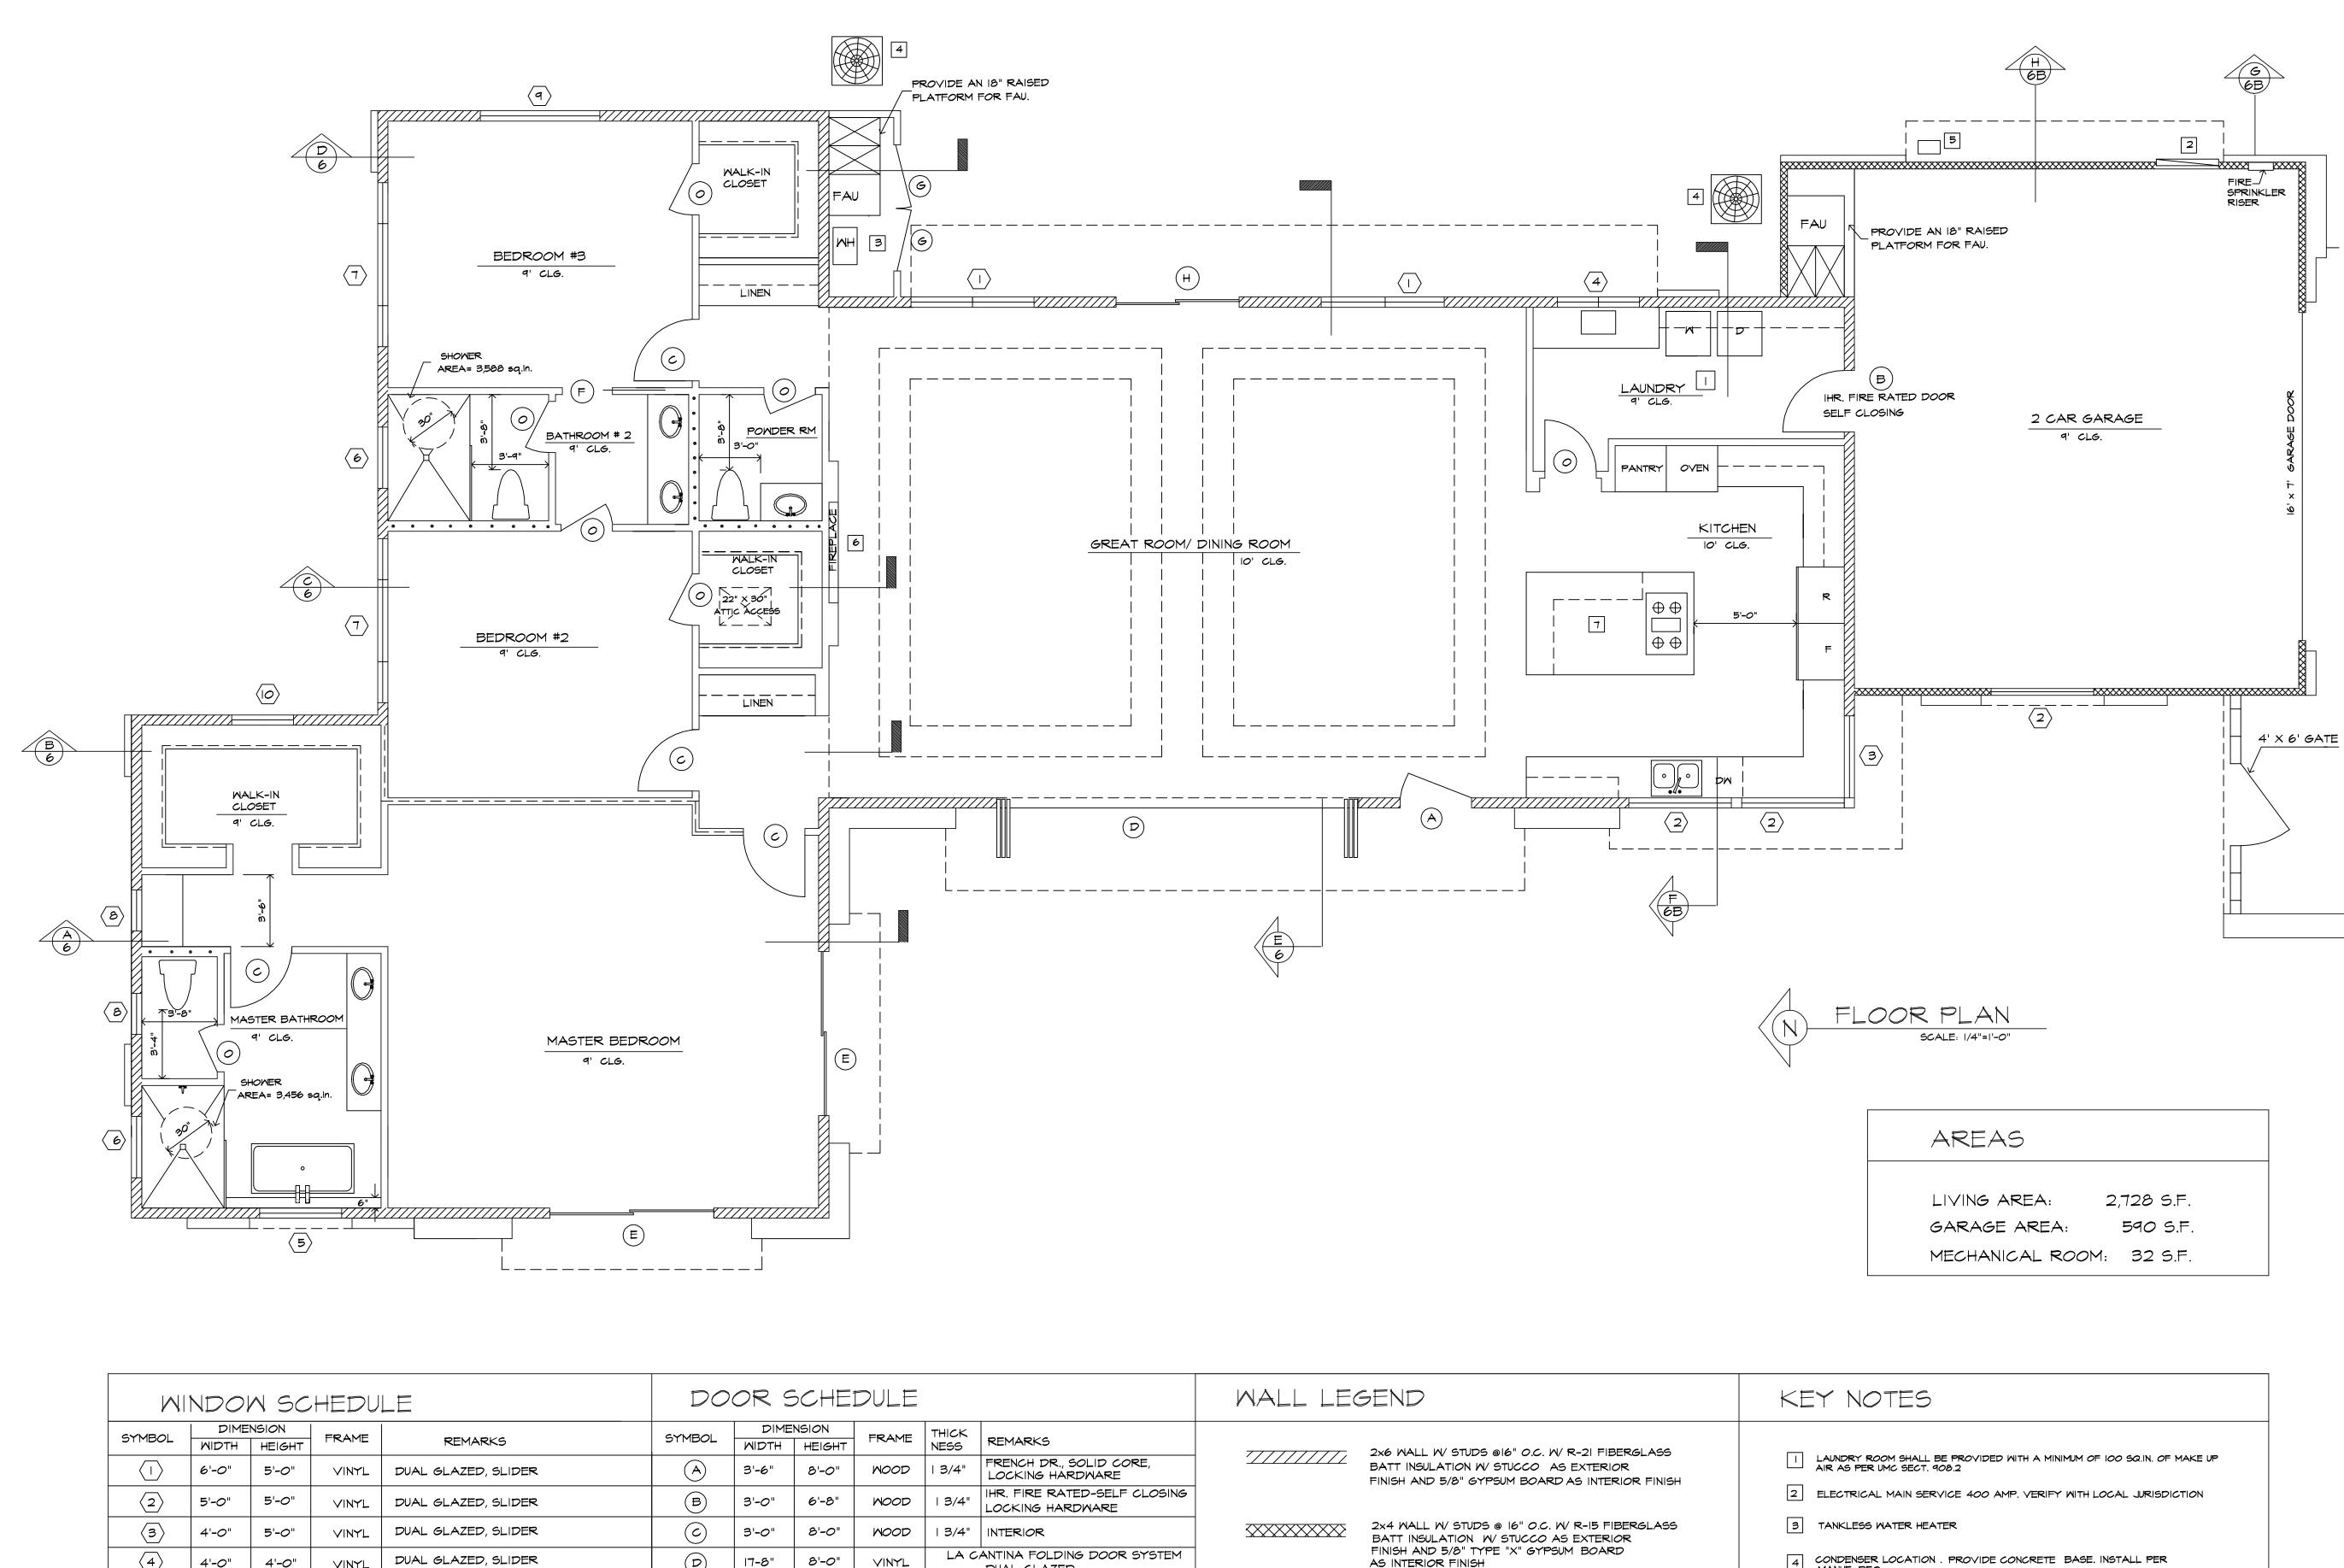
LECTRIC FIREPLACE BY SUPERIOR FIREPLACE CO. 060 INSTALLED PER MANUFACTURED SPECIFICATIONS. CE HAS BEEN TESTED IN ACCORDANCE WITH UL2012 AND . 46-M198


36" GAS DOWNDRAFT COOKTOP MODEL KCGD50GSS EXHAUST FAN- SEE FOUNDATION PLAN SHT S-I AND PLAN SHT-10 FOR UNDERGROUND EXHAUST PIPE LOCATION


1E				
DATE		_		
DESCRIPTION				
REVISION				
SHEET CONTENTS:			2200 DUNKIDE NAY HOUDE	
OWNER:	VALLE VISTA LLC.	PROJECT ADDRESS:	2200 SUNRISE MAY PALM SPRING, CA	
DESIGNER:	L.A. Construction / Design	•	67-100 MEDANO RD., CATHEDRAL CITY, CA 92234	
DA	ATE:"	-	SHC	
SC				
			′:∟.J	.A.
DF		N BI	<pre>': ∟.↓</pre>	.A.



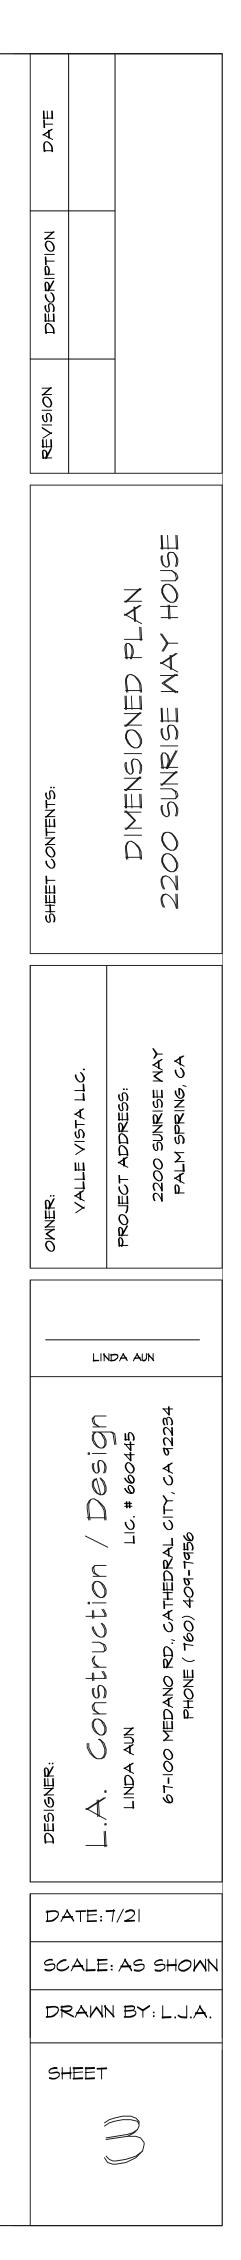

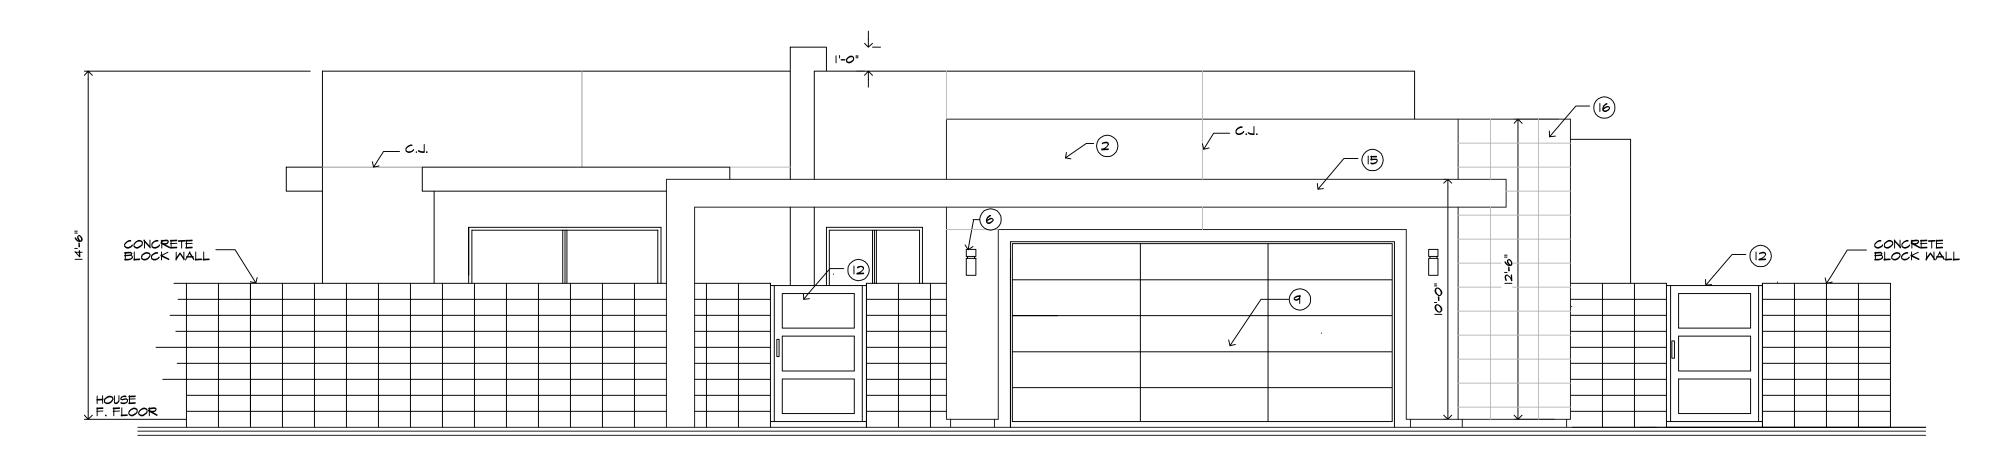

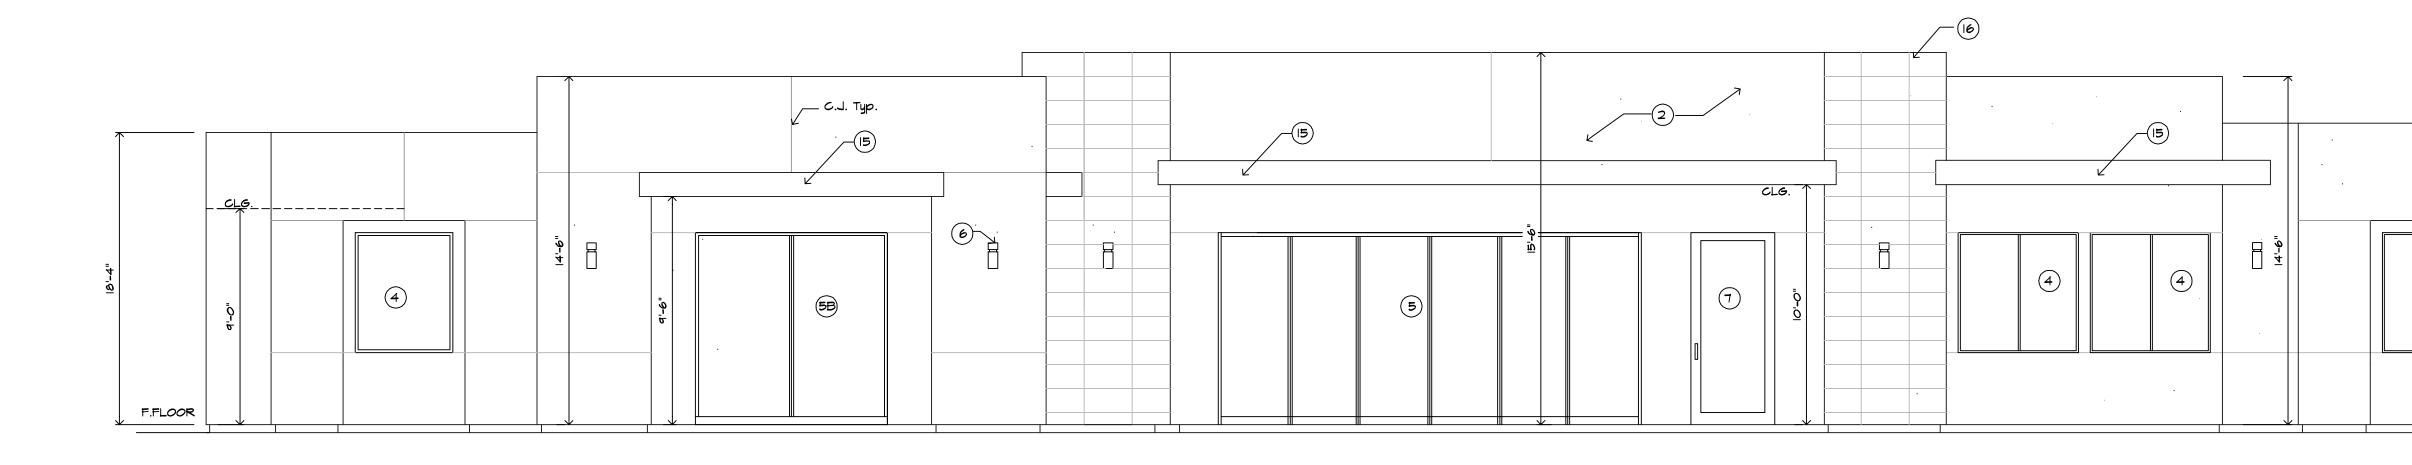


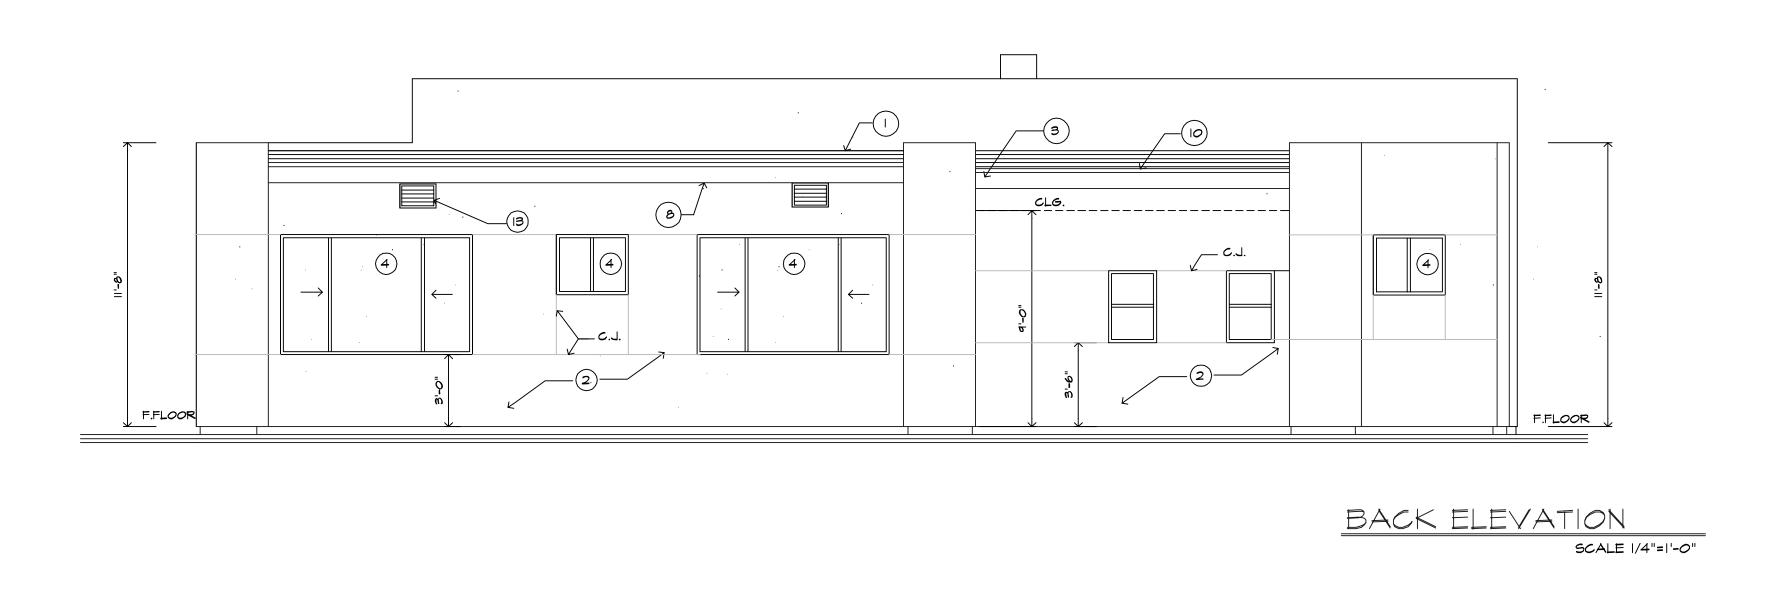



FRONT ELEVATION Scale: 1/4"=1'-0"


	
E	ELEVATION LEGEND
	ROOFING - LAPOLLA COATING POLY FOAM SYSTEM WITH THERMO-FLEX / ELASTOMERIC TF 1002 LIGHT GRAY
2	EXTERIOR STUCCO
3	R.S. FASCIA
4	VINTL WINDOW
5	VINYL FOLDING GLASS DOOR
5B	VINYL SLIDING GLASS DOOR
٢	EXTERIOR LAMP
	FRENCH DOOR


- C (4)	J.				- <u>o</u> -	
YURETHANE ACRYLIC ROOF Y COLOR FINISH	(b) (c) (c) (c) (c) (c) (c) (c) (c) (c) (c	STUCCO UN GARAGE D GALVANIZE TO MATCH	ED IRON DRIP WINDOWS FRA	SCAL /ERHANG EDGE- F AME	_E /4"	
	$ \begin{array}{c} \\ \\ \\ 2 \\ \\ \\ \\ \\ \\ \\$	METAL GA 10" X 14" S	CREENED & LO CREENED & LO ANOPY	OUVEREL		

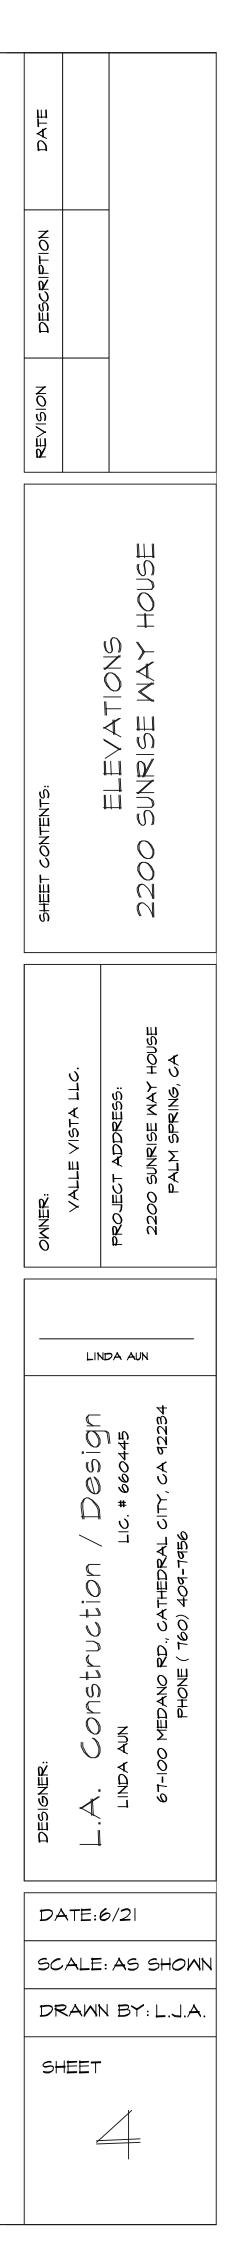

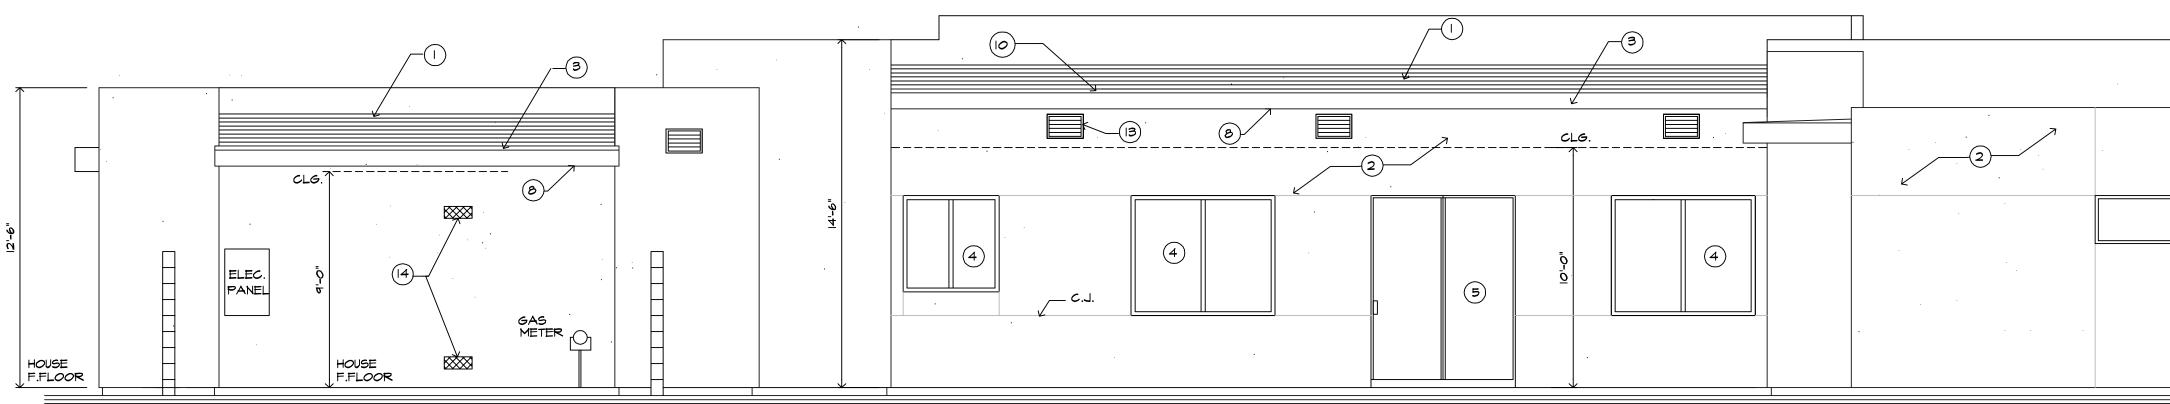


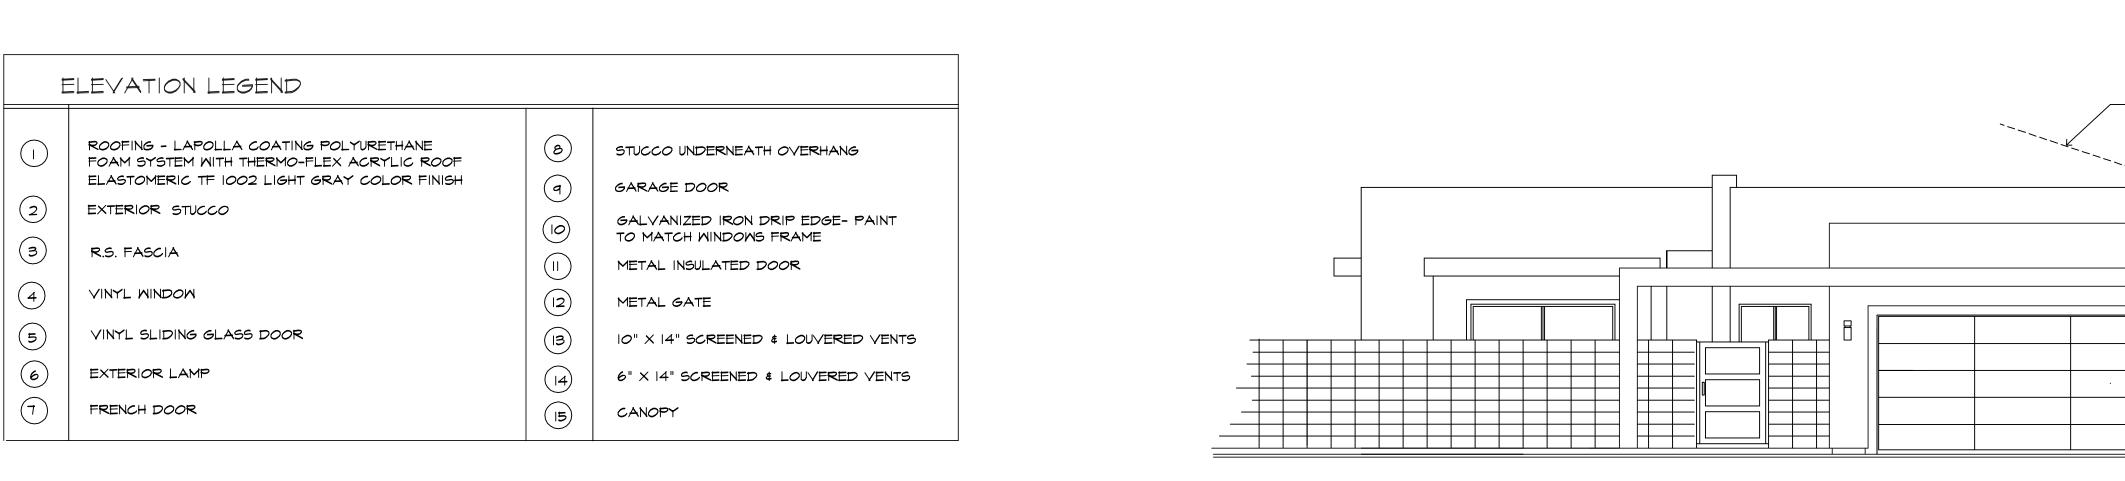

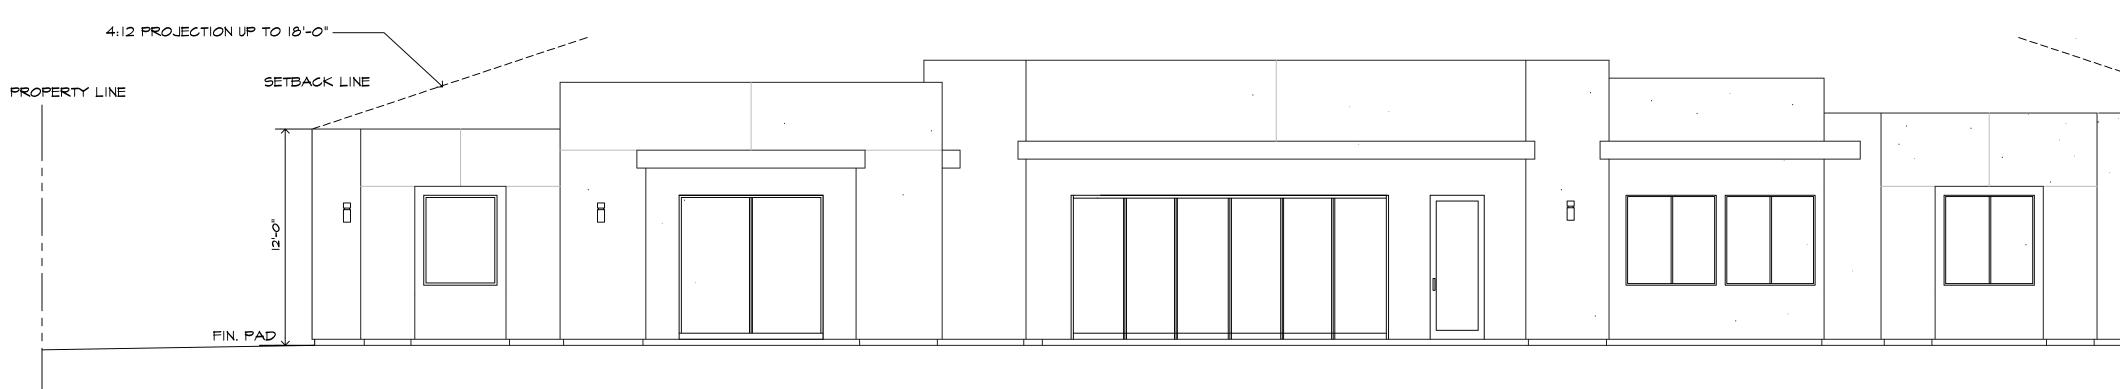

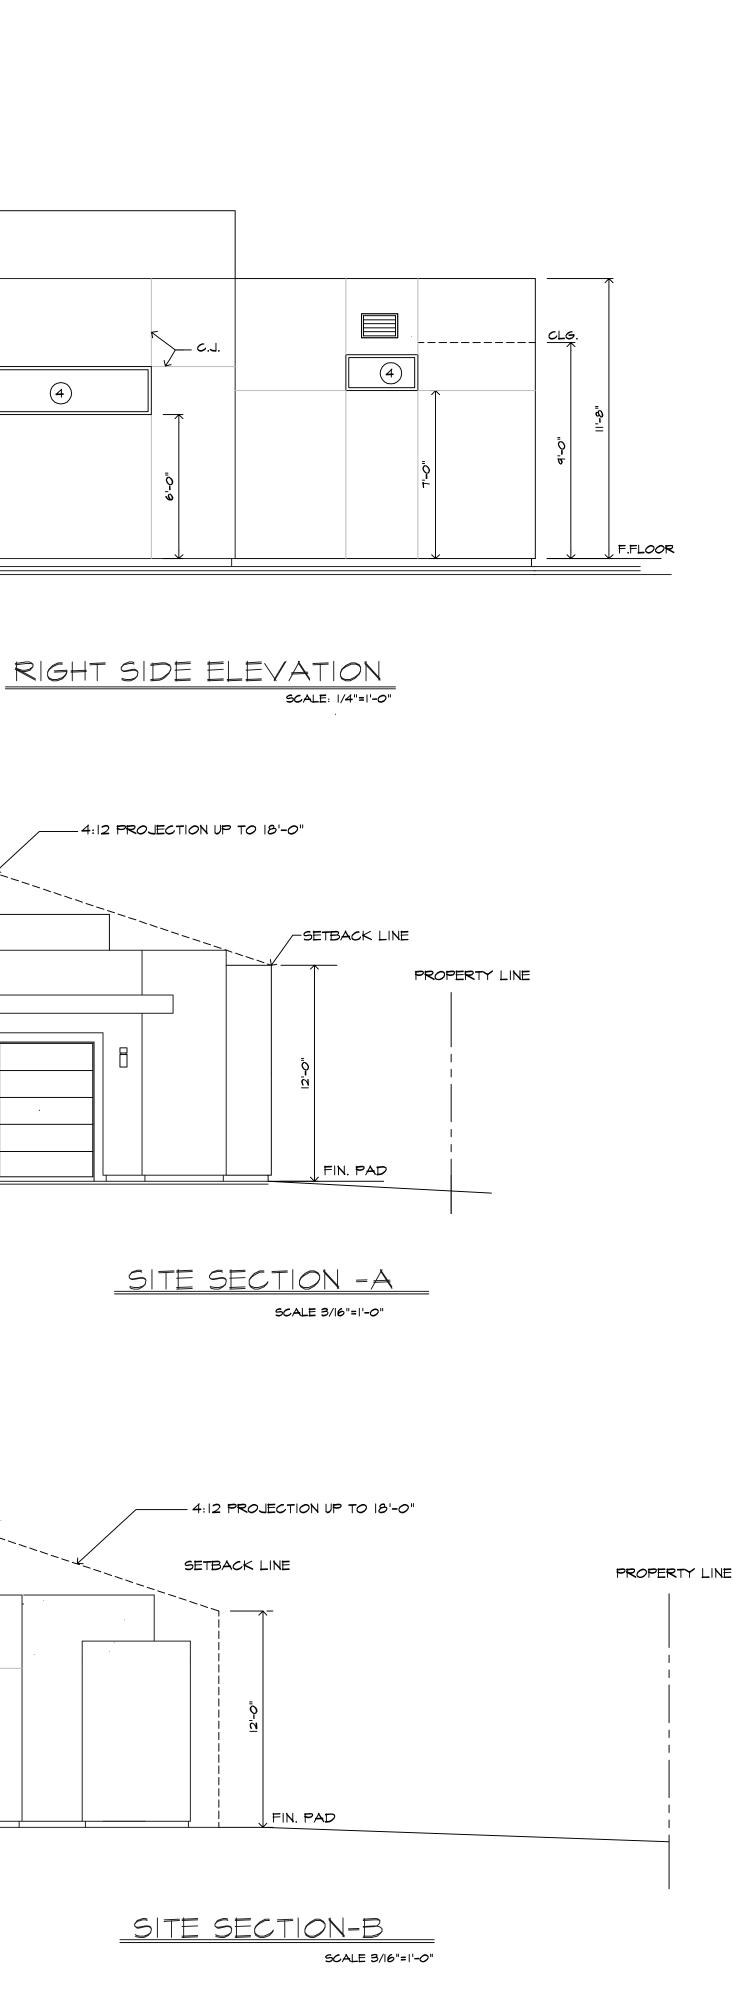



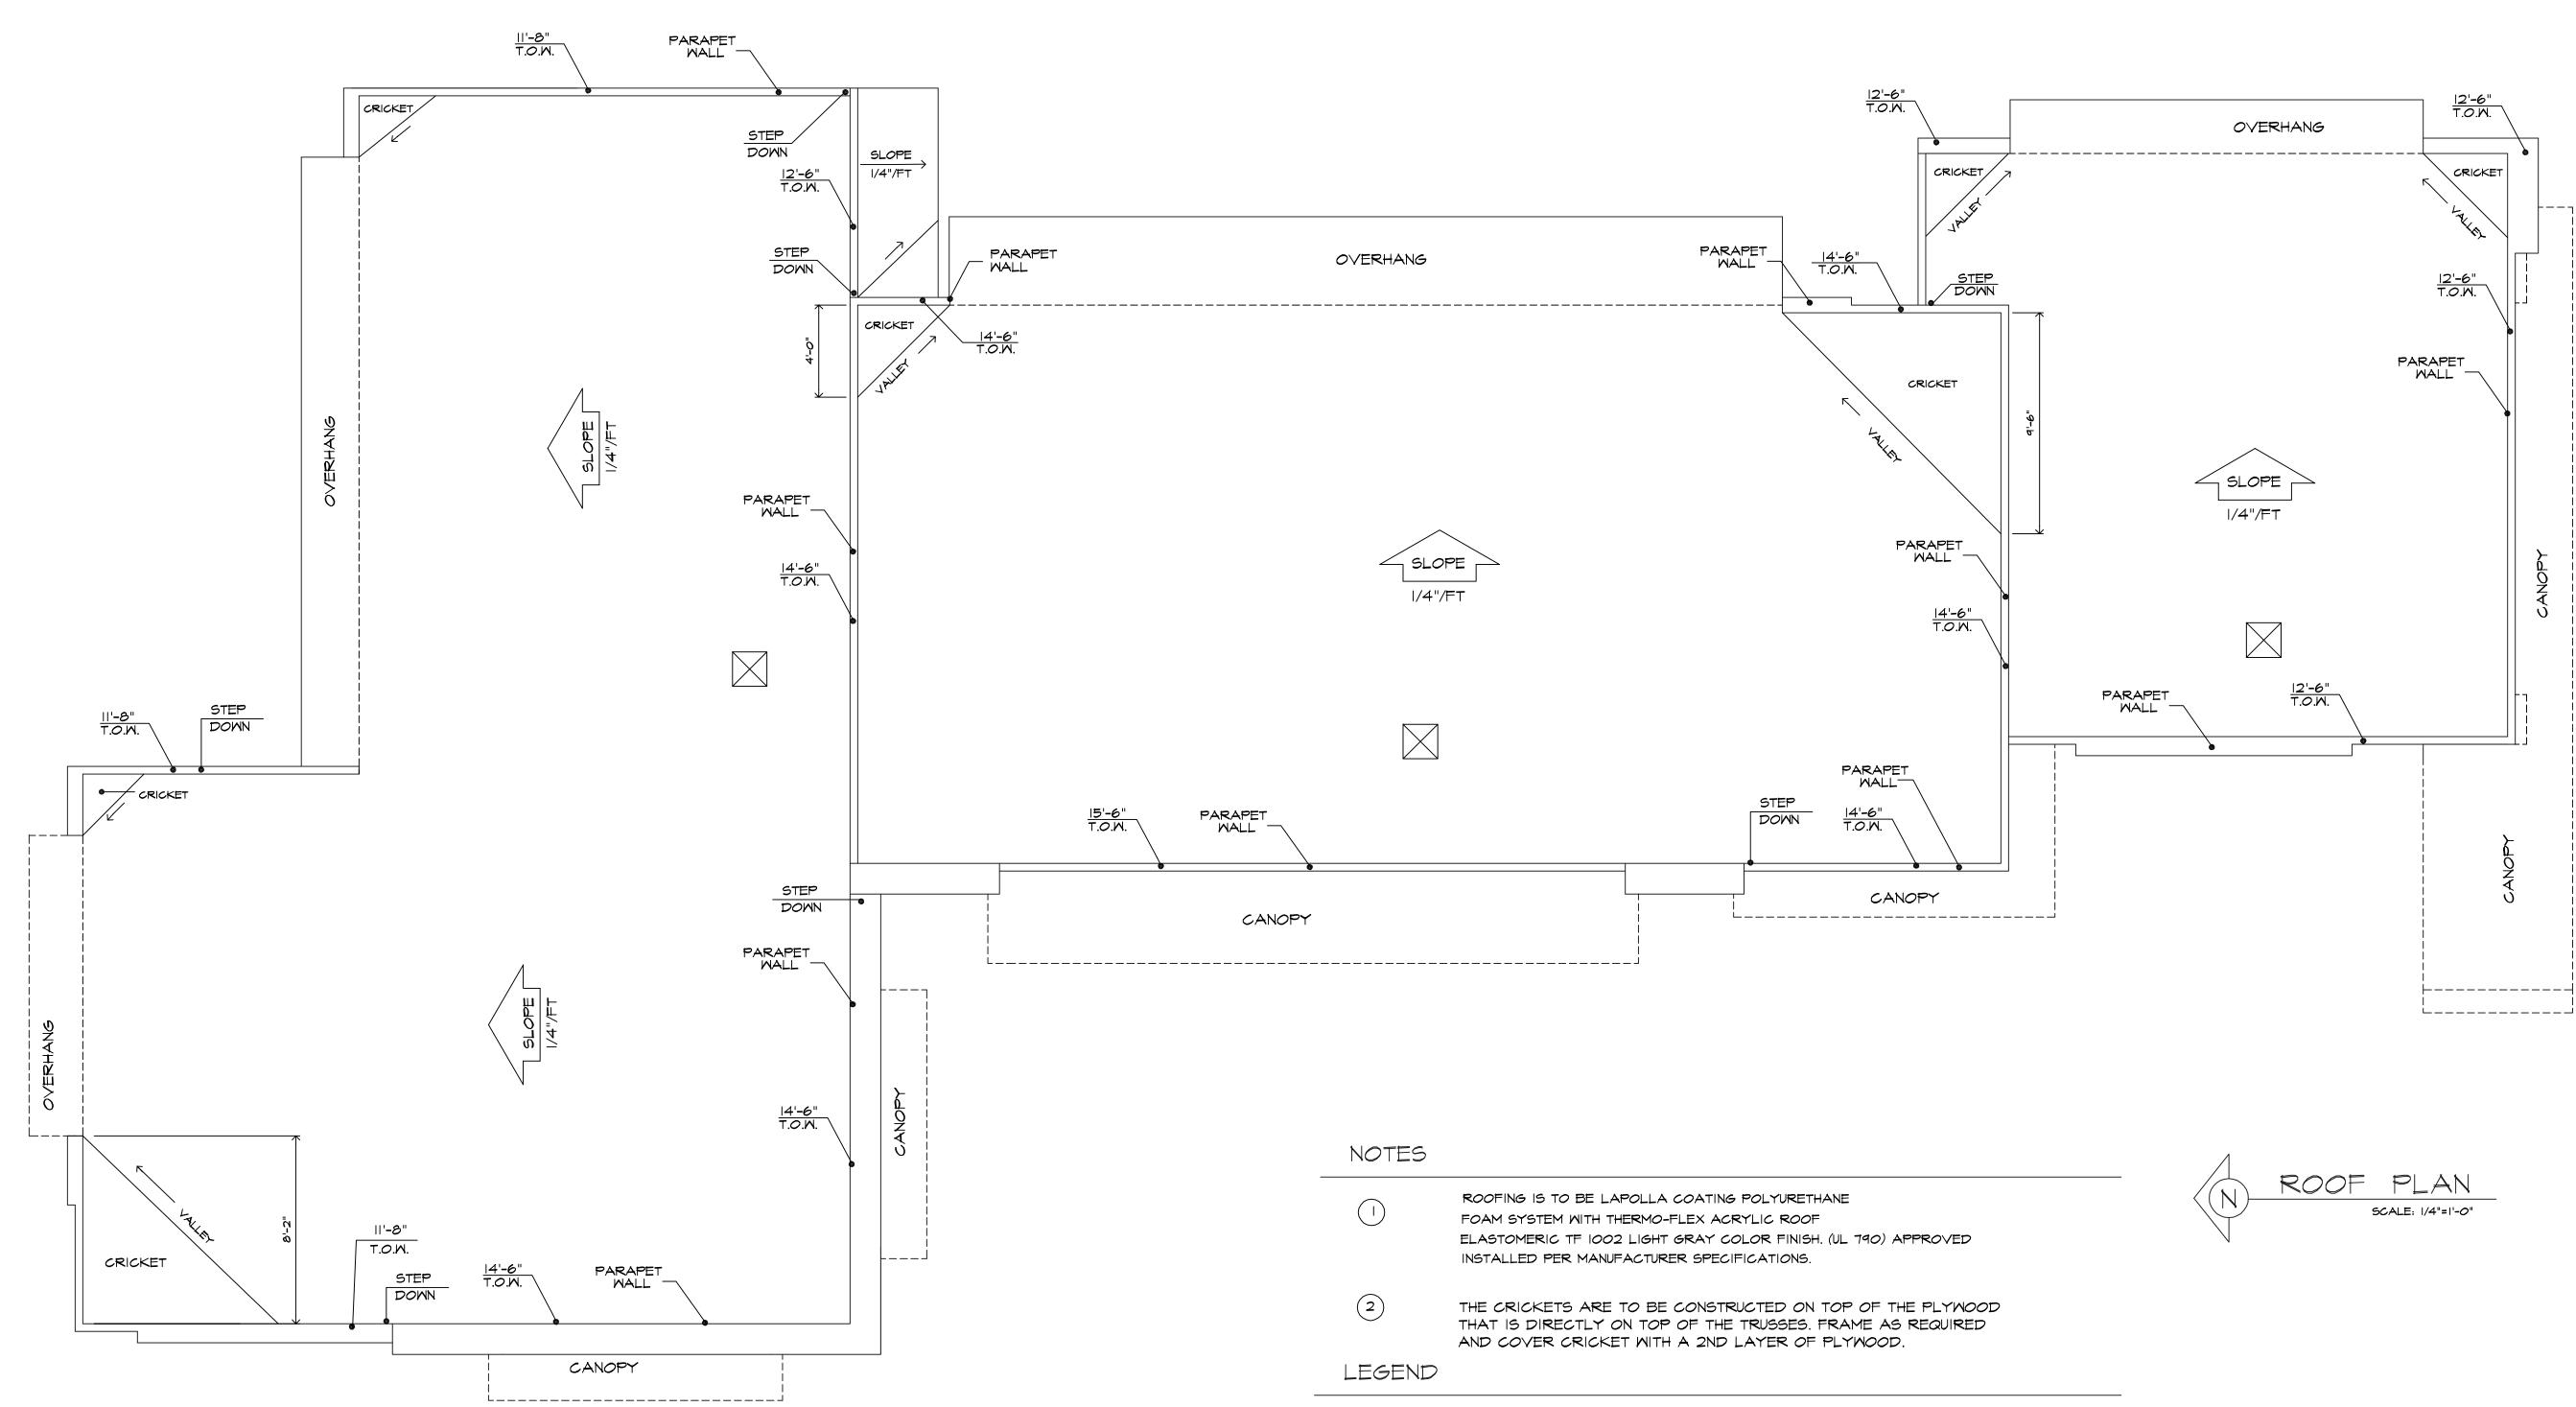

NOTES	
	ROOFING IS TO BE LAPOLLA COATING POLYURETHAN FOAM SYSTEM WITH THERMO-FLEX ACRYLIC ROOF ELASTOMERIC TF 1002 LIGHT GRAY COLOR FINISH. (INSTALLED PER MANUFACTURER SPECIFICATIONS.
2	THE CRICKETS ARE TO BE CONSTRUCTED ON TO THAT IS DIRECTLY ON TOP OF THE TRUSSES. FR AND COVER CRICKET WITH A 2ND LAYER OF P
LEGEND	
# T.O.R. #	ELEVATION AT TOP OF ROOF
TOW	

/ T.O.W. ELEVATION AT TOP OF PARAPET WALL \sum 14" × 14" × 8" ROOF VENTS

ATTIC VENTILATION

ATTIC AREA: 3,330 SQ. FT.

ATTIC VENTILATION REQUIRED: 3,330/300 XI44= 1,598 SQ.INCHES

ATTIC VENTILATION PROVIDED:

14" X 14" X 8" ROOF VENTS= 196 SQ. INCHES VENTILATION X 3 = 588 SQ INCHES VENTILATION 16" X 10" SCREENED & LOUVERED WALL VENTS = 160 SQ INCHES X 7 =1,120 INCHES VENTILATION TOTAL VENTILATION: 588 SQ. IN. +1,120 SQ. IN. =1,708 SQ. INCHES

He Designer: Owner: T Designer: Construction / Design T A. Alle AIN T Construction / Design T A. Alle T Construction T Consurver T
Market Designer: Designer: Construction / Design Revision Market Market Construction / Design Market Revision Market Market Construction / Design Market Revision Market Market Market Market Revision Market Market Market Market Revision Market Market Market Market Market
T DESIGNER: DESIGNER: DESIGNER: Construction / Design Construction / Design Name Value visita LLC. Name Value visita LLC. Name Linda aun Linda aun LIC.# 660445 T PROLECT ADDRESS: Prove (160) 409-1956 PHONE (160) 409-1956
Image: Design in the second
DESIGNER: DESIGNER: L.A. CONSTRUCTION / Design L.A. CONSTRUCTION / Design LINDA AUN LINDA AUN LIC. # 660445 NMOHS EV PHONE (760) 409-7956 PHONE (760) 409-7956 PHONE (760) 409-7956
TI: T: CONSTRUCTION / DOSIGNER: LA. CONSTRUCTION / DOSIGN LINDA AUN LINDA AUN LIC. # 660445 67-100 MEDANO RD., CATHEDRAL CITY, CA 92234 PHONE (160) 404-7956 PHONE (160) 404-7956
SCALE: AS SHOWN DRAWN BY: L.J.A.
DRAWN BY: L.J.A.
SHEET
5



SYMBOL	NAME		
		SIZE	QUANTITY
	HYBRID PALO VERDE TREE	24" BOX	6
\bigcirc	BOUGANVILLEA RED SHRUB	5 GAL	71
(YL)	YELLOW LANTANA	5 GAL	21
BP	MEXICAN BIRD OF PARADISE	5 GAL	5
OT	TECOMA STANS -ORANGE BELLS	5 GAL	н
LJ	LITTLE JOHN	5 GAL	5
	TECOMA VINE -YELLOW BELLS	15 GAL	<u>,</u> 41
\ast	MEXICAN GRASS TREE	15 GAL	17
*	AGAVE	5 GAL	ić
	MEDITERRANEAM FAN PAN	15 GAL	٩
R	RUSSELLIA	5 GAL	в
DG	BRIMSTONE DG		
GR	MOJAVE GOLD 3/4" GRAVEL		
	2"-4" GRAVEL		
Ŷ	BOULDERS- DESERT GOLD 20" TO 36" MAX, WIDTH	20" TO 36" MAX. WIDTH	
ACHELLA VAL .M SPRINGS U RECOMMENDE	I PING SHOULD BE CONSISTENT WITH THE R LEY WATER DISTRICT ORDINANCE 1302.1 A NDER ORDINANCE NO. 686 " WATER EFFICI ISD FOR THE LANDSCAPE MATERIALS: "LUSI DACHELLA VALLEY" BY THE COACHELLA N	AS ADOPTED BY ENT LANDSCAPE	THE CITY OF ORDINANCE"
	~		







FRONT ELEVATION Via Escuela



LEFT ELEVATION Sunrise Way



RIGHT ELEVATION



BACK ELEVATION