

# CITY OF PALM SPRINGS DEVELOPMENT SERVICES DEPARTMENT MEMORANDUM

Date: December 7, 2021

To: Architectural Review Committee

From: David A. Newell, AICP

Assistant Director, Planning Services

Subject: EPSTEIN GLOBAL FOR REVISIONS TO A MINOR ARCHITECTURAL

APPLICATION FOR A REMODEL OF AN EXISTING CANNABIS DISPENSARY LOCATED AT 4765 EAST RAMON ROAD, ZONE M-1

(CASE 3.4280 MAA) (RB)

On September 20, 2021, the Architectural Review Committee considered the subject application for a remodel of the existing cannabis dispensary and voted to recommend approval to City Council, subject to certain items (lighting, landscaping, handrails, etc.) returning to ARC for review. The application was scheduled for City Council consideration on October 14, 2021, when the matter was referred to the ARC for additional review to improve the exterior of the property. Based on this direction, Staff provided the applicant the following list of items to improve the project:

- 1. An updated landscape plan with additional plant materials.
- 2. A lighting plan with fixture details.
- 3. Enhancements to the building facades, which will be limited to the following at the recommendation of the ARC:
  - Front elevation (facing Ramon): Treatment of the boarded-up clerestory windows, replacement of existing light fixtures with decorative fixtures (while compliant with the outdoor lighting code), fascia treatment, principal building color and accent color, enhancement or replacement of awning.
  - West elevation (facing Williams): Treatment of the boarded windows (restucco or repair façade so that patchwork is less visible), paint treatment of exterior doors for consistency, conceal exposed conduit/piping on building exterior, signage treatment/placement (e.g., parking signage on building façade).

• East elevation: Replacement of existing light fixtures with decorative fixtures (while compliant with the outdoor lighting code), signage treatment/placement, conceal exposed conduit/piping.

In response, the applicant has submitted a revised package that includes landscape, roof, elevation, and lighting plans, along with details and specifications on the proposed lighting, awning and signage. An analysis on the proposed improvements based on the City Council direction is provided in the table below.

#	Additional Review Item	Proposed Revision
1	An updated landscape plan with additional plant materials.	The revised landscape and hardscape plans provide an enhanced visual and pedestrian experience of the front (Ramon) entry. Handrails will be installed. A lineal landscape design that includes Red Yuccas and Blue Rangers, is proposed within the planters. Two new pots with Agaves will flank the front entry platform. Fortnight Lilies will be planted against the building. All planter areas will include new ½"-1" pebble rock.
2	A lighting plan with fixture details.	New fully shielded fixtures are proposed to replace existing wall packs.
3	Enhancements to the building facades, which will be limited to the following at the recommendation of the ARC:	The applicant will remove or bury all exterior conduit and all existing stucco will be removed, repaired and painted light gray on all sides of the building. The building trim and fascia will be replaced as needed.
	Front elevation (facing Ramon): Treatment of the boarded-up clerestory windows, replacement of existing light fixtures with decorative fixtures (while compliant with the outdoor lighting code), fascia treatment, principal building color and accent color, enhancement or replacement of awning.	A new awning that is dark blue will replace existing green awning. In addition to the lighting and stucco repair/replacement/paint mentioned above, the front boarded-up clerestory windows will be removed, patched with new stucco and painted light gray.
	West elevation (facing Williams): Treatment of the boarded windows (re-stucco or repair façade so that patchwork is less visible), paint	In addition to the lighting and stucco repair/replacement/paint mentioned above, a boarded window will be patched with stucco.

#	Additional Review Item	Proposed Revision
	treatment of exterior doors for consistency, conceal exposed conduit/piping on building exterior, signage treatment/placement (e.g.,	
	parking signage on building façade).	
	East elevation: Replacement of existing light fixtures with decorative fixtures (while compliant with the outdoor lighting code), signage treatment/placement, conceal exposed conduit/piping.	See above for updates to the lighting, conduit and stucco that are also proposed on this elevation.

In addition, the applicant intends to continue the stucco repair on the south elevation by patching an existing door with stucco and painting to match the rest of the building.

Based on the above revisions, staff recommends the ARC approve the proposed exterior remodel as submitted.


### ATTACHMENTS:

- 1. Vicinity Map
- 2. 9/20/21 ARC Meeting Minutes (Excerpt)
- 3. Revised Plans



# Department of Planning Services Vicinity Map



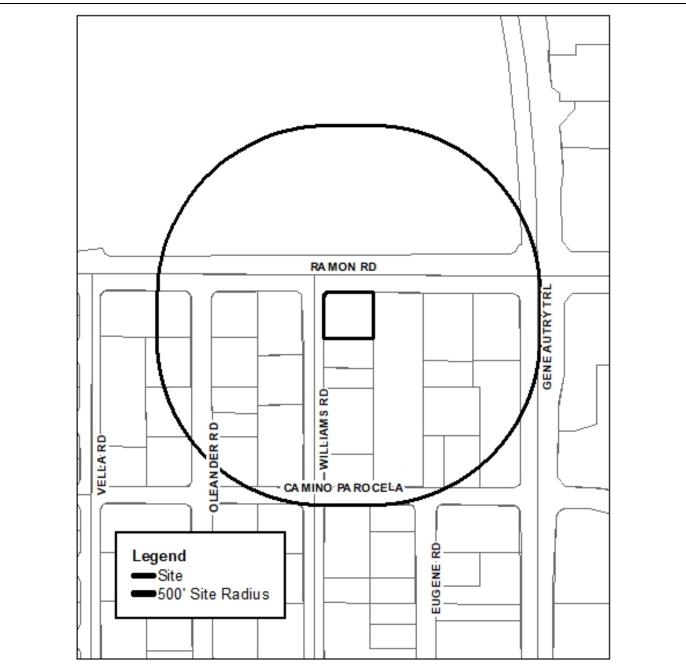

CITY OF PALM SPRINGS 4765 East Ramon Road Beyond Hello Cannabis Dispensary Vice Chair Rotman clarified which signage option was selected. Planner Perez responded option 3.

Rotman, seconded by Doczi to approve Items 1A and 1C, as part of the Consent Calendar.

AYES:

DOCZI, LOCKYER, WALSH, ROTMAN, JAKWAY

ABSENT:

MCCOY, POEHLEIN, THOMPSON

1A. APPROVAL OF MINUTES: AUGUST 30, 2021

Approved, as presented.

1C. EXOTIC EXTRACTIONS REQUESTING APPROVAL FOR A SIGN PERMIT TO INSTALL ONE MAIN SIGN TOTALING 20-SQUARE FEET TO BE PLACED ON AN EXISTING BUILDING LOCATED AT 1251 MONTALVO WAY, UNIT L (CASE 21-077 SI). (AP)

Approved, as presented.

### **EXCLUDED CONSENT CALENDAR:**

1B. EPSTEIN GLOBAL ARCHITECTURE ON BEHALF OF JUSHI PS HOLDINGS LLC, OWNER, REQUESTING A MINOR ARCHITECTURAL APPLICATION FOR TENANT IMPROVEMENTS AND EXTERIOR REPAINTING OF AN EXISTING CANNABIS DISPENSARY LOCATED AT 4765 EAST RAMON ROAD, ZONE M-1 (CASE 3.4280 MAA). (RB)

Planning Technician Bruno was experiencing technical difficulties and Assistant Director Newell recapped the proposed changes.

Member Lockyer asked if the replacement gates for the chain-link were along the cross street. (Assistant Director Newell responded the replacement gates are located on the south side of the property towards the rear.)

Chair Jakway and Member Lockyer verified if the applicant has submitted any landscape plans or lighting plans. (Assistant Director Newell stated that staff does not have any plans for lighting or landscape. He indicated the applicant may have additional information on what they intend to do with the exterior.)

ANDREW PAPPE, project architect, stated that the interior and the proposed exterior changes are the extent of Epstein Global part of the project. He indicated the new gate replacement is part of the proposal and replacement of the storefront window system

will match the existing window system. Mr. Pappe indicated there are no landscaping changes or exterior lighting changes proposed at this time.

Member Lockyer thinks this is the perfect opportunity to improve the landscaping which has fallen to disarray.

Member Doczi agreed with Member Lockyer, noting that this building is visible when exiting the airport and such a prominent location would benefit from landscape improvements.

Assistant Director Newell noted the ARC could impose as a requirement to add the landscaping to improve the exterior project. It would be appropriate to recommend approval with submittal and review of a landscape and lighting plan.

ANDREW PAPPE, project architect, stated the new owner intends to submit a landscape plan once the construction is done.

Chair Jakway clarified the process in Palm Springs is landscape plans are approved before construction can be approved.

Mr. Pappe stated they do not want to delay the process. He explained the landlord wants to improve the building and has requested such improvements. He thinks landscape plans will delay the construction of the project.

Assistant Director Newell stated staff will work with the applicant for submittal of the landscape plan prior to project going to City Council review and it will not interfere with the building permit process.

Chair Jakway verified if they could condition the occupancy permit not be granted until the landscape plan and lighting plan is approved and installed. Assistant Director Newell responded yes.

Member Doczi said the repair and repainting of the planter walls off Ramon Road have fallen into disrepair.

Chair Jakway noted the Building Code will require a handrail on the flank of stairs.

Lockyer, seconded by Doczi to approve with added conditions and return to ARC for review:

- 1. Lighting plan to include the building exterior and landscape.
- 2. Final landscape plan shall be submitted for ARC review.
- 3. Details of handrails for front entrance stairs and accessible ramp.
- 4. Details of entrance planter repair and repainting.

### GENERAL NOTES

- IT IS THE CONTRACTOR'S RESPONSIBILITY TO BE FAMILIAR WITH AND TO LOCATE ALL EXISTING SITE CONDITIONS AND UNDERGROUND UTILITIES, PIPES, AND OTHER SUBSTRUCTURES, AND PROTECT THEM FROM DAMAGE. THE EXPENSE OF REPAIR, BODILY INJURY OR REPLACEMENT OF SAID SUBSTRUCTURES INCLUDING DAMAGE OF THE OWNER'S PROPERTY SHALL BE BORN BY THE CONTRACTOR. THE CONTRACTOR SHALL HAND DIG FOOTINGS, TREE WELLS, PLANTING BEDS, ETC. AS REQUIRED. CONTRACTOR IS RESPONSIBLE FOR CONTACTING ALL RELEVANT UTILITY COMPANIES PRIOR TO ANY
- 2. LOCATION AND ELEVATION OF ALL EXISTING IMPROVEMENTS WITHIN AND ADJACENT TO THE AREA OF WORK SHALL BE CONFIRMED BY FIELD MEASUREMENT PRIOR TO EXCAVATION AND CONSTRUCTION OF NEW WORK. EXTREME CARE SHALL BE EXERCISED IN EXCAVATION AND WORKING NEAR EXISTING UTILITIES. CONTRACTOR WILL MAKE EXPLORATIONS FACAVATIONS AND LOCATE EXISTING UNDERGROUND UTILITIES, PIPES AND OTHER SUBSTRUCTURES SUFFICIENTLY AHEAD OF CONSTRUCTION TO PERMIT REVISIONS TO PLANS, DETAILS AND SPECIFICATIONS IF REVISIONS ARE NECESSARY BECAUSE OF ACTUAL LOCATION IN THE FIELD. THE LOCATIONS OF UTILITIES, STRUCTURES AND SERVICES SHOWN IN THESE PLANS ARE APPROXIMATE ONLY, ANY DISCREPANCIES BETWEEN THESE PLANS AND ACTUAL EFFILED. THE LOTATIONS SHALL BY EMPRIFIED TO THE PERSIPATE REQUIRED. FIELD CONDITIONS SHALL BE IMMEDIATELY REPORTED TO THE RESIDENT ENGINEER.
- 3 THE CONTRACTOR SHALL PROTECT ALL EXISTING LITHLITES LANDSCAPING AND FEATURES TO REMAIN ON AND/OR ADJACENT TO THE PROJECT SITE DURING CONSTRUCTION. CONTRACTOR SHALL REPAIR, AT HIS OWN EXPENSE, ALL DAMAGE RESULTING FROM HIS OPERATIONS OR NEGLIGENCE.
- 4. THE CONTRACTOR SHALL BE SOLELY RESPONSIBLE TO ENFORCE SAFETY MEASURES AND REGULATIONS.
- 5. IN AN EMERGENCY THREATENING THE SAFETY OF LIFE, WORK OR ADJOINING PROPERTY, THE CONTRACTOR SHALL USE HIS DISCRETION TO PREVENT SUCH LOSS OR INJURY
- 6 THE CONTRACTOR SHALL NOT WILLFULLY PROCEED WITH CONSTRUCTION OF DESIGN WHEN LINKNOWN OBSTRUCTIONS AND/OR GRADE DIFFERENCES EXIST THAT MAY NOT HAVE BEEN KNOWN DURING DESIGN. 
  SUCH CONDITIONS SHALL BE IMMEDIATELY BROUGHT TO THE ATTENTION OF THE OWNER'S AUTHORIZED 
  REPRESENTATIVE AND OWNER. THE CONTRACTOR SHALL ASSUME FULL RESPONSIBILITY FOR ALL 
  NECESSARY REVISIONS DUE TO FAILURE TO GIVE SUCH NOTIFICATION.
- CONTRACTOR SHALL BE RESPONSIBLE FOR COORDINATION OF THE SUBCONTRACTOR'S ACCOMPLISHMENT OF SCOPE OF WORK. CONTRACTOR SHALL COORDINATE CONSTRUCTION WITH OTHER TRADES WORKING ON THE SITE SIMULTANEOUSLY.
- CONTRACTOR SHALL NOTIFY OWNER'S AUTHORIZED REPRESENTATIVE 72 HOURS PRIOR TO COMMENCEMENT OF WORK TO COORDINATE PROJECT INSPECTION SCHEDULES. CONTRACTOR SHALL TURNISH ALL LABOR, MATERIALS, EQUIPMENT, AND SERVICES NECESSARY TO PROVIDE ALL WORK. WORK TO BE COMPLETE IN PLACE AS SPECIFIED.
- THE CONTRACTOR WILL BE BACKCHARGED FOR THE ARCHITECT'S TIME SHOULD THE WORK BEING OBSERVED BE FOUND INCOMPLETE OR NOT READY FOR REMEW; OR IF THE MEETING TIME IN NOT KEPT BY THE CONTRACTOR.
- 10. CONTRACTOR IS RESPONSIBLE FOR SETTING GRADES ON ALL HARD AND SOFT SURFACES. CONTRACTOR SHALL BE RESPONSIBLE FOR POSITIVE DRAINAGE FROM HARD SURFACES FOR THIS PROJECT. EXISTING DRAINAGE SHALL BE PROTECTED IN PLACE DURING CONSTRUCTION.
- 11. ALL MATERIALS SHALL BE OF STANDARD, APPROVED AND FIRST GRADE QUALITY AND SHALL BE IN PRIME CONDITION WHEN INSTALLED AND ACCEPTED. ANY COMMERCIALLY PROCESSED OR PACKAGED MATERIAL SHALL BE DELIVERED TO THE SITE IN THE ORIGINAL UNOPENED PACKAGING BEARING THE MANUFACTURER'S GUARANTEED ANALYSIS.
- 12 THE CONTRACTOR AGREES TO HOLD THE CITY AND THE A/E HARMLESS FROM ANY CLAIMS ARISING OUT OF HIS OPERATIONS OR THE OPERATIONS OF ANY OF HIS SUBCONTRACTORS, MATERIALS SUPPLIERS, OR AGENTS.
- 13. THE CONTRACT DRAWINGS DO NOT INDICATE METHODS, PROCEDURES, OR SEQUENCE OF CONSTRUCTION. THE CONTRACTOR SHALL TAKE THE NECESSARY PRECAUTIONS TO MAINTAIN THE INTEGRITY OF STRUCTURES DURING CONSTRUCTION. THE CONTRACTOR IS RESPONSIBLE FOR THE DESIGN, CONSTRUCTION, AND MAINTENANCE OF ALL SAFETY DEVICES, INCLUDING SHORING AND BRACING.
- 14. ALL LOCAL, MUNICIPAL, AND STATE LAWS, RULES AND REGULATIONS GOVERNING OR RELATING TO ANY PORTION OF THIS WORK ARE HEREBY INCORPORATED INTO AND MADE A PART OF THE PROJECT SPECIFICATIONS AND THEIR PROVISIONS SHALL BE CARRIED OUT BY THE CONTRACTOR. THE CONTRACTOR IS RESPONSIBLE FOR THE ENFORCEMENT OF FEDERAL AND MUNICIPAL OCCUPATIONAL SAFETY AND HEALTH REGULATIONS AND REQUIREMENTS.
- 15. THE CONTRACTOR SHALL FURNISH ALL MATERIALS, LABOR, TRANSPORTATION, SERVICES, AND EQUIPMENT NECESSARY TO INSTALL THE LANDSCAPE CONSTRUCTION ITEMS AS SHOWN ON THE DRAWINGS AND AS SPECIFIED HEREIN.
- 16. ALL FEDERAL, STATE, AND LOCAL LAWS AND REGULATIONS GOVERNING THIS WORK ARE HEREBY INCORPORATED INTO AND MADE PART OF THESE PLANS, WHEN THESE PLANS CALL FOR CERTAIN MATERIALS, WORKMANSHIP, OR A LEVEL OF CONSTRUCTION THAT EXCEEDS THE LEVEL OF FEDERAL, STATE, OR LOCAL REQUIREMENTS, THE PROVISIONS OF THESE PLANS WILL TAKE PRECEDENCE.
- 17 THE CONTRACTOR SHALL BE RESPONSIBLE TO OBTAIN AND PAY FOR ANY AND ALL PERMITS FEES ONDS AND OBSERVATIONS NECESSARY TO PERFORM AND COMPLETE HIS PORTION OF THE WOR
- 18. WORK DEFECTIVE IN CONSTRUCTION, QUALITY, PERFORMANCE OR DEFICIENT IN ANY REQUIREMENTS OF THE CONTRACT DOCUMENTS WILL NOT BE ACCEPTED IN CONSEQUENCE OF THE OWNER'S OR THE ARCHITECT'S FAILURE TO DISCOVER OR POINT OUT SUCH DEFECTS OR DEFICIENCIES DURING CONSTRUCTION. DEFECTIVE WORK REVEALED WITHIN THE TIME REQUIRED BY GUARANTEES OR WARRANTIES SHALL BE REPLACED BY WORK CONFORMING WITH THE INTENT OF THE CONTRACT DRAWINGS AND SPECIFICATIONS. NO PAYMENT EITHER PARTIAL, OR FINAL, SHALL BE CONSTRUED AS AN ACCEPTANCE OF DEFECTIVE WORK OR IMPROPER MATERIAL.
- 19. ALL SITE OBSERVATIONS REQUESTED OF THE ARCHITECT BY THE CONTRACTOR SHALL BE DONE SO THROUGH THE OWNER'S REPRESENTATIVE AND SHALL PROVIDE THE ARCHITECT WITH A MINIMUM OF 72
- 20. ALL TERMS AND PROVISIONS OF THE LANDSCAPE SPECIFICATIONS ARE HEREBY INCORPORATED BY REFERENCE HEREIN AND MADE A PART OF THESE DRAWINGS. REFER TO LANDSCAPE SPECIFICATIONS

### GRADING NOTES

1. HOLD FINISHED GRADES FOR SHRUB AND GROUNDCOVER AREAS 3 INCHES BELOW TOP OF ADJACENT PAVEMENT, CURBS, OR HEADERS UNLESS OTHERWISE NOTED ON THE DRAWING

### PEBBLE MULCH NOTE

- 1. TOPDRESS PEBBLE MULCH: 3 INCH OF PEBBLE MULCH FROM SOUTHWEST BOULDER & STONE, (760) 328-5877. REFERENCE MATERIALS LEGEND FOR PEBBLE MULCH TYPE AND SIZIN
- 3 INCHES OF PEBBLE MULCH LAYER SHALL BE APPLIED ON ALL EXPOSED SOIL SURFACES OF PLANTING AREAS EXCEPT IN OVER CREEPING OR ROOTING GROUNDCOVERS, OR IN DIRECT SEEDING APPLICATIONS WHERE MULCH IS NOT APPROPRIATE.

### WATER CONSERVATION STATEMENT:

THE LANDSCAPE DESIGN FEATURES LOW WATER USE PLANTS SELECTED EXCLUSIVELY FROM THE REVISED THE DAVISORARE PLISTOR PERIODS OF WINDER OF PERIODS SELECTED ACCORDED FROM THE ROSED EDITION OF THE "LUSH AND EFFICIENT LANDSCAPE GARDENING IN THE COACHELLA VALLEY" PUBLISHED BY THE COACHELLA VALLEY WATER DISTRICT. THE DESIGN ALSO FEATURES 3" OF GRAVEL MULCH MATERIAL AND POINT SQUECE DRIP EMITTERS WITH A FULLY AUTOMATIC IRRIGATION SYSTEM CONTAINING A WEATHER BASED CONTROLLER.

### PLANTING NOTES

- PROVIDE MATCHING SIZES AND FORMS FOR EACH SPECIES OF SHRUB INSTALLED ON GRID OR SPACED EQUALLY IN ROWS AS SHOWN ON DRAWINGS. ALIGN SHRUBS ACROSS WALKS. ADJUST SPACING AS NECESSARY, SUBJECT TO REVIEW BY THE LANDSCAPE ARCHITECT OR OWNER'S REPRESENTATIVE.
- LANDSCAPE WORK SHOWN ON THESE PLANS SHALL BE PERFORMED BY A SINGLE CONTRACTOR SPECIALIZING IN LANDSCAPE PLANTING WITHIN THE PALM SPRINGS AREA.
- 3. PLANT NAMES ARE ABBREVIATED ON THE DRAWINGS. SEE PLANT LIST FOR KEY AND CLASSIFICATION
- 4. ALL PLANTING AREAS SHALL DRAIN A MINIMUM OF 2% AWAY FROM THE BUILDING AND OTHER VERTICAL STRUCTURES UNLESS OTHERWISE SPECIFIED ON THE PLANS. GRADE SHALL BE EVEN AND SMOOTH WITH NO BERMS OR SWALES UNLESS OTHERWISE NOTED ON THE PLANS. CONTRACTOR TO GRADE TOWARDS EXISTING DRAINAGE AT A MINIMUM OF 2%.
- THE CONTRACTOR SHALL FURNISH ALL MATERIALS, LABOR, TRANSPORTATION, SERVICES & EQUIPMENT NECESSARY TO INSTALL LANDSCAPE PLANTING AS SHOWN ON THE DRAWINGS & AS SPECIFIED HEREIN.
- 6. AFTER FINISH GRADES HAVE BEEN ESTABLISHED FOR PLANTING AREAS, THE LANDSCAPE CONTRACTOR SHALL TAKE HORTICULTURAL SOIL SAMPLES AT FOUR (4) LOCATIONS AROUND THE SITE. SOIL SAMPLES SHALL BE TESTED BY WALLACE LABORATORIES (WWW.WLABS.COM) FOR SOIL FERTILITY. AGRICULTURAL SUITABILITY, AND SOIL PREPARATION RECOMMENDATIONS, TESTS SHALL BE PROVIDED BY THE LANDSCAPE CONTRACTOR AND SUBMITTED TO THE LANDSCAPE ARCHITECT AND OWNER'S REPRESENTATIVE PRIOR TO ANY PLANTING. CONTRACTOR SHALL PROVIDE AN ADDITIONAL FOUR (4) SOIL TESTS TO CONFRM AMENDMENTS HAVE BEEN APPLIED PER THE RECOMMENDATIONS. SEE SOIL TESTING NOTES #2, SOIL TESTING NOTES #2, SOIL TESTING ROBORD TO THE PRIOR TO THE PRIOR TO THE STING ROBORD TO TH
- 7. THE CONTRACTOR SHALL PERFORM SOIL PERCOLATION TESTS PER SOIL TESTING AND SOIL AMENDMENT
- THE CONTRACTOR SHALL ENSURE THAT FINAL FINISH GRADE ELEVATIONS OF PLANTING AREAS ARE SET AT PROPER ELEVATIONS RELATIVE TO PAVING FINISH SURFACE ELEVATIONS, UTILITY COVERS & CURBS.
- THE CONTRACTOR SHALL BE RESPONSIBLE TO FURNISH PLANT MATERIAL FREE OF PESTS, POOR CONDITION, OR DISEASE, INCLUDING ANY PRE-SELECTED OR PRE-TAGGED PLANT MATERIAL PROVIDED BY THE OWNER.
- 10. THE CONTRACTOR SHALL GUARANTEE ALL WORK AS TO PLANT MATERIAL & WORKMANSHIP FOR A PERIOD OF ONE YEAR FOLLOWING THE DATE OF FINAL ACCEPTANCE OF PROJECT. THE CONTRACTOR SHALL PROVIDE A WRITTEN GUARANTEE ON COMPANY LETTERHEAD AT THE FINAL INSPECTION.
- 11 THE CONTRACTOR SHALL PROVIDE A WRITTEN CERTIFICATION THAT THE PLANTING WORK IS INSTALLED IN FRULL COMPLIANCE WITH THE CONTRACT DOCUMENTS. ANY APPROVED SUBSTITUTIONS OF DEVIATIONS
  FROM THE PLANS SHALL BE NOTED. THIS CERTIFICATION SHALL BE ON THE CONTRACTOR'S LETTERHEAD WITH HIS/HER SIGNATURE & CALIFORNIA C-27 CONTRACTOR'S LICENSE NUMBER.
- 12. ALL PLANTING AREAS (EXCEPT TURF AND SLOPES GREATER THAN 2:1) SHALL HAVE A 3" LAYER OF SPECIFIED MULCH. REFER TO MULCH NOTES.

### ESTABLISHMENT PERIOD NOTES

- CONTRACTOR TO PROVIDE A 90-DAY ESTABLISHMENT PERIOD AFTER WRITTEN APPROVAL BY THE OWNER
  OF SATISFACTORY COMPLETION OF ALL ITEMS INCLUDED ON THE LANDSCAPE PUNCH LIST.
- 2. CONTRACTOR TO PROVIDE HAND WATERING FOR NEW PLANTING TO ESTABLISH THE PLANTS ROOT SYSTEM UNTIL IRRIGATION SYSTEM IS FULLY OPPERATIONAL. CONTRACTOR SHALL MONITOR SOIL MOISTURE TO ENSURE PLANTS HAVE ADEQUATE WATER AND ADJUST WATERING SCHEDULE AS NEEDED.
- 3. CONTRACTOR SHALL IMMEDIATELY TREAT OR REPLACE PLANT MATERIAL WHICH HAS BECOME DAMAGED OR DISEASED AT NO ADDITIONAL COST TO THE OWNER AT A MATCHING SIZE AND VARIETY OF THE PLANT BEING REPLACED.
- 4. CONTRACTOR TO USE A WATER WAND FOR HAND WATERING TO BREAK THE WATER FORCE. "JET" TYPE WATERING EQUIPMENT SHALL NOT BE PERMITTED. CONTRACTOR SHALL ENSURE THAT THE PLANTS
  CROWN ROOTS DO NOT BECOME EXPOSED TO THE AIR THROUGH THE DISLODGING OF SOIL AND MULCH.
- CONTRACTOR TO RESET/REPLANT SUNKEN OR SETTLED PLANT MATERIALS TO PROPER GRADES AND IN AN UPRIGHT POSITION DURING THE ESTABLISHMENT PERIOD.
- 6. PLANTING AREAS THROUGHOUT THE PROJECT AREA SHALL BE WEED-FREE AT ALL TIMES, INCLUDING AREAS BETWEEN PLANTS.

ROAD

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LANDSCAPE ILLUSTRATIVE

### SOIL TESTING AND SOIL AMENDMENT NOTES

- AFTER FINISH GRADES HAVE BEEN ESTABLISHED FOR PLANTING AREAS, THE LANDSCAPE
  CONTRACTOR SHALL CONTACT WALLACE LABORATORIES AT (310) 615-016. TO TAKE SOIL TEST
  CAMPIES FORM LOCAL POLICY FOR THE STATE OF THE STA AFTER TINISH GRAZES HAVE BEEN ESTABLISHED FOR PLANTING AREAS, THE LANDSLAFE CONTRACTOR SHALL CONTACT MULLACE LABORATORIES AT (310) 615-0116 TO TAKE SOIL TEST SAMPLES FROM LOCATIONS AROUND THE SITE AS DIRECTED BY THE LANDSLAPE ARCHITECT. SOIL SAMPLES SHALL BE TAKEN IN EACH PLANTING AREA AT TWO DIFFERENT DEPTHS. SAMPLE 1 SHALL BE TAKEN AT A DEPTH OF 12"-24" AND SAMPLE 2 SHALL BE TAKEN AT A DEPTH OF SHALL BE LAKEN ALA DEPHLOF 12"—24" AND SAMPLE 2 SHALL BE LAKEN ALA DEPHLOF 24"—36". REPEAT AT ADJACENT PLANTING AREA, FOUR SAMPLES IN TOTAL IF THE CONTRACTOR WISHES TO TAKE SAMPLES THEMSELVES, THEY CAN BE MAILED INTO THE LABORATORY PER THE INSTRUCTION ON WALLACE LABORATORIES WEBSITE. MAKE SURE TO ADD LABEL TO THE PACKAGE MIDICATING "ONTENTS INCLUDE AGRICULTURAL SOIL SAMPLES FOR TESTING" AFTER THE PROPER DEPTH HAS BEEN EXCAVATED, SCRAPE THE SIDES OF THE HOLE TO GET A HOMOGENEOUS MIX OF THE SOIL FROM THE 12" DEPTH PROFILE. FILL A 1—GALLON SIZE ZIPLOCK BAG AND LABEL THE DEPTH AND LOCATION. REPEAT FOR THE SECOND 12" DEPTH PROFILE AND PLACE CONTENTS INTO A SEPARATE I—GALLON ZIPLOCK BAG.
- ALL TESTS MUST INCLUDE A ph MEASUREMENT IN THE SATURATION EXTRACT, ELECTRICAL CONDUCTIVITY OF THE SATURATION EXTRACT, SODIUM ADSORPTION RATIO OF THE SATURATION EXTRACT, SOIL ORGANIC MATTER QUALITY, SOIL TEXTURE, AND WATER PERCOLATION RATE. THE APPROVED PROCEDURES INCLUDE:

SATURATION EXTRACT SODIUM ADSORPTION RATIO METHOD 20b

- THE "AMERICAN SOCIETY OF AGRONOMY: AS PUBLISHED IN THE METHODS OF SOIL ANALYSIS. THE "AMERICAN SOCIETY OF AGRONOMY: AS PUBLISHED IN THE METHODS OF SOIL ANALYSIS, "METHODS OFTHE UNITED STATES SALINITY LABORATORY" AS PUBLISHED IN THE AGRICULTURAL HANDBOOK NUMBER 60 ENTITLED "DIAGNOSIS AND IMPROVEMENT OF SALINE AND ALKAL SOILS." BASE SATURATION — METHODS IS AND 20 OF AGRICULTURAL HANDBOOK NUMBER 60. ACTION EXCHANGE CAPACITY — METHODS IS AND 20 OF AGRICULTURAL HANDBOOK NUMBER 60. MEHLICH III TESTING METHOD IS NOT SUITABLE FOR ALKALINE SOILS AND THEREFORE IS NOT AN ACCEPTABLE TISTING METHOD FOR SOUTHERN CALIFORNIA. THE APPROVED METHODS FOR THOSE CITED BY THE COUNCIL ON SOIL TESTING AND PLANT ANALYSIS AND THOSE METHODS CURRENITLY PUBLISHED BY SOIL SCIENCE SOCIETY OF AMERICA MANUALS, COMMUNICATIONS IN SOIL SCIENCE AND PLANT ANALYSIS, SOILS SCIENCE AND SOIL SCIENCE SOCIETY OF AMERICA JOURNAL APPROVED METHODS FOR THOSPHORUS ARE BRAY P1, BRAY P2, OLSEN P, DTPA, AMMONIUM ACETATE, AND AMMONIUM BICARBONATE—DTPA.

  APPROVED METHODS FOR BORON ARE HOT WATER EXTRACT AND AMMONIUM BICARBONATE—DTPA EXTRACT.

- THE SATURATION EXTRACT MUST BE ANALYZED FOR CALCIUM, MAGNESIUM, SODIUM, BORON, CHLORIDE, PHOSPHORUS, NITRATE AND SULFATE.
- 5. THE PRESENCE OF CALCIUM CARBONATE AND/OR MAGNESIUM CARBONATE MUST BE DETERMINED
- THE PRESENCE OF EXCHANGEABLE AMMONIUM, EXCHANGEABLE HYDROGEN, BASE SATURATION, EXCHANGEABLE POTASSIUM, CALCIUM, MAGNESIUM, AND SODIUM MUST BE DETERMINED.
- 7. SOIL TEXTURE: (GRAVEL, SAND, SILT AND CLAY) AND PERCENT GRAVEL. THIS ITEM MUST BE
- 8. DETERMINE ORCANIC MATTER CONTENT BY THE MEASUREMENT OF ORGANIC CARBON. THE QUALITY OF THE ORGANIC MATTER SHALL BE DETERMINED BY MEASURING ORGANIC CARBON AND TOTAL NITROGEN. THIS ITEM MUST BE SPECIFICALLY REQUESTED.
- 9. INTERPRETATION OF NUTRITION DEFICIENCIES OR EXCESSES POTENTIAL TOXICITIES MUST BE
- 10. ALL SOIL TEST SHALL INCLUDE WATER INFILTRATION RATE: METHOD 346 OF AGRICULTURAL HANDBOOK NUMBER 60. THIS ITEM MUST BE SPECIFICALLY REQUESTED.
- 11. THE AMENDMENTS AND QUANTITIES INCLUDED HEREIN ARE APPROXIMATE AND ARE FOR BIDDING PURPOSES ONLY. FOLLOWING AN ON-SITE SOIL ANALYSIS BY THE PROJECT AGRONOMIST AFTER FINAL GRADES ARE ESTABLISHED, COMPOSITION OF AMENDMENTS MAY CHANGE. CONTRACT PRICE SHALL BE ADJUSTED ACCORDINGLY.
- 12. THE CONTRACTOR SHALL PERFORM SOIL PERCOLATION TESTS IN SELECTED REPRESENTATIVE AREAS OF THE PROJECT SITE TO VERIFY ACCEPTABLE NATURAL DRAINAGE, SOIL STRUCTURE, AND SOIL COMPOSITION. EACH PERCOLATION TEST SHALL CONSIST OF A 2 FOOT WIDE BY 2 FOOT LONG BY 4 FOOT DEEP HOLE. EACH HOLE SHALL BE FILLED WITH WATER TO THE TOP AND COVER WITH PLYWOOD AND BARRICADE. ALLOW HOLE TO DRAIN AND FILL AGAIN TO TOP. CONTRACTOR TO MAKE DAILY OBSERVATIONS NOTING THE DEPTH OF WATER EACH DAY AND REPORT FINDINGS IN WRITING TO THE LARDISCAPE ARCHITECT OR OWNER'S REPRESENTATIVE. BASED ON THE COMBINED RESULTS OF THE AGRICULTURAL SOIL ITEST AND THE SOIL PERCOLATION TESTS, THE CONTRACTOR MAY BE REQUIRED TO INSTALL ADDITIONAL DRAINAGE. WATER SHOULD BE COMPLETELY DRAINED, WITHIN 24 HOURS BE COMPLETELY DRAINED WITHIN 24 HOURS.
- 13. CONTRACTOR SHALL ENSURE COMPOST DRAINS AT A RATE OF MINIMUM OF (4) FOUR CUBIC YARDS PER ONE THOUSAND SQUARE FEET OF PERMEABLE AREA INCORPORATED TO A DEPTH OF (6) SIX INCHES INTO THE SOIL, UNLESS OTHERWISE INDICATED IN THE SOILS REPORT

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RAMON ROAD

### CONTACT:

PRINCIPAL: KEVIN SLAWSON : KSLAWSON@EDGELANDSTUDIO.COM P: 213,596,8299

PROJECT MANAGER: JIMMY TA .ITA@FDGFLANDSTLIDIO.COM P: 213.596.8299

### **ABBREVIATIONS**

B.O.C.	BACK OF CURB	F.O.C.	FACE OF CURB
CL	CENTER LINE	F.O.W.	FACE OF WALL
EL.	ELEVATION	F.S.	FINISH SURFACE
EG	EXISTING GRADE	L.O.W.	LIMIT OF WORK
EJ	EXPANSION JOINT	PA	PLANTING AREA
EOP	EDGE OF PAVING	PL	PROPERTY LINE
EQ.	EQUAL	R	RADIUS
EXT	EXISTING	SJ	SAWCUT JOINT
E/W	EACH WAY	TW	TOP OF WALL
F.G.	FINISH GRADE	TYP.	TYPICAL

LO.01 - LANDSCAPE NOTES & SHEET INDEX

LO.02 - MATERIALS & PLANTING LEGEND

11.01 - MATERIALS & LAYOUT PLAN

L1.02 - PLANTING PLAN

L1.04 - LANDSCAPE DETAILS



edge

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Culver City, California 90232

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GLASIR DESIGN (IRRIGATION DESIGNER) 424 New Jersey Lane Placentia, CA 92870 Phone: 714–514–9930

4765 E. RAMON RD. PALM SPRINGS, CA 92264

213.596.8299

CONSULTANTS:

OWNER: BEYOND/HELLO

CLIENT:

PROJECT:

EPSTEIN GLOBAL

CHICAGO, IL 60661

BEYOND/HELLO

PALM SPRINGS, CA 92264

ADDRESS: 4765 E. RAMON RD

PROJECT NUMBER:

PHASE: DATE: 11.29.2021 SCALE:

SHEET TITLE:

LANDSCAPE NOTES AND SHEET INDEX

SHEET NUMBER: NOT FOR CONSTRUCTION

L0.01

### SHEET INDEX

L1.03 - LANDSCAPE DETAILS

L2.01 - IRRIGATION PLAN

L2.02 - IRRIGATION DETAILS

SCALE: 1/8" = 1'-0"

\*\*\*\*\*\*\*\*\*\*

### MATERIALS LEGEND

PV-3 PEBBLE MULCH TYPE 2

NEW HANDRAILS AT EXISTING STAIRS

(SF-1)

PAVING LEGEND

KEY ITEM MATERIAL COLOR FINISH DETAIL(S) REMARKS FACTORY POWDER 1 / COATED FINISH L1.04 PV-1) STEEL EDGE FACTORY POWDER COATED BLACK -----MANUF: SOUTHWEST BOULDER MODEL: MEXICAN SUNBURST PEBBLE PV-2 PEBBLE MULCH TYPE 1 MEXICAN BEACH PEBBLE-BUFF 1-3 / L1.04 SIZE: 1/2"-1"

MEXICAN BEACH PEBBLE-BLACK

SIZE: 1"-2"

MATTE FINISH

1-4 / L1.03

REMARKS

MANUF: SOUTHWEST BOULDER MODEL: MEXICAN BEACH PEBBLE

SITE FURNISHING LEGEND DETAIL(S) FINISH KEY ITEM MANUFACTURER/MATERIAL COLOR

MANUF: OLD TOWN FIBERGLASS BLUE MODEL: KB3813 - 38" O.D. SF-2 PLANTER POT MATTE FINISH

MATERIAL: STAINLESS STEEL

### PLANTING LEGEND

KEY SYMBOL BOTANICAL NAME COMMON NAME SIZE SPACING MINIMUM SIZE FORM/BRANCHING DETAIL REF. REMARKS/COMMENTS SHRUBS & GROUNDCOVER FULL/SYMMETRICAL IN NURSERY CONTAINER; PREMIUM SELECT GRADE; DENSE GROWTH; WELL-ROOTED; FREE OF ANY BLEMISHES, SCARS OR DEAD GROWTH AT ENDS WITHOUT STALKS/TRUNKS AGA GEM (AG) AGAVE GEMINIFLORA TWIN-FLOWERED AGAVE STANDARD 1 GAL 36" O.C. TRIANGULAR SPACED DIE GRA (DG) DIETES GRANDIFLORA STANDARD 1,2,4 / L1.04 FORTNIGHT LILY 5 GAL HES PAR (HP) HESPERALOE PARVIFLORA 'BRAKELIGHTS' 30" O.C. TRIANGULAR SPACED BRAKELIGHTS RED YUCCA STANDARD 36" O.C. TRIANGULAR BLUE RANGER ZYGOPHYLLUM 'CIMARRON' SPACED



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OWNER: BEYOND/HELLO 4765 E. RAMON RD. PALM SPRINGS, CA 92264

CLIENT: EPSTEIN GLOBAL 600 WEST FULTON CHICAGO, IL 60661

PROJECT: BEYOND/HELLO ADDRESS: 4765 E. RAMON RD. PALM SPRINGS, CA 92264




PROJECT NUMBER: EPSN101 PHASE: DATE: 11.29.2021 SCALE:

SHEET TITLE:

MATERIALS AND PLANTING LEGEND

SHEET NUMBER: NOT FOR CONSTRUCTION L0.02

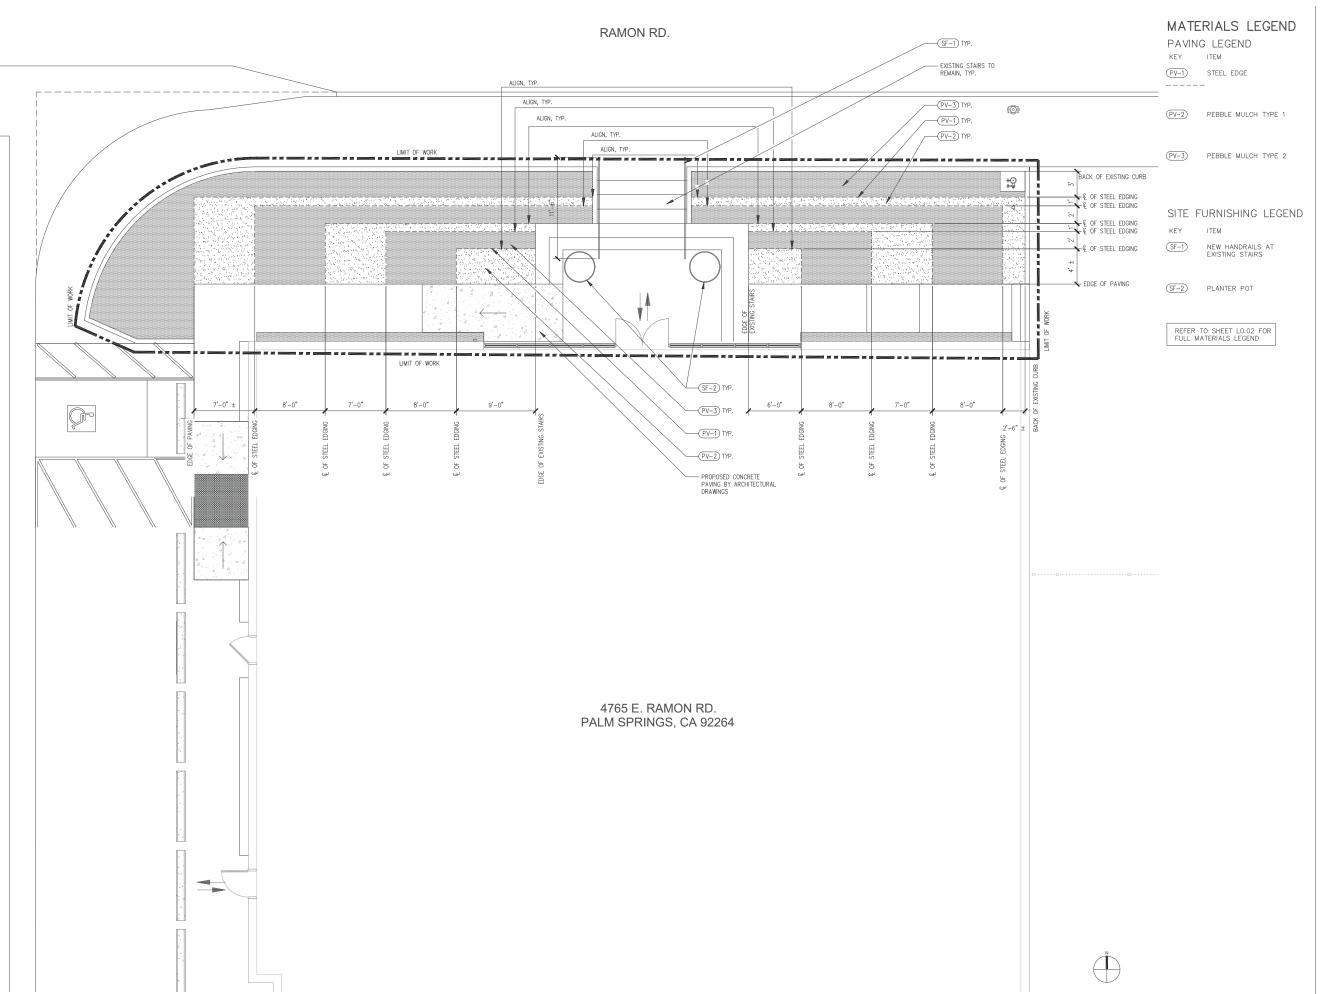



<u>edg</u>e

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BEYOND/HELLO 4765 E. RAMON RD. PALM SPRINGS, CA 92264

CLIENT: EPSTEIN GLOBAL 600 WEST FULTON CHICAGO, IL 60661

BEYOND/HELLO ADDRESS: 4765 E. RAMON RD. PALM SPRINGS, CA 92264

PROJECT NUMBER: EPSN101 PHASE:


DATE: 11.29.2021 SCALE: 1/4"=1'-0" 0' 1' 2' 4'

SHEET TITLE:

HARDSCAPE & LAYOUT PLAN

SHEET NUMBER: NOT FOR CONSTRUCTION L1.01

### RAMON RD.

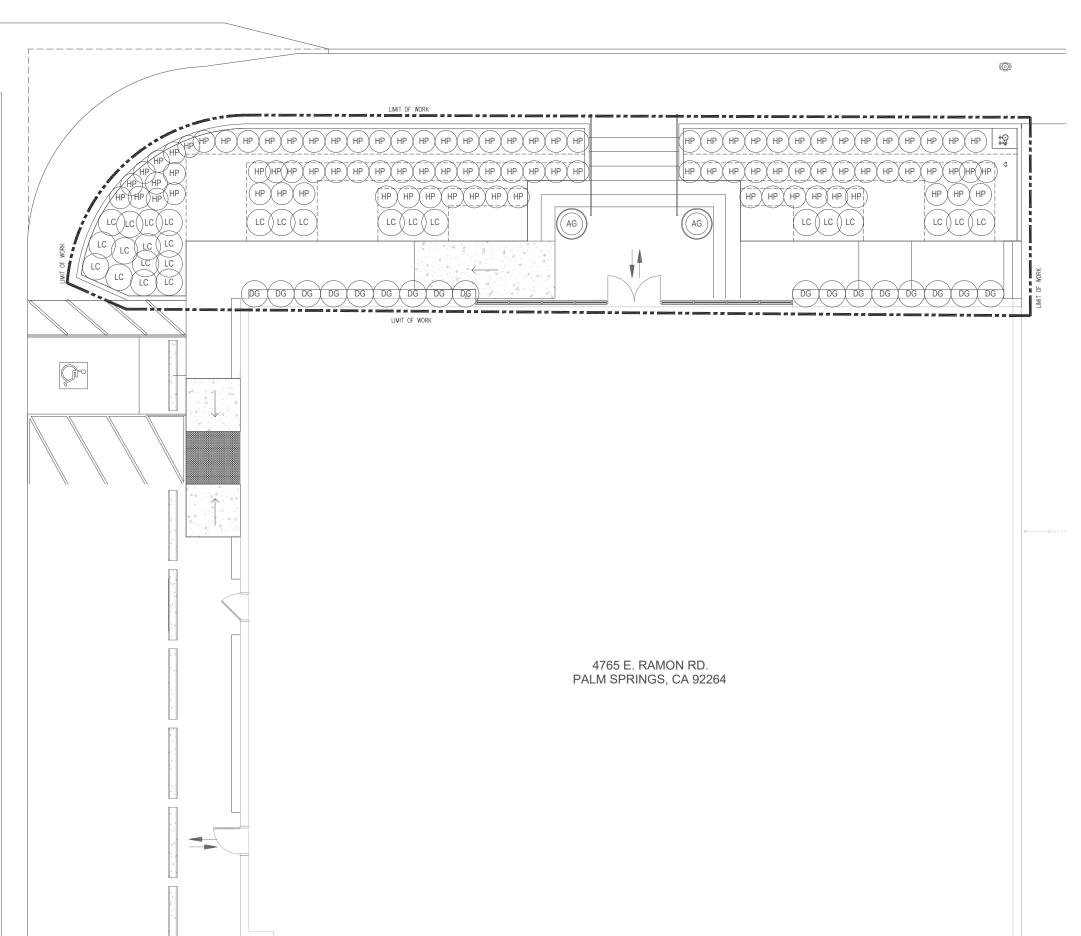

### PLANTING LEGEND

KEY SYMBOL BOTANICAL NAME

SHRUBS & GROUNDCOVER

AGA GEM (AG) AGAVE GEMINIFLORA

DIE GRA DG DIETES GRANDIFLORA

HES PAR (HP) HESPERALOE PARVIFLORA 'BRAKELIGHTS'

LEU ZYG (C) LEUCOPHYLLUM ZYGOPHYLLUM 'CIMARRON'

NOTE: REF SHEET LO.02 FOR FULL PLANTING LEGEND INCLUDING CONTAINER SIZE, SPACING AND NOTES.



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BEYOND/HELLO

ADDRESS: 4765 E. RAMON RD. PALM SPRINGS, CA 92264



PROJECT NUMBER: EPSN101 PHASE:


DATE: 11.29.2021 SCALE: 1/4"=1'-0" 0 1' 2' 4'

SHEET TITLE: PLANTING

PLAN

SHEET NUMBER:

NOT FOR CONSTRUCTION L1.02

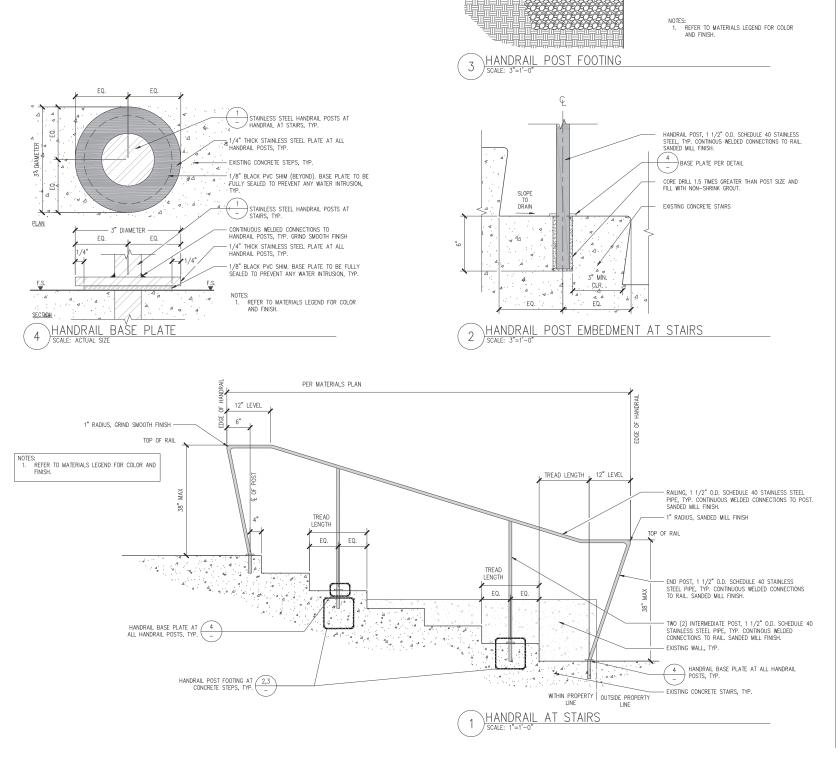

4 . . . 4 . 4 . 4 . 4 . 4 . 4 . .



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STAINLESS STEEL HANDRAIL POSTS. SEE
SECTION, HANDRAIL AT STAIRS, TYP.

4 STAINLESS STEEL HANDRAIL BASE PLATE,

CORE DRILL. SET POSTS WITH NON SHRINK GROUT

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OWNER: BEYOND/HELLO 4765 E. RAMON RD. PALM SPRINGS, CA 92264

CLIENT: EPSTEIN GLOBAL 600 WEST FULTON CHICAGO, IL 60661

### PROJECT: BEYOND/HELLO

ADDRESS: 4765 E. RAMON RD. PALM SPRINGS, CA 92264




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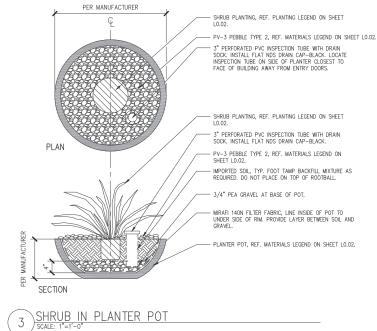
DATE: 11.29.2021 SCALE:

SHEET TITLE:


### LANDSCAPE **DETAILS**

SHEET NUMBER: NOT FOR CONSTRUCTION L1.03 © 2016 EDGE Design Group



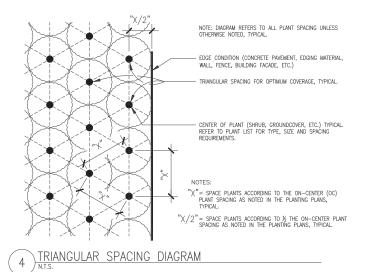




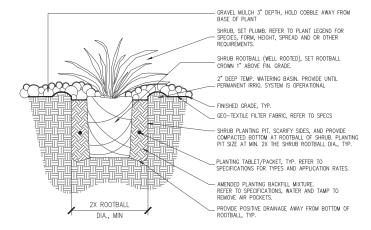

SHRUB PLANTING AT PEBBLES

N.T.S.

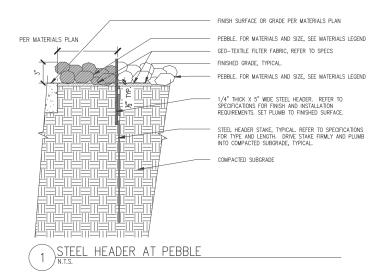



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OWNER: BEYOND/HELLO 4765 E. RAMON RD. PALM SPRINGS, CA 92264

CLIENT: EPSTEIN GLOBAL 600 WEST FULTON CHICAGO, IL 60661

# PROJECT: BEYOND/HELLO

ADDRESS: 4765 E. RAMON RD. PALM SPRINGS, CA 92264



NO. ISSUE DA - 95% CD 11.2

PROJECT NUMBER: EPSN101 PHASE:


DATE: 11.29.2021 SCALE:

SHEET TITLE:

### LANDSCAPE DETAILS

SHEET NUMBER:
[NOT FOR CONSTRUCTION]

L1.04

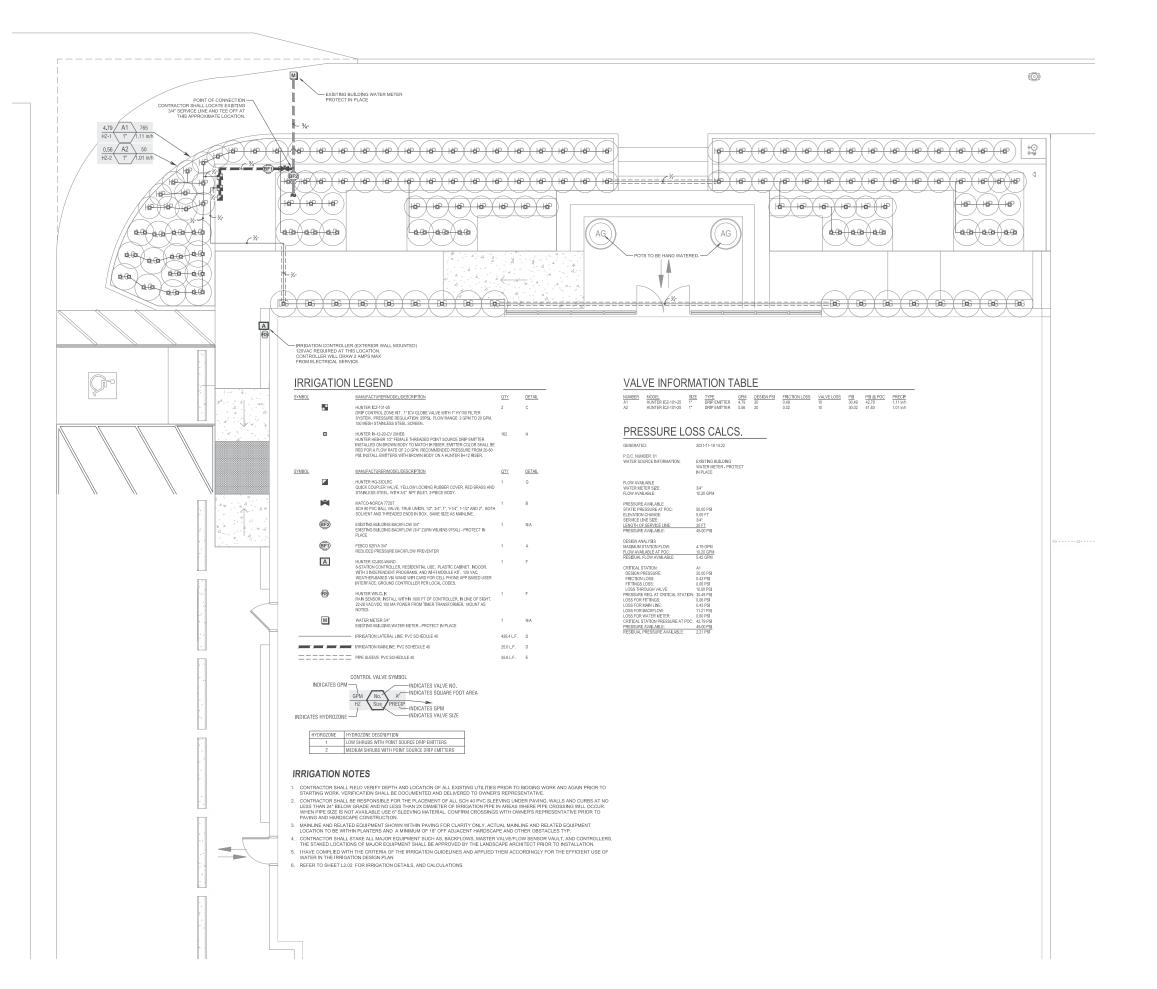



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OWNER: BEYOND/HELLO 4765 E. RAMON RD. PALM SPRINGS, CA 92264

CLIENT: EPSTEIN GLOBAL 600 WEST FULTON CHICAGO, IL 60661

PROJECT:
BEYOND/HELLO

ADDRESS: 4765 E. RAMON RD. PALM SPRINGS, CA 92264



NO. ISSUE - 95% CD

PROJECT NUMBER: EPSN101 PHASE:

-DATE: 11.29.2021

11.29.2021 SCALE: 1/4"=1"-0" 0 T Z


SHEET TITLE:

IRRIGATION PLAN



SHEET NUMBER:
[NOT FOR CONSTRUCTION]


L 2.01

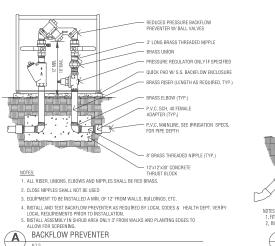


NAI VE BOX WITH COVER 30-INCH LINEAR LENGTH OF WIRE, COILED
 WATERPROOF CONNECTION: (5) 1-INCH BALL VALVE (6) ID TAG - BALL/GATE VALVE - BALL/GATE VALVE
- VALVE BOX - SEE IRRIGATION
- SPECS.
- VARIES - SEE IRRIGATION SPECS.
- FOR BOX TOP HEIGHT REMOTE CONTROL VALVE PRESSURE REGULATING QUICK CHECK BASKET FILTER (9) LASCO PVC UNION PEA GRAVEL, 2' DEPTH, LEAVE 1"-2" 11) PVC SCH 80 NIPPLE — PVC 45 FLI (7) PVC SCH 40 ELL PVC NIPPLE (13) PVC SCH 80 NIPPLE PVC MAINLINE - SEE IRRIGATION SPECS. FOR PIPE DEPTH PVC SCH 40 TEE OR ELL (15) MAINLINE PIPE (B) 3-INCH MINIMUM DEPTH OF 3/4-INCH WASHED GRAVEL (I) PVC SCH 80 NIPPLE, CLOSE 13 13 13 13 13 NOTES:


1. FITTINGS MAY DIFFER THAN THOSE SHOWN IN DETAIL.

2. INSTALL IN SHRUB AREAS ONLY AND A MINIMUM OF 12' FROM PLANTER EDGE BRICK VALVE BOX SUPPORTS (2 C DRIP CONTROL ZONE KIT B BALL VALVE

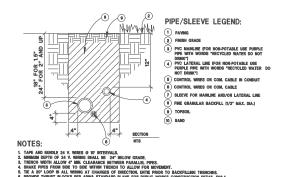

PIPE INSTALLATION

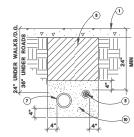

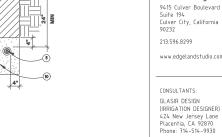

edge

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CLIENT: EPSTEIN GLOBAL 600 WEST FULTON CHICAGO, IL 60661


PROJECT:

BEYOND/HELLO 4765 E. RAMON RD. PALM SPRINGS, CA 92264


BEYOND/HELLO


ADDRESS: 4765 E. RAMON RD. PALM SPRINGS, CA 92264

E UNDER PAVING PIPE INSTALLATION

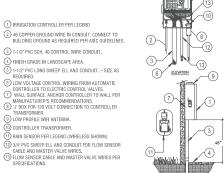

9—

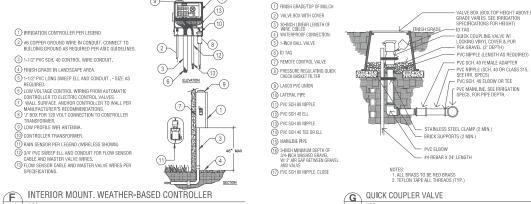

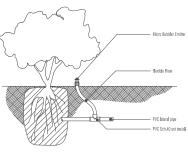

H DRIP EMITTER ON FLEX RISER

### GENERAL IRRIGATION NOTES

- ALL LOCAL MUNICIPAL AND STATE LAWS, RULES AND REGULATIONS GOVERNING OR RELATING TO ANY PORTION OF THIS WORK ARE HEREPY INCORPORATED INTO AND MADE A PART OF THESE SPECIFICATIONS AND THEIR PROVISIONS SHALL BE CARRIED OU BY
- THE CONTRACTOR SHALL OBTAIN ALL NECESSARY PERMITS REQUIRED TO PERFORM THE WORK INDICATED HEREIN BEFORE BEGINNING WORK.
- THIS DESIGN IS DIAGRAMMATIC. ALL EQUIPMENT SHOWN IN PAVED AREAS IS FOR DESIGN CLARITY ONLY AND IS TO BE INSTALLED WITHIN PLANTING AREAS.
- THE CONTRACTOR SHALL NOT WILLFULLY INSTALL ANY EQUIPMENT AS SHOWN ON THE PLANS WHEN IT IS OBVIOUS IN THE FIELD THAT UNKNOWN CONDITIONS EXIST THAT WERE NOT EVIDENT AT THE TIME THESE PLANS WERE PREPARED. ANY SUCH CONDITION SHALL BE BROUGHT TO THE ATTENTION OF THE OWNER'S REPRESENTATIVE PRIOR TO ANY WORK OR THE IRRIGATION CONTRACTO SHALL ASSUME ALL RESPONSIBILITY FOR ANY FIELD CHANGES DEFINED NECESSARY BY THE OWNER.
- INSTALL ALL EQUIPMENT AS SHOWN IN THE DETAILS AND SPECIFICATIONS. CONTRACTOR SHALL BE RESPONSIBLE TO COMPLY WITH LOCAL CITY, COUNTY AND STATE REQUIREMENTS FOR BOTH EQUIPMENT AND INSTALLATION.
- ALL PIPE UNDER PAYED AREAS TO BE INSTALLED IN SLEEVING TWICE THE DIAMETER OF THE PIPE CARRIED. SEE LEGEND FOR TYPE ALL WIRE UNDER PAYED AREAS TO BE INSTALLED IN A SCH. 40 SLEEVE THE SIZE REQUIRED TO EASILY PULL WIRE THROUGH. ALL SLEEVISET TO BE UNTALLED WITH A MINIMUM DEPTH AS SHOWN ON THE SLEEVING DETAILS. SLEEVES TO EXTEND AT LEAST 12' PAST THE EDGE OF THE PAYING.
- CONTRACTOR SHALL STAKE ALL MAJOR EQUIPMENT SUCH AS, BACKFLOWS, MASTER VALIVEFLOW SENSOR VAULT, AND CONTROLLERS. THE STAKED LOCATIONS OF MAJOR EQUIPMENT SHALL BE APPROVED BY THE LANDSCAPE ARCHITECT PRIOR TO MISTALLATION.

					ANDSCAPE WORKSH		
Project	4765 E. RAN	ION RD P	ALM SPRII	NGS, CA 92264			
	ce Evapotra			71.1		In Control	lasir Design igation Consulting parcoa-glassedesign con-
						a d	381004-glasindesign.com.
Hydrozone #	Plant Factor	irrigation	Irrigation	ETAF	T		Estimated Total
/Planting	(PF)	Method <sup>b</sup>	Efficiency	(PF/IE)	Landscape Area (sq, ft,)	ETAF x Area	Water Use
Description	(,		(IE)°		147		(ETWU) <sup>d</sup>
	dscape Area	is					
#1 low shrub	0.2	Drip	0.81	0.25	765	188.89	8,32
#2 med shrub	0.4	Drip	0.81	0.49	50	24.69	1,08
				Totals	815	213.58	9,41
Special Lan	dscape Area	s					
		_	_	1	0	0.00	
				1			
				Totals	0	0.00	11
						ETWU Total	9,41
	i e			Maxin	mum Allowed Water Allow	ance (MAWA)°	16,16
where 0.02 is a	conversion race	or that conver	ts acre-inche	s per acre per year to	gallons per square foot per ye	ar.	
				AF x LA) + ((1-ETAF)			
				s per acre per year to landscape area in squi	gallons per square foot per ye	ar, LA is the	
	for residential ar				are reet,		
ETAF Calcul	ations						
Regular Land:	scape Areas						
Total ETAF x	214	1	Average be 0.55	e ETAF for Regul	lar Landscape Areas midential areas, and 0.45	ust	
Area		-		for non-residentia		U	
Total Area	815						
Average ETAF	0.26						
All Landscape	e Areas Includ	fing SLA					
Total ETAF x	213.58	1					
Area	(0000000000						
Total Area	815	-					
Sitewide ETAF	0.26	1					





EPSN101 PHASE:

DATE: 11.29.2021 SCALE:


SHEET TITLE: **IRRIGATION** 

DETAILS


SHEET NUMBER: NOT FOR CONSTRUCTION L2.02




PROJECT NUMBER:

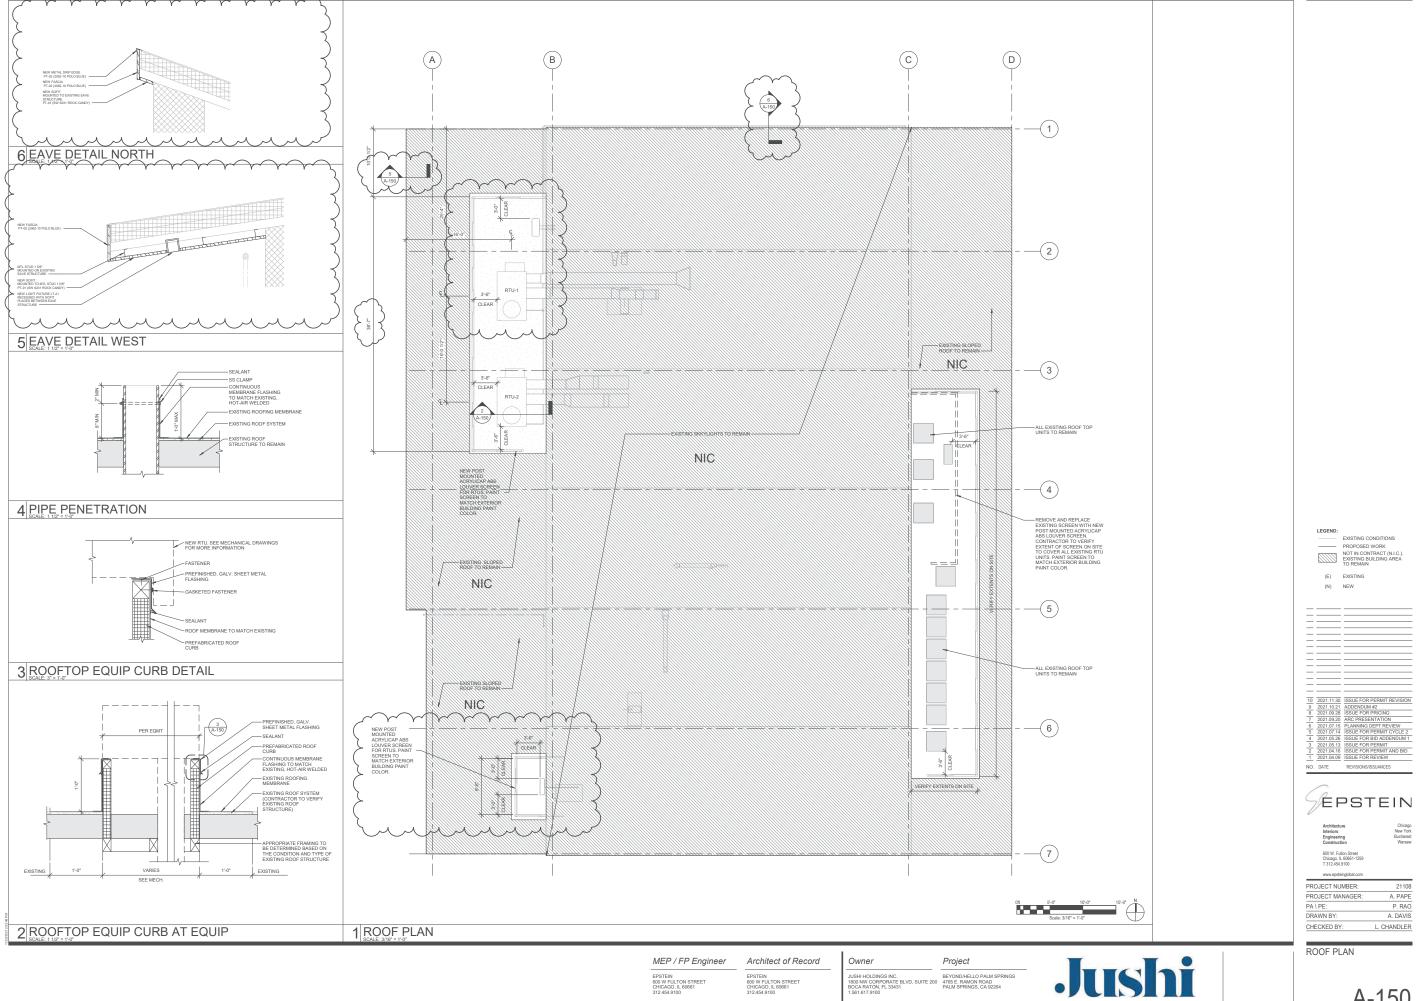


A-150

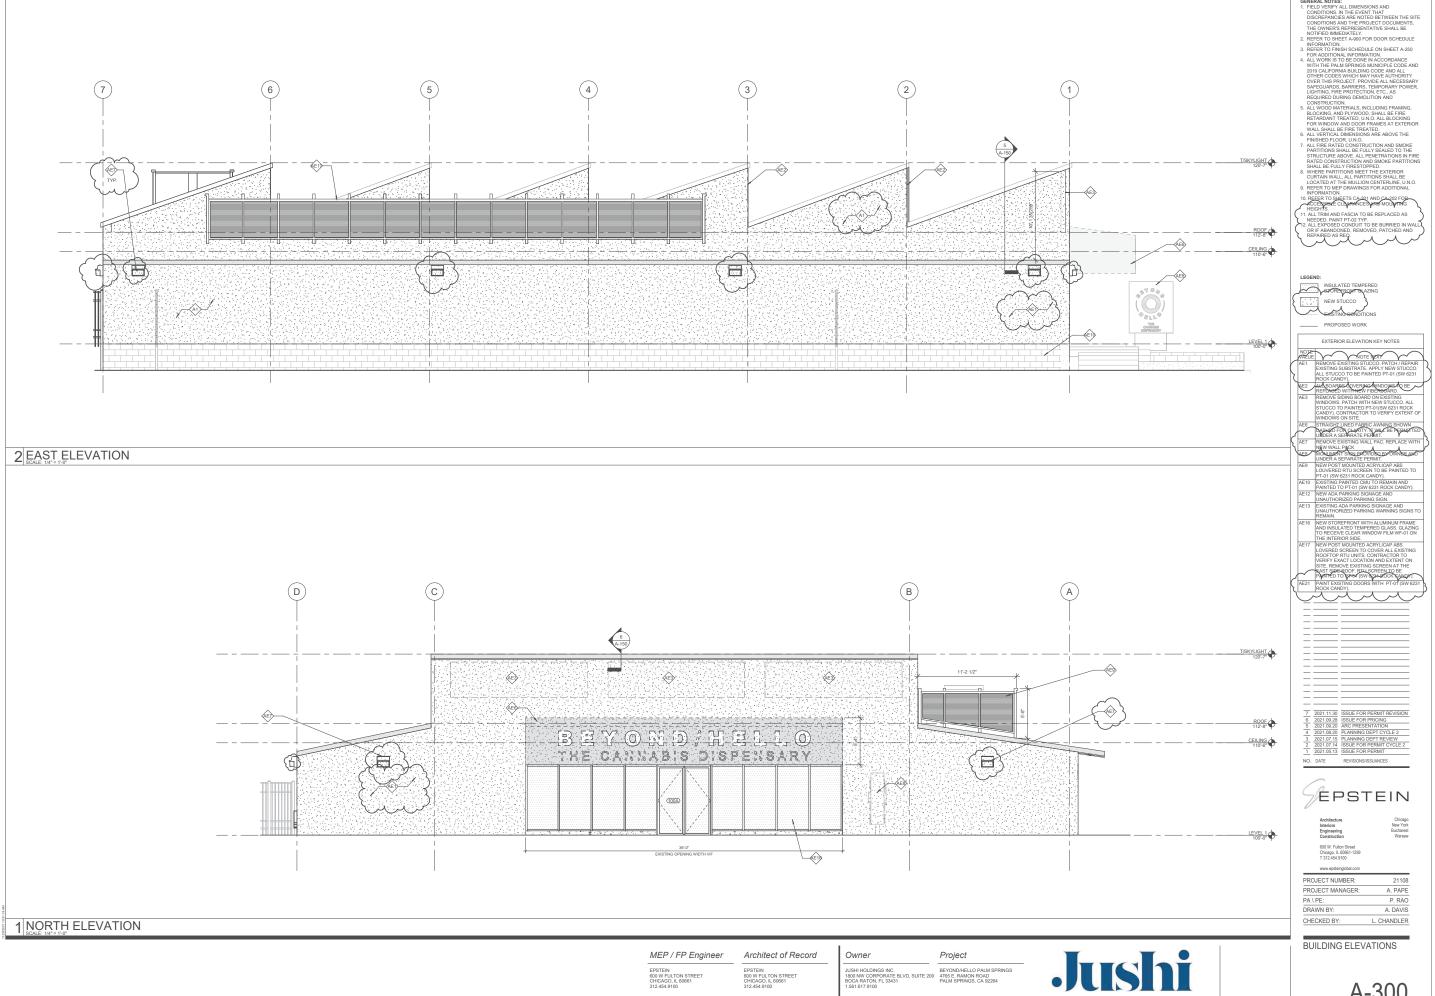


A-300

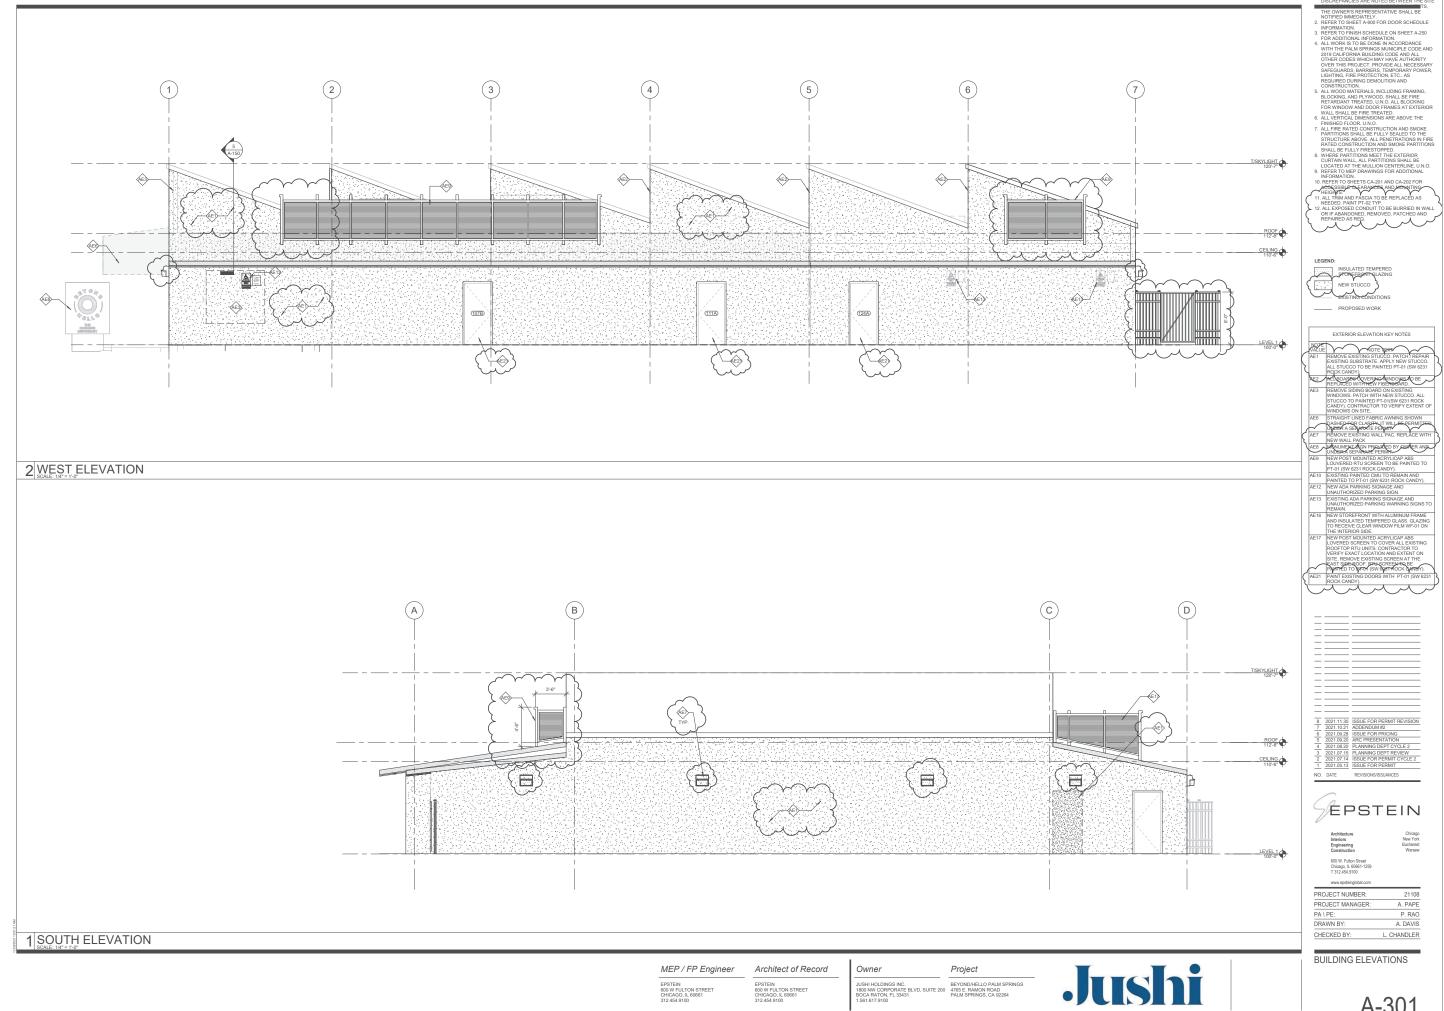

A-301

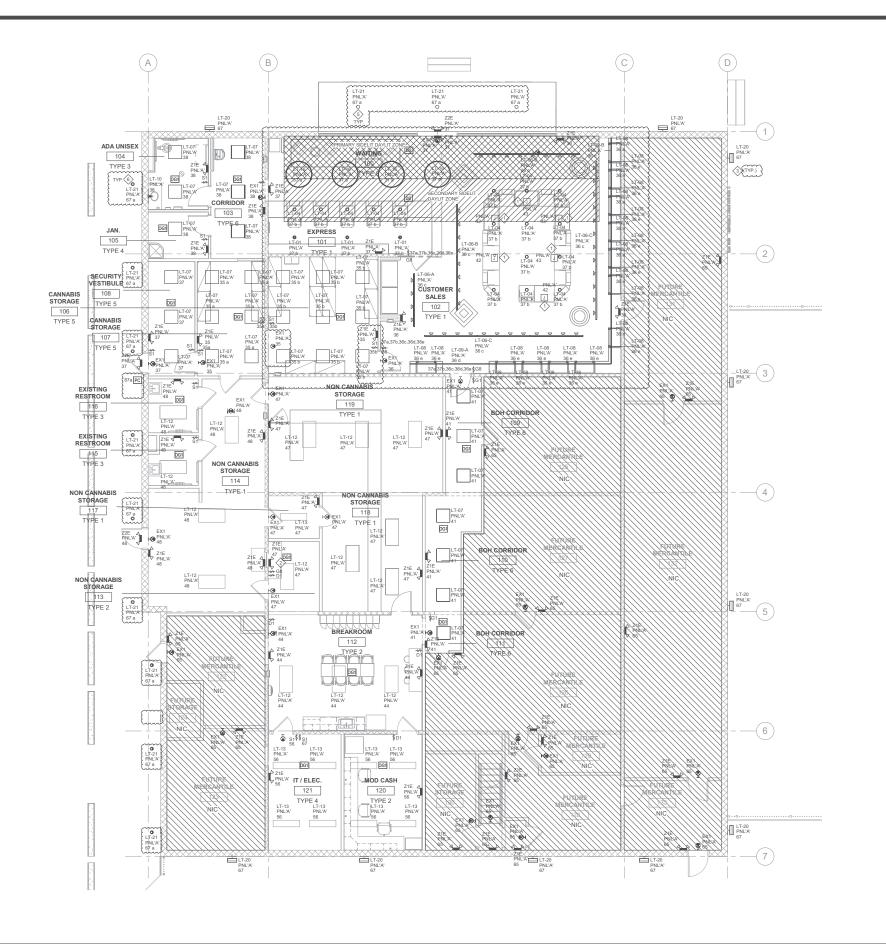

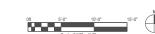

1 ELECTRICAL LIGHTING PLAN

Architect of Record

Owner



### LIGHTING GENERAL NOTES

EPSTEIN

CHECKED BY:

PROJECT NUMBER: PROJECT MANAGER: PA \ PE: B. ZARZYCKA-ROJEK
DRAWN BY: B. ZARZYCKA-ROJEK

LEVEL 1 LIGHTING RCP

	-										
	LIGHT FIXTURE SCHEDULE										
				LA	MPS	COLOR	FIXTURE		DIMMING		
TYPE	DESCRIPTION	MANUFACTURER	CATALOG NUMBER	QTY	TYPE	TEMPERATUR E	INPUT POWER	VOLTS	TYPE	MOUNTING	NOTES
EX1	WHITE THERMOPLASTIC EXIT, UNIVERSAL FACE, GREEN LED EMERGENCY EXIT	COMPASS	CE	1	LED	-	5 VA	120 V	<varies></varies>	AS REQ'D	NICAD BATTERY, CEC T20 COMPLIANT
LT-01	RECESSED LED DOWNLIGHT	SOLAIS	XR4NC-D-YM24-40C-35K-WH	1	LED	3500K	18 VA	120 V	0-10V	RECESSED	
LT-04	FLUSH MOUNT	IDEOLI OR EQ	CP9107-D-5-ST-35-90-DIM-WFL-WH/WH	1	LED	3500K	17 VA	120 V	0-10V	SURFACE	VERIFY EXACT LUMENS, REFLECTOR, FINISH , MOUNTING OPTIONS AND STEM LENGTH WITH ARCHITECT
LT-06-A	TRACK LIGHT	LUMENTURE OR EQUAL	T50 TRACK SERIES (L=8'-0")	1	LED	3000K	120 VA	120 V	-	TRACK	FIXTURE WATTAGE IS BASED ON A CURRENT LIMITING DEVICE FOR 120W. VERIFY IF DEVICE IS COMPATIBLE WITH TRACK PRIOR ORDERING.
LT-06-B	TRACK LIGHT	LUMENTURE OR EQUAL	T50 TRACK SERIES (L=16'-0")	1	LED	3000K	120 VA	120 V	-	TRACK	FIXTURE WATTAGE IS BASED ON A CURRENT LIMITING DEVICE FOR 120W. VERIFY IF DEVICE IS COMPATIBLE WITH TRACK PRIOR ORDERING.
LT-06-C	TRACK LIGHT	LUMENTURE OR EQUAL	T50 TRACK SERIES (L=24'-0")	1	LED	3000K	240 VA	120 V	-	TRACK	FIXTURE WATTAGE IS BASED ON A CURRENT LIMITING DEVICE FOR 240W. VERIFY IF DEVICE IS COMPATIBLE WITH TRACK PRIOR ORDERING.
LT-07	GRID CEILING LIGHT	COLUMBIA LIGHTING OR EQ VIA ILLUMINICO	LCAT22-35LWG-R-EDU-C588	1	LED	3500K	23 VA	120 V	0-10V	RECESSED	
LT-08	TAPE LIGHT	NOVAFLEX	NF-CH-1707-2M-PRO-O-60-24V-300K	1	LED	3000K	5 VA	120 V	-	SURFACE	
LT-09-A	RECESSED CHANNEL LIGHT	LEDI	QUANTUM 2 RECESSED 1005 CH-R 1005-KIT-35-010V-0 (L = 30' 6")	1	LED	3500K	92 VA	120 V	-	SURFACE	
LT-09-B	RECESSED CHANNEL LIGHT	LEDI	QUANTUM 2 RECESSED 1005 CH-R 1005-KIT-35-010V-0 (L = 34' 3")	1	LED	3500K	103 VA	120 V	-	SURFACE	
LT-10	WALL SCONCE	MITZI	AVA SCONCE, H109101B-OB	1	LED	-	25 VA	120 V		WALL MOUNTED	E26-G40 LED EDISON BULB 25W
LT-12	EXISTING LIGHTING FIXTURE	EXISTING TO REMAIN	EXISTING TO REMAIN	1	LED	3500K	23 VA	120 V	-	RECESSED	
LT-13	EXISTING LIGHTING FIXTURE	EXISTING TO REMAIN	EXISTING TO REMAIN	1	LED	3500K	23 VA	120 V	-	RECESSED	
LT-16	RING LIGHT	ALW ALW	MR1.5/ST-D4-CAS-MED-90-3500K-0/10V/0%-LENS-LOW-TW	00000000	LED	3500K	97 VA	120 V	0-10V	SUSPENDED	
LT-20	EXTERIOR WALL SCONCE	LITHONIA	WDGE1 LED-P2-30K-80CRI-VF-MVOLT-PE	1	LED	3000K	15 VA	120 V		WALL MOUNTED	<u> </u>
LT-21	EXTERIOR RECESSED LED DOWNLIGHT	ALPHABET	NU6-QA-XTM-13L-30K-90CRI-S60-120-D10	1	LED	3000K	14 VA	120 V	0-10V	RECESSED	
Z1E	EMERGENCY BATTERY PACK	COMPASS	CU2	2	LED	-	2 VA	120 V	-	MOUNTED	PROVIDE INTEGRAL POWER PACK WITH 90 MINUTE BATTERY BACKUP
ZZE	BATTERY PACK	COMPASS	CU2SO	uuzuu	TEDUN	Lunimi	YVA	120 V	minn	MOUNTED	PROVIDE INTEGRAL POWER PACK WITH 90 MINUTE BATTERY BACKUP

LIGHTING FIXTURE SCHEDULE GENERAL NOTES:

- A. FOR EXACT LOCATIONS OF ALL LIGHTING FIXTURES REFER TO ARCHITECTURAL REFLECTED CEILING PLANS AND ELEVATIONS.
  B. MANUFACTURERS' CATALOG NUMBERS ARE INTENTIONALLY INCOMPLETE. VERIFY AND COORDINATE REQUIRED TRIM KITS, MOUNTING BRACKETS, LAMPS, FINISHES, ETC. WITH CONTRACT DOCUMENTS, SPECIFICATIONS.
  C. LAMPS FOR ALL FIXTURES SHALL HAVE THE SAME COLOR TEMPERATURE PERS PECFICATIONS.
  D. THE MANAMUM RATED WATTAGE OF EACH LUMINARIES SHALL BE LISTED ON A PERMANENT, PREPRINTED, FACTORY-INSTALLED INSTALLED LABEL, AS SPECIFIED BY UL 1574, 1598, 2108, OR 8750 AS APPLICABLE.

LIGHTING DEVICE SCHEDULE								
TAG	DESCRIPTION	MANUFACTURER	CATALOG NUMBER	NOTES				
D1	STAND ALONE - WALL DIMMER	LEVITON	IP710					
DS	GREENMAX-DIGITAL SENSOR	LEVITON	OSR05-ICW					
G1	GREENMAX -1-BUTTON	LEVITON	RDGSW-1CW	OVERRIDE SWITCHES FOR RELAY PANEL WITH DIGITAL TIME CLOCK				
G8	GREENMAX -8-BUTTON	LEVITON	RDGSW-1CW	ON/RAISE/LOWER/OFF - 2 ZONES				
OG1	GREENMAX-OCCUPANCY SENSOR DUAL TECH	LEVITON		PARTIAL OFF TO 50% WHEN UNOCCUPIED				
	PHOTOSENSOR			PHOTOSENSOR SHALL BE MOUNTED ON THE ROOF FACING NORTH, FREE OF ANY OBSTRUCTIONS				
S1	STAND ALONE - DECORA LOW VOLTAGE SWITCH	LEVITON	56081					

### LIGHTING CONTROL GENERAL NOTES:

- LIGHTING CONTROL GENERAL NOTES:

  A LIGHTING CONTROL SYSTEM'S SHOWN SHOWS BASIC REQUIREMENTS ONLY CONTRACTOR SHALL REVIEW WITH LIGHTING CONTROL SYSTEM'S MANUFACTURER ALL COMPONENTS AND ACCESSORIES REQUIRED TO PROVIDE A COMPLETE AND FULLY OPERATIONAL SYSTEM, ALONG WITH HYSTEM STRATLUP NOT PROVIDED AND THE MANUFACTURER. PROGRAMMING START-UP TO BE DONE IN PRESENCE OF OWNER AND ACREMENT CONTRACTOR MISS. CONFIRM TIME, LOCATIONS AND ACREMENT CONFIRM TIME, LOCATIONS AND DIADNITIES OF SENSORS SHOWN ON DRAWINGS ARE APPROXIMATE. THE CONTRACTOR SHALL PROVIDE ADDITIONAL SENSORS IF REQUIRED TO PROPERLY AND COMPLETELY COVER THE RESPECTIVE ROOM. VERTIFY PROPER PLACEMENT OF ALL SENSORS TO ENSIRE THE REQUIRED TO PRICE OVER THE RESPECTIVE ROOM. VERTIFY PROPER PLACEMENT OF ALL SENSORS TO ENSIRE THE REQUIRED TOWN COVERAGE AND DAY TO SENTUCIONS AND REFER TO MANUFACTURERS INSTALLATION INSTRUCTIONS, ALL SENSORY DEVICES SHALL BE INSTALLED AND AMED SUCH THAT THEY DO NOT PICK UP FALSE SIGNAL FROM SURROUNDING AREA SUBMITTALS SHALL INCLUDE MANUFACTURER PROVIDED SENSORS COVERAGE FOR REVIEW.

  SENSORS COVERAGE FOR REVIEW.

  CONTROL PANELS AND ASSOCIATED SWITCH CONTROL COMPONENTS ARE TO BE SUPPLIED FROM A SINGLE MANUFACTURER AND PLATFORM. REFER TO SPECIFICATIONS.

  E. ALL SWITCHES SHALL BE LOW VOLTAGE. UNLESS OTHERWISE NOTED.

  F. WHERE LIGHTING CONTROLS SWITCHING ZONES ARE NOT SPECIFIED. ZONES SHALL BE CREATED BASED ON CIRCUITS INDICATED ON DRAWINGS.

  E. ALL SWITCHES SHALL BE LOW VOLTAGE. UNLESS OTHERWISE NOTED.

  F. WHERE LIGHTING CONTROLS SWITCHING ZONES ARE NOT SPECIFIED. ZONES SHALL BE CREATED BASED ON CIRCUITS INDICATED ON DRAWINGS.

  F. PER TITLE SY.

  F

- ONLY LIGHTING CONTROL PRODUCTS AS REQUIRED BY THE APPLICABLE CALIFORNIA APPLIANCE EFFICIENCY STANDARDS (ALSO KNOWN AS TITLE 20 STANDARDS), THAT HAVE BEEN CERTIFIED AND LISTED IN ENERGY COMMISSION DIRECTORIES, CAN BE UTILIZED IN THIS PROJECT. THE APPROVED PRODUCTS WILL BE LISTED IN THE CEC'S DIRECTORIES OR IN AN APPLIANCE EFFICIENCY DATABASE.
- FUNCTIONAL TESTING OF LIGHTING CONTROLS:
  AS PER REQUIREMENTS CA ENERGY CODE 2019.

	LIGHTING CONTROLS MATRIX						
TYPE	LIGHTING CONTROLS INTENT NARRATIVE	SENSOR	DIMMING	MANUAL CONTROL DEVICE	SCENE CONTROL	PHOTOCELL	NOTES
TYPE 1	RELAY PANEL WITH DIGITAL TIME CLOCK AND ON/OFF OVERRIDE SWITCHES		х	Х			COORDINATE EXACT LOCATION OF OVERRIDE SWITCHES WITH OWNER
TYPE 2	CEILING MOUNTED OCCUPANCY SENSOR W/ MANUAL ON - AUTO-OFF OPERATION AND DIMMABLE OVERRIDE SWITCH	Х	Х	Х			
TYPE 3	CEILING MOUNTED OCC. SENSOR WITH AUTO ON - AUTO OFF OPERATION AND KEY SWITCH	Х		Х			15 MINUTES SENSOR TIME-OUT PERIOD
TYPE 4	VACANCY SENSOR WITH AUTO OFF OPERATION AND ON/OFF SWITCH	Х		Х			15 MINUTES SENSOR TIME-OUT PERIOD
TYPE 5	CEILING MOUNTED OCC. SENSOR WITH AUTO ON - AUTO OFF OPERATION AND ON/OFF SWITCH	Х		Х			15 MINUTES SENSOR TIME-OUT PERIOD
TYPE 6	CEILING MOUNTED OCC. SENSOR WITH DIMMABLE AND ON/OFF SWITCH	Х	х	Х			PARTIAL OFF TO 50% WHEN UNOCCUPIED
TYPE 7	TIME CLOCK (THROUGH RELAY PANEL) AND PHOTOCELL					Х	CANOPY LIGHTING CONTROLLED BY ROOF MOUNTED PHOTOCELL, EXTERIOR WALL PACKS CONTROLLED BY INTERNAL PHOTOCELL
TYPE 8	RELAY PANEL WITH DIGITAL TIME CLOCK, DAYLIGHT SENSOR AND ON/OFF OVERRIDE SWITCHES		Х	Х		х	DAYLIGHT ZONE TO BE DIMMED VIA PHOTOCELL THEN SUFFICIENT DAYLIGHT IS AVAILABLE

	EQUIPMENT SCHEDULE - MECHANICAL																
					LOAD				FED			CONNECTION			DISCONNE	CT	
TAG	DESCRIPTION	VOLTS	PHASE	FLA (A)	MCA (A)	MOCP (A)	HP	kW	FROM	CCT	CONDUIT & CABLE	TYPE	SIZE (A)	FUSE (A)	NEMA ENCLOSURE	PROVIDED BY	REMARKS
DCH-1	CONDENSING UNIT	249	mhm	mobben	m128m	moler	2	mortina	-PNL'B'-	1712	2#12.8.1#12G-3/4"C	HARDWIRED.	300	man	NEMA3B.	anna Mrannar	DCU-1 & DECU-1 SINGLE POINT CONNECTION
DCU-2	CONDENSING UNIT	240	1	0.0	13.0	20		0.0	PNL'B'	18,20	2#12 & 1#12G, 3/4"C	HARDWIRED	30	0	NEMA 3R	M.C.	DCU-2 & DFCU-2 SINGLE POINT CONNECTION
DECUI	AIR CONDITIONER					2			PNO		2#12 & 1#12G.3/4 C	HAROWIKED	300		TO THE I		DOUGLE DECLETSINGLE POINT CONNECTION
DFCU-2	AIR CONDITIONER	240	1	0.0	1.0	15		0.0	PNL'B'	23,25	2#12 & 1#12G, 3/4"C	HARDWIRED	30	0	TYPE 1	M.C.	DCU-2 & DFCU-2 SINGLE POINT CONNECTION
DFCU-3	AIR CONDITIONER	240	1	0.0	1.0	15	0.0	0.0	PNL'B'	24,26	2#12 & 1#12G, 3/4"C	HARDWIRED	30	0	TYPE 1	M.C.	
pathia	EXHAUSTFAN		<del>juryuu</del>	ang.gra	ang.gar	475		70.2	PNCA	arepro	2#12 & 1#12G, 3/4 C	HARDWIRED	~~30~	mym	MANE IN	Decertification of the contract of the contrac	~~~~~~~~~~~~~~~~~~~~~~~~~~~~~~~~~~~~~~~
EF-2	EXHAUST FAN	120	1	0.0	0.0	15		0.2	PNL'A'	62	2#12 & 1#12G, 3/4"C	HARDWIRED	30	0	TYPE 1	M.C.	
EF-3	EXHAUST FAN	120	1	0.0	0.0	15	0.0	0.2	PNL'A'	68	2#12 & 1#12G, 3/4"C	HARDWIRED	30	0	TYPE 1	M.C.	
RP1	RECIRCULATION PUMP	120	1	0.0	0.0	20	0.1	0.0	PNL'A'	8	2#12 & 1#12G, 3/4"C	HARDWIRED	30	0	TYPE 1	M.C.	
RTU-1	ROOFTOP UNIT	240	3	0.0	19.1	40		6.4	PNL'A'	49,51,53	3#8 & 1#8 & 1#10, 3/4°C	HARDWIRED	40	0	NEMA 3R	M.C.	
RTU-2	ROOFTOP UNIT	240	3	0.0	12.3	20	0.0	4.0	PNL'A'	50,52,54	3#8 & 1#8 & 1#10, 3/4°C	HARDWIRED	30	0	NEMA 3R	M.C.	
WH1	ELECTRIC WATER HEATER	120	1	0.0	37.5	40		4.5	PNL'A'	7	2#8 & 1#10, 3/4"C	HARDWIRED	40			P.C.	

MECHANICAL EQUIPMENT SCHEDULE GENERAL NOTES:

- A. SEE SPECIFICATIONS FOR ADDITIONAL INFORMATION.

  B. WHERE STARTERS ARE INDICATED, SELECT THERMAL OVERLOAD PER MANUFACTURER RECOMMENDATIONS.

  C. STARTERS SHALL HAVE A HONO SWITCH, INDICATION LIGHTS, 120V CONTROL TRANSFORMER, AND 2 SETS OF NONC CONTACTS.

  D. WHERE SHEES A SHEWARDER OF THE STANDARD CONTROL TRANSFORMER, AND 2 SETS OF NONC CONTACTS.

  ALL EQUIPMENT FURNISHED BY MECHANICAL CONTRACTOR (DISCONMENTS, STARTERS, VFD'S, ETC.) SHALL BE INSTALLED AND WIRED BY ELECTRICAL CONTRACTOR. COORDINATE WITH MECHANICAL CONTRACTOR.

7 2021.11.30 ISSUE FOR PERMIT CYCLE 3
6 2021.10.21 ADDENDUM #2
5 2021.03.21 ISSUE FOR PRICING
4 2021.07.14 ISSUE FOR PERMIT CYCLE 2
3 2021.05.13 ISSUE FOR PERMIT CYCLE 2
2021.04.16 ISSUE FOR PERMIT NO BID
1 2021.04.00 ISSUE FOR REVIEW



Architecture Interiors Engineering Construction

600 W. Fulton Street Chicago, IL 60661-1259 T 312.454.9100

PROJECT NUMBE	ER:			2110	08
PROJECT MANAG	GER:		A.	PAF	E
PA \ PE:	B. ZA	NRZY	CKA-F	ROJE	K
DRAWN BY:	B. ZA	ARZY	CKA-F	ROJE	K
CHECKED BY:		-	J. KUE	THE	R


ELECTRICAL SCHEDULES

MEP / FP Engineer

Architect of Record

Owner

Project JUSHI HOLDINGS INC.
1800 NW CORPORATE BLVD, SUITE 200
4785 E. RAMON ROAD
BOOA RATON, PL \$3431
12-51817-2000
1-501817-2000

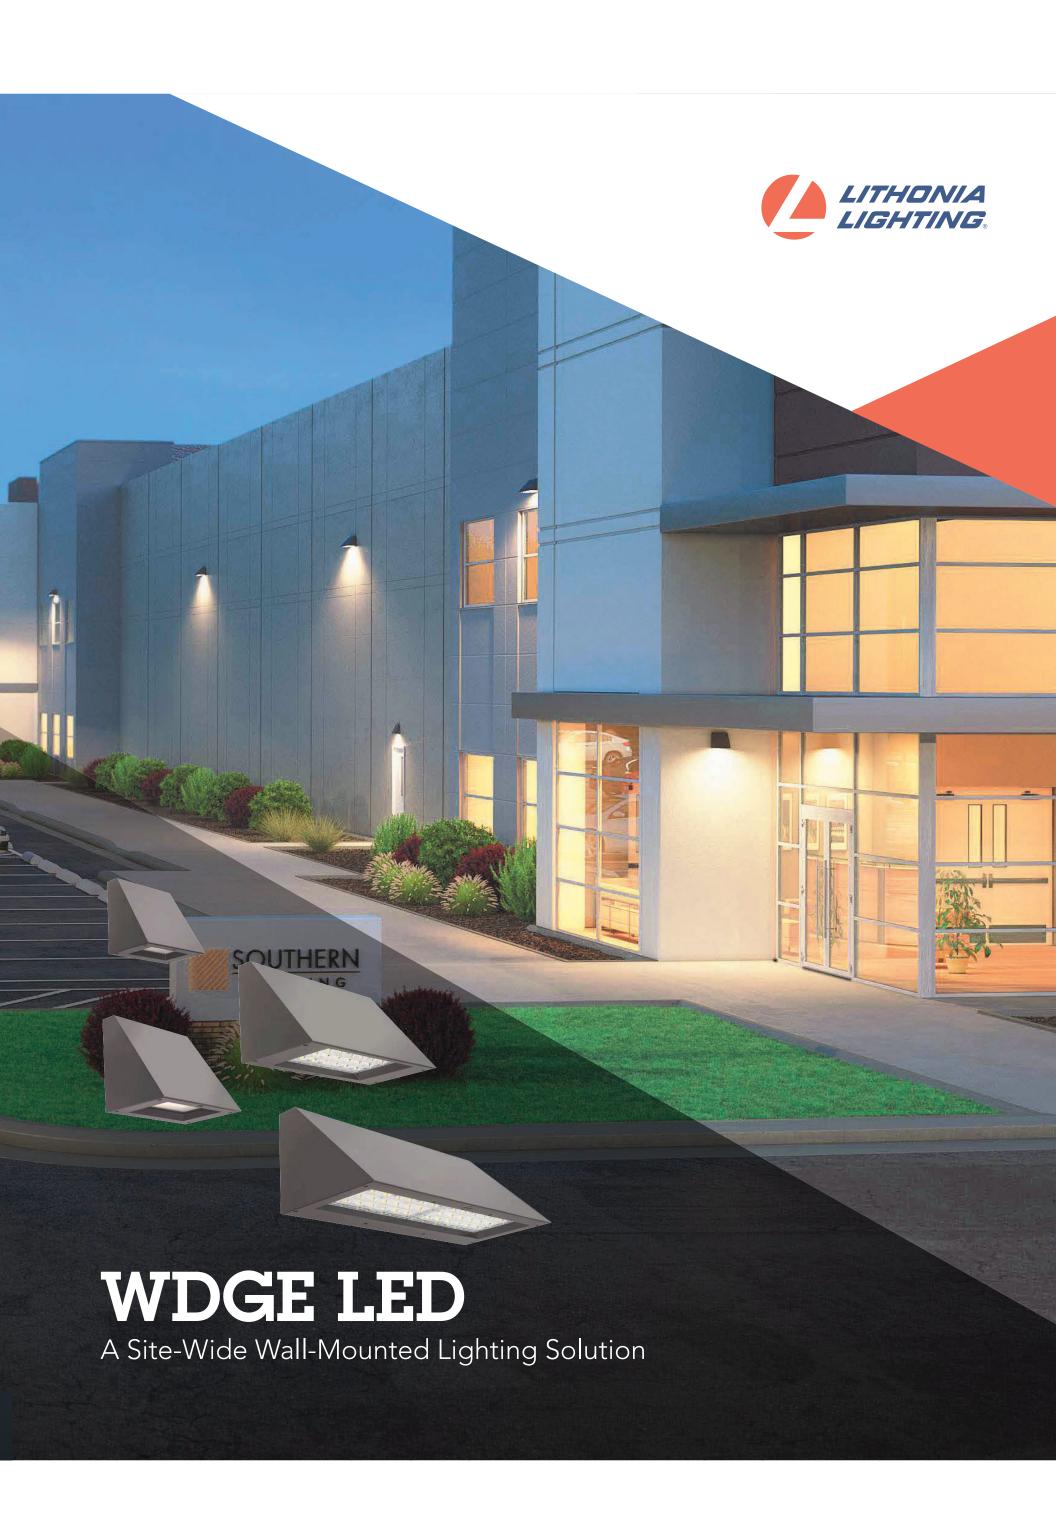



# A Site-Wide Wall-Mounted Lighting Solution

The WDGE LED family was designed to provide optimal wall-mounted lighting solutions for all mounting heights. Using two technologies, these luminaires provide visually comfortable lighting at building entryways and area distributions at higher mounting heights. With clean lines, the WDGE blends seamlessly into any architecture, meeting the everyday lighting needs of engineers and architects alike.

"I want one shape in multiple sizes - for all mounting heights... continuity throughout the site."

"Entryway lighting must be soft and inviting, not glary."

"Luminaires for higher mounting heights need to provide wide spacing and even distribution."


"Emergency egress options to meet code must be fully integrated without bulky back-boxes."

"My architects want simple, geometric shapes with clean lines... nothing that will compete with the architecture of the building."

# Engineered with You in Mind

Application	Architect's Needs	Engineer's Needs
Entryway / Pathway Lighting (7'-15' mounting heights)	<ul> <li>Create a warm, inviting environment</li> <li>Blend with building architecture</li> <li>Quality light with high CRI and choice of CCT</li> </ul>	<ul> <li>Low-glare solution</li> <li>Architect approval of dayform</li> <li>Emergency egress options</li> <li>Controls options</li> <li>Fully configurable with short lead-times</li> </ul>
Area / Perimeter Lighting (15'-25' mounting heights)	<ul> <li>A true wall-mount solution - no area luminaires with "diving board" look</li> <li>Site-wide continuity of luminaire shape</li> </ul>	<ul> <li>Wide spacing with uniform lighting</li> <li>Minimize pole-mounted luminaires</li> <li>Budget-friendly</li> </ul>



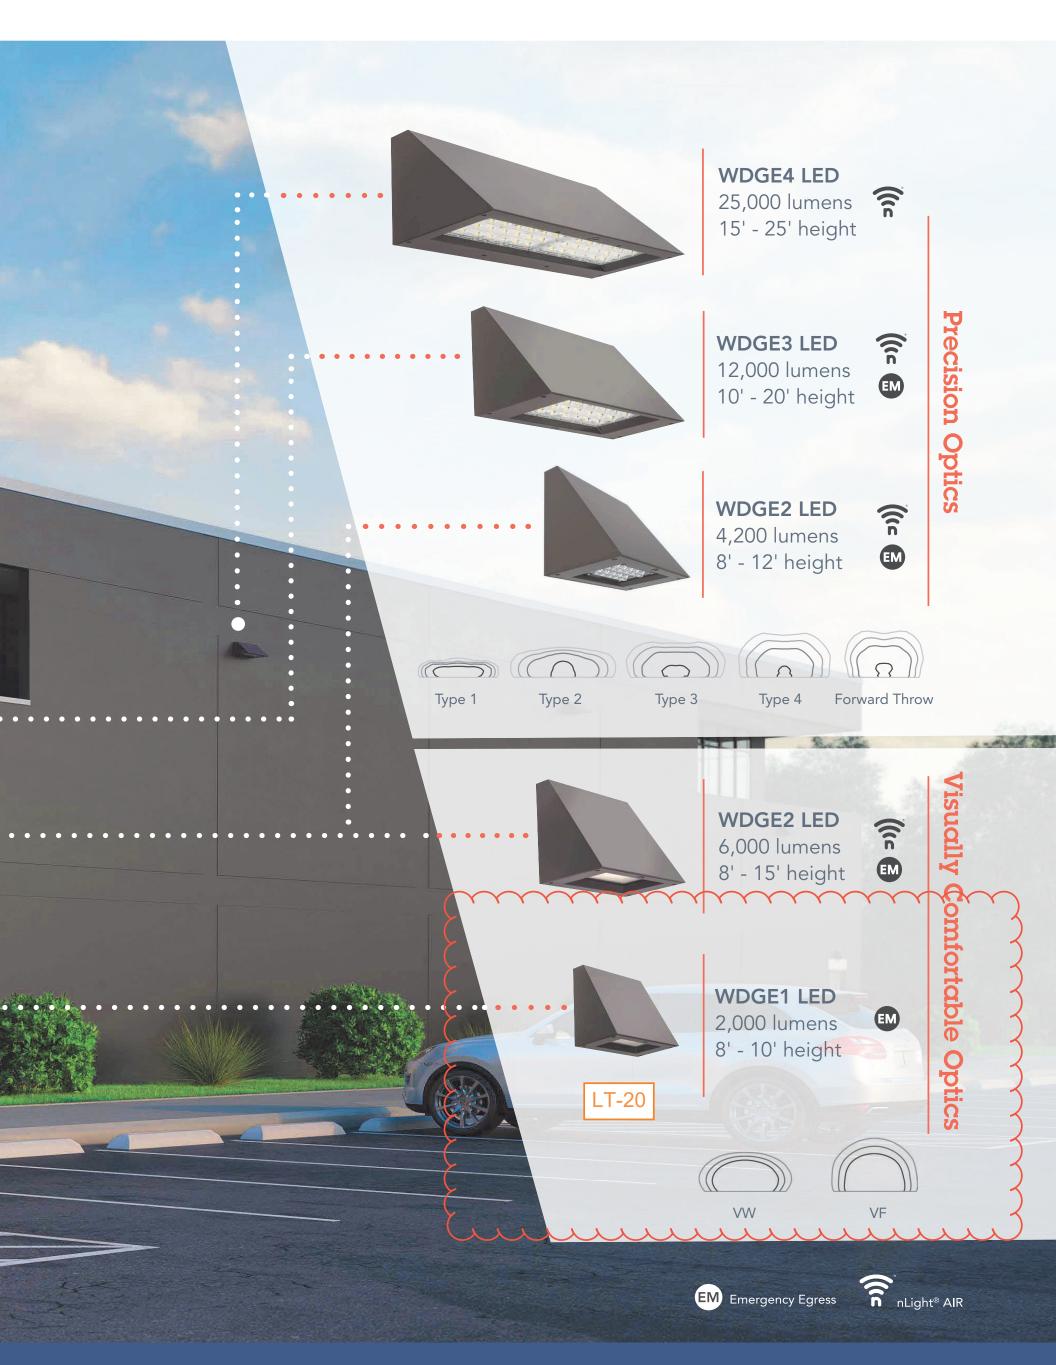

# **Architectural Wall Spacer**





Choose between flushmount (standard) or the optional architectural wall spacer for a floating appearance.



# nLight® AIR Embedded Outdoor Luminaires





JOB NAME

CONTACT

**ORDERING CODE** 




# **Square Adjustable JA8 Xicato**









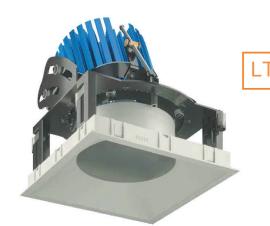

### **DESCRIPTION**

The NU6QA 6" recessed adjustable by ALPHABET offers premium performance, thoughtful construction and pleasing aesthetics. Offered standard with premium dimming using EldoLED 1% flicker free drivers in 120V, 277V. An adjustable hot-aiming system allows tilt adjustments from 0° to 40° with 360° rotation. The aiming adjustment and locking mechanisms are accessible from below the ceiling while the reflector is installed. A complex tilting mechanism positions the tilting axis for the maximum optical performance at all angles. A minimalistic look is achieved with an ultrathin 1/16" trim that is only 5/16" wide. Color choices of both trim and bezel are offered for a customized look. 5-year FIXTURE WARRANTY.

### HOUSING

Electrocoated 16-gauge cold-rolled steel provides enhanced structural reinforcement and rust prevention. Superior, UL-certified, injection-molded commercial-grade Lexan™ (PC) is used for the frame and regressed bezel trim. Lexan provides unmatched durability and impact resistance, and is tested for UV resistance and water exposure in outdoor applications. The thermallyadvanced, anodized heat sink uses 6063 aluminum alloy.

### **MOUNTING**

An advanced mounting system allows for quick and secure installation with LED and driver serviceability from below the ceiling. The LED assembly uses die-cast aluminum mounting clamp grips (MCG) that swing out to tighten onto variable ceiling thicknesses. Integrated rubber feet on each MCG provide a non-slip vibration-resistant installation. The hidden MCG system is accessible from below ceiling by removing the snap-in lens/bezel assembly with either the included suction cup or a screwdriver blade. Integrated bar hangers feature integral toothed nails, T-bar mounting slots with locking holes, tabs for joist positioning. Retrofit mounting option allows for installation from below ceiling by use of compact driver box. No risk damaging LED or bezel assembly during installation, these are installed during last steps. Fixture and driver are easily removed for servicing after install without damaging drywall.

MOUNTING	CEILING	CEILING
DIMENSIONS	THICKNESS	CUTOUT
Trim	1/8" to 1-1/4"	6-1/4" square

### **LISTINGS**

- JA8 2019 (complies with 2019 Title 24, part 6 high efficacy luminaire requirements)
- ETLus Listed to UL1598, cETL Listed to CSA C22.2 #250.0
- Suitable for damp locations without lens
- Non-conductive, Lexan dead-front construction
- Made in the USA meets the requirements of the Buy American provision within the ARRA

### **LED INFO**

- SDCM = 1X2 MacAdam Ellipse, Duv +/- 0.001, Lumen Maintenance:  $L_{90} > 55,000$  hrs

### **JA8 ORDERING CODES**



Ч			made in the USA
	SERIES	NU6	
	TYPE	QA	square adjustable
	LED	XTM	Xicato XTM 19mm
	DELIVERED LUMENS	10L 13L	860 lm 1120 lm
	сст	27K 30K 35K 40K	2700K 3000K 3500K 4000K
	CRI	90	90 CRI
	REFLECTOR & LM MULTIPLIER	\$20 \$30 \$60	20° specular (1.00) 30° specular (0.99) 60° specular (0.95)
	VOLTAGE	120 277	120V 277V
	DIMMING	D10 ELV	standard driver with flicker free 0-10V dimming to 1% leading & trailing edge dimming (Triac/ELV)
	MOUNTING OPTIONS	IC	insulation contact housing

### ORDERING CODE

Follow the steps to specify your fixture, example: NU6QAXTM13L27K90S20120D10IC

JA8 Series fixtures only available in white trim and bezel.


XTM19 (LED)	POWER
DELIVERED LM	W (90 CRI)
860	11
1120	14


Power Factor ≥ 0.9




# MOUNTING OPTIONS


### **IC - INSULATION CONTACT HOUSING**

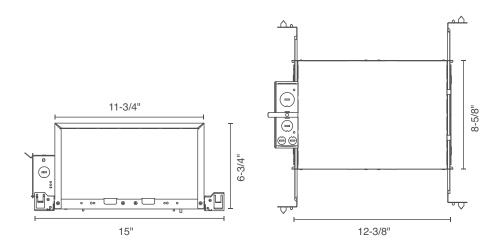

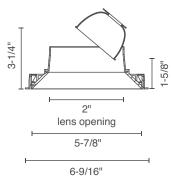

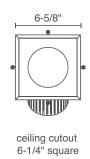

aperture dimensions

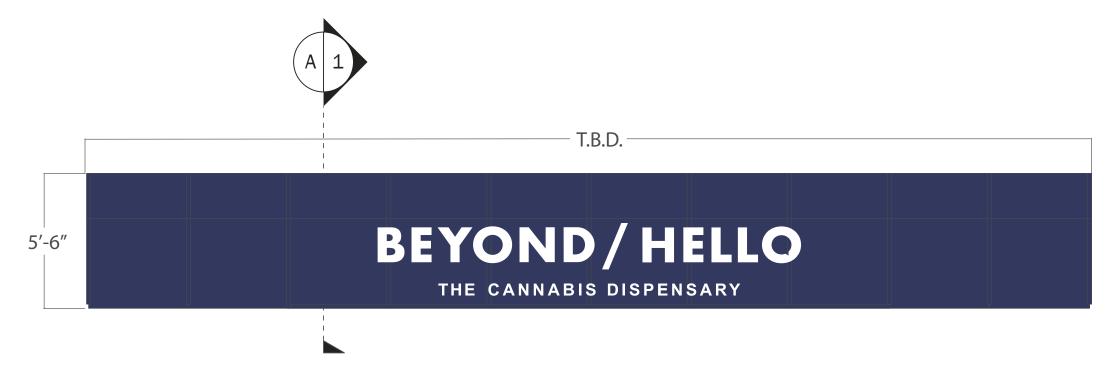

4'-0" PROJECTION

ENDS TO BE FULLY ENCLOSED

(A)

AWNING WITH APPLIED LETTERS

NON-ILLUMINATED ALUMINUM STRUCTURE CANOPY WITH ALUMINUM CLAD SKINS & PAINTED FACADE WITH FLAT CUT 1/2" ACRYLIC GRAPHICS















CLIENT	BEYOND HELLO
FILE NAME	
DATE	November 19, 2021 1:26 PM
PROJECT	PALM SPRINGS, CA



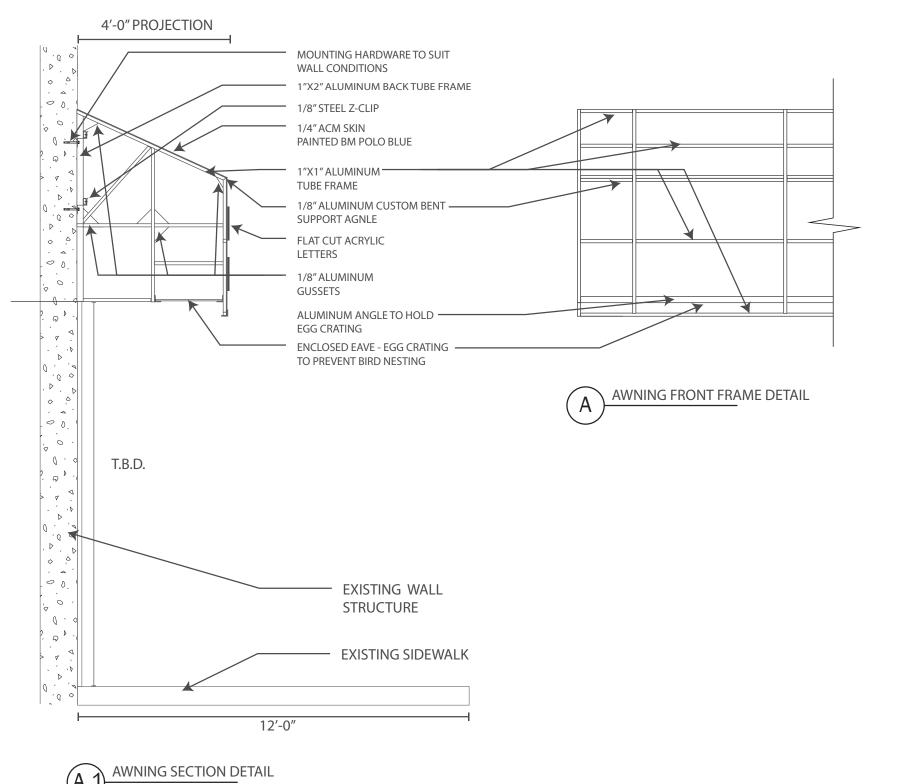

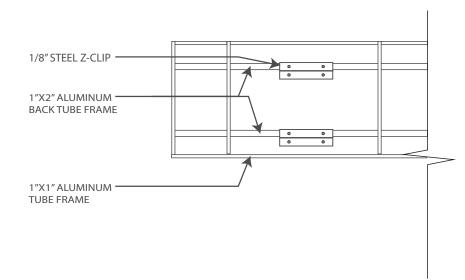

AWNING REAR FRAME DETAIL


PROJECTED VIEW OF AWNING **OVER EXISTING SIDEWALK** 




BEYOND HELLO FILE NAME November 19, 2021 1:26 PM PALM SPRINGS, CA

SHEET 2

REVISION #

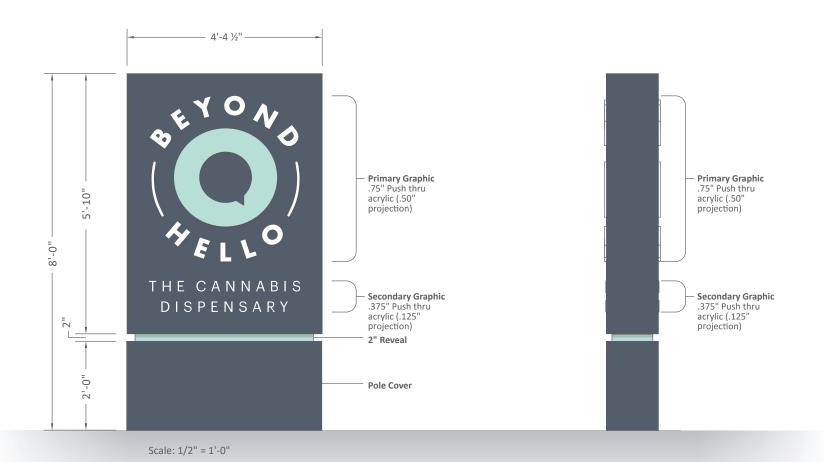

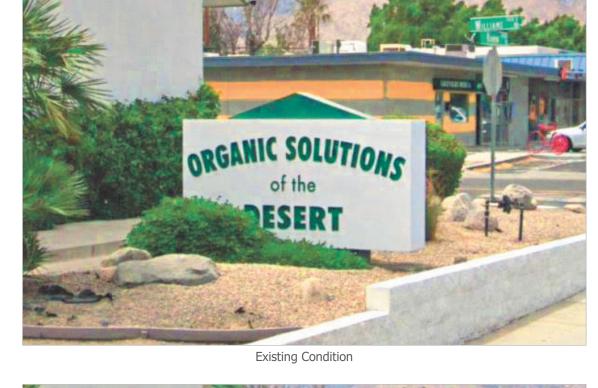

# THE CANNABIS DISPENSARY

Proposed

### **ACTION**

• Manufacture & Install (1) double face, internally illuminated monument sign featuring pushthru acrylic letters/graphic.

### **GENERAL DESCRIPTION**

- D/F Monument cabinet constructed of heavy gauge aluminum and finished in corporate colors.
- All copy to be routed from aluminum faces & "pushed thru" with .75" (primary copy) and .375" (secondary copy) clear acrylic.
- All copy to have 1st surface application of translucent white film and 2nd surface application of
- Internal illumination of cabinet by white LED modules. All wiring UL approved
- 2" Reveal and base fabricated of aluminum & finished in corporate colors
- Sign installed onto steel post (new or existing: TBD) set in concrete foundation

### **COLOR SCHEDULE**

Cabinet & Base: Painted to Match PMS 432 Deep Fog (satin)

Reveal: Painted to Match PMS 572 Vibrant Mint (satin)

1st Surface Vinyl: 3M 3630-20 White

1st Surface Vinyl: Digitally printed to match PMS 572 Vibrant Mint



GLIENT	BEYOND HELLO	N
FILE NAME		
DATE	November 19, 2021 1:26 PM	
PROJECT	PALM SPRINGS, CA	

SHEET

REVISION #

### **BEYOND/ HELLO - PALM SPRINGS - EXTERIOR PAINT**

Permit No.

Project Name Beyond/Hello Palm Springs
Project Location Palm Springs, California

Issuance Date May 13, 2021

This document is created for the purposes of showing the paint proposed for the exterior elevations of the building.

Project address: 4765 E, RAMON RD, PALM SPRINGS CA 92264



Fig. 1 – PT-01 – Sherwin Williams SW 6231 – Rock candy



Fig. 2 – PT-02 – Benjamin Moore – 2062-10 - Polo blue

**EPSTEIN** BEYOND/HELLO PALM SPRINGS (EPN #21108))