

# ARCHITECTURAL REVIEW COMMITTEE MEMORANDUM

DATE: JULY 18, 2022 NEW BUSINESS

SUBJECT: KAPPE ARCHITECTS, ON BEHALF OF MICHAEL SHAHBAZ AND BRIAN

GLASER, FOR MAJOR ARCHITECTURAL AND ADMINISTRATIVE MINOR MODIFICATION APPLICATIONS TO CONSTRUCT A 6,180-SQUARE-FOOT SINGLE-FAMILY RESIDENCE ON A 19,602-SQUARE-FOOT HILLSIDE PARCEL LOCATED AT 850 SOUTH VIA LAS PALMAS (APN: 505-082-011), ZONE R-1-C, SECTION 10 (CASES 3.4329 MAJ &

7.1652 AMM). (NK)

FROM: Development Services Department – Planning Division

#### PROJECT DESCRIPTION:

This is a request for approval of an Architectural Review Application for the construction of a 6,180-square-foot single-family residence, which includes a 1,190-square-foot Accessory Dwelling Unit (ADU), 470-square-foot garage, and 340-square-foot gym, on a hillside parcel. Due to the site's hillside topography, the building height of the rear portion of the proposed residence exceeds the maximum allowable building height of 12 feet at the rear and side yard setbacks. The applicant is seeking a relief from the 12-foot-maximum building height restriction for the building height of 13 feet via an Administrative Minor Modification (AMM) as prescribed in Palm Springs Zoning Code Section 94.06.01(A)(10).

#### **RECOMMENDATION:**

That the Architectural Review Committee approve the application, subject to conditions, which include the following:

- 1. Reduce and rearrange the row of Dwarf Olive near the pool. Dwarf Olive shall be installed sparingly for a more natural appearance.
- 2. Mulga along the south property line shall be installed in such a manner that the trees do not define the property line.
- 3. New planting materials that exceed 3.5 feet in height shall be located out of the cutback area except for the existing California Fan Palm.

#### **BACKGROUND INFORMATION:**

Neighborhood	Neighborhood Meeting/Neighborhood Notice		
06/10/2022	Notice mailed by staff to adjacent property owners notifying that the subject application had been filed with the Planning Division, in accordance with 93.13.00 of the Zoning Code.		
07/06/2022 07/07/2022	Notice mailed by staff to adjacent property owners notifying that the subject project would be reviewed by the Architectural Review Committee on July 18, 2022.		
07/14/2022	The surrounding neighborhood organizations within one (1) mile of the site were sent notice that the proposed project would be reviewed by the Architectural Review Committee on July 18, 2022.		

#### **STAFF ANALYSIS:**

Site Area	
Net Acres	0.45 Acre (19,602 SF)

General Plan and Zoning Designations				
General Plan Designation	Permitted	Compliance		
General Flan Designation	Density	Compliance		
VLDR (Very Low Density	2.1 - 4.0	Υ		
Residential)	DU/AC	(1 DU allowed based on the lot size)		
Zoning Designation				
R-1-C (Single-Family Residential)				

#### Development Standards:

Pursuant to PSZC Section 92.01.03, the following development standards apply:

Standard	Required/ Allowed	Provided	Compliance
Min. Setbacks			
<ul><li>Front (South)</li></ul>	25 Feet	27 Feet	Υ
● Side (West)	20 Feet/	20 Feet/	Υ
, ,	10 Feet	10 Feet	
∙ Side (East)	10 Feet	10 Feet	Υ
• Rear (North)	15 Feet	15 Feet	Y
Max. Lot Coverage	35%	31.5%	Υ

Standard	Required/ Allowed	Provided	Compliance
Max. Building Height	12~18 Feet	13 feet at the rear and side yard setbacks (ADU, Office/Gym/Gar age)	Yes, subject to AMM approval (ADU, Office/Gym/Garage) only. The rest of the residence meets the building height regulation (16'-1" max.)
Building Separation	Min. 6 Feet	12 Feet (Freestanding Shade Structure in the Front Yard)	Y
Perimeter Wall Height		,	
• North	Max. 6 Feet	6 Feet	Υ
<ul><li>South</li></ul>	Max. 6 Feet	6 Feet	Υ
• East	Max. 6 Feet	6 Feet (Existing)	Y
• West	Max. 6 Feet	4.5 ~ 6 Feet	Υ
Parking	2 spaces (Covered)	2 spaces	Y

#### ACCESSORY DWELLING UNIT (ADU):

Pursuant to Palm Springs Zoning Code (PSZC) Section 92.01.01(A)(3), Accessory Dwelling Units (ADUs) are permitted in the R-1-C Zone subject to the requirements of PSZC Section 93.23.14 (ADU Ordinance). The proposed 1,190-square-foot ADU is a Type 1 ADU and meets the following criteria: 1) the project proposes only one ADU for a proposed single-family residence on a single-family lot; 2) the proposed ADU will be located within the proposed single-family residence; 3) the proposed ADU is designed with an exterior entrance that is independent of the primary residence; and 4) the proposed ADU provides setbacks that are satisfactory to the Building & Safety and Fire Department regulations. The proposed driveway is adequate in size to accommodate one (1) unenclosed off-street parking space required for the ADU per PSZC Sections 93.23.14(E)(2)(a) and (d)(i).

#### **BUILDING HEIGHT:**

Pursuant to PSZC Section 92.01.03(B)(5), the maximum allowable building height for a single-family residence is 12 feet measured at a setback. The height can be further increased up to 18 feet following the roof slope ratio of 4:12. Building height is defined in PSZC Section 91.00.10(B) as follows:

"Building height" means the vertical distance plus eighteen (18) inches measured from the average grade at the curb adjacent to the property or from the top of the crown of the roadway if there is no curb, exclusive of exceptions permitted in Section 93.03.00. In the event of hillside lots...the Director or planning commission may establish the point of measurement at a level higher or lower than the curb or crown of street..."

The proposed building pad elevations range from 592 to 595 feet. In accordance with PSZC Section 91.00.10(B) above, the point of building height measurement is set at the elevation of 592 feet where a large portion of the proposed residence will be located. Although the height of the proposed rear portion of the residence (ADU, Office/Gym, Garage) measured from the adjacent grade (elevation 595 feet) is 10 feet, the building height measured from the point of measurement (elevation 592 feet) will be 13 feet. The applicant is requesting a relief from the 12-foot-maximum building height restriction for the rear portion of the residence for the building height of 13 feet. The total building height proposed for this project is 16'-1" (excluding the height of the chimney), which is within the maximum allowable building height of 18 feet for a single-family residence per PSZC Section 92.01.03(B)(5). The projection of the chimney above the building height limit is allowed subject to Planning Director or Planning Commission approval per PSZC Section 93.03.00(A)(1).

#### **PUBLIC COMMENTS:**

As of July 13, 2022, four public comments have been submitted for the proposed project. The comments are attached to this Staff Report for consideration (Attachment #4).

#### Hillside Review Criteria:

PSZC Section 93.13.00(B)(4) requires that architectural review of hillside development shall consider the following criteria:

	Guidelines [PSZC 93.13.00(B)(4)(a)]	Compliance
1.	Rock and soil exposure;	Υ
	The project site was previously developed with a tennis court as a part of the adjacent property to the west (1350 Ladera Circle). Hence, a large portion of the site is relatively level. The site's natural geography, which includes boulders, shrubs, and palms, is retained along the south/front property line. The proposed residence will be situated on the leveled area to minimize site engineering.	
2.	Size of building pad;	Υ
	The proposed building pad size is approximately 8,475 square feet (building pad size includes the building area, covered patio, and a 3-foot buffer), which is 43.2 % of the lot size. The location of the building pad is generally consistent with the flat portion of the parcel. The proposed lot coverage is 31.5% and meets the zoning	
	regulation.	

	Guidelines [PSZC 93.13.00(B)(4)(a)]	Compliance
3.	Design considerations, such as supporting stilts, colors and	Y
	building arrangement;	·
	The project proposes a desert-neutral color palette which is	
	appropriate for a hillside development. The project site was	
	previously developed with a tennis court, and the proposed	
	residence will be primarily located on the leveled portion of the lot.  Retaining walls with deepened footing are proposed for structural	
	support instead of stilts.	
4.	Screening of parking areas;	Υ
	The project proposes a two-car garage. Although the garage	
	opening faces the street, it is located approximately 56 feet away	
	from the driveway approach for minimized visual impact.	
5.	Landscaping plans;	Yes, subject
	The landscape plan proposes rows of dwarf Olive and Mulga in the	to condition
	front yard. Mulga defines the property line, and dwarf Olive placed	
	in a lineal form does not complement the undulated form of the	
	front yard, as well as the general planting pattern of the immediate	
	area. The void created between the rows of Mulga and Olive does	
	not naturally fit within the landscape composition. To address these issues, staff is recommending conditions of approval which	
	require: 1) Reduce and rearrange the row of dwarf Olive; dwarf	
	Olive to be installed sparingly for a more natural appearance; and	
	2) Mulga installation location to be modified in such a manner that	
	the trees will not define the property line for smoother spatial	
	transition to the site's surroundings. As conditioned, the project	
	meets this finding.	
6.	Continuity with surrounding development;	Υ
	As summarized in the Adjacent Property development Comparison	
	Sheet (Attachment #3), the average lot coverage of the site's	
	adjacent properties is 23.7%, which is lower than the proposed	
	project (31.5% proposed). However, the lot coverage of two	
	existing residences on Ladera Circle exceeds the average, and the	
	proposed lot coverage at the project site is comparable to 31.3%	
	at 1345 Ladera Circle. Therefore, the proposed project is	
7.	compatible with the surrounding development.  Sensitivity to existing view corridors.	Υ
' ·	The site's topography slopes down from the northwest corner to	Ĭ
	the southeast corner with a total elevation difference of	
	approximately 15 feet. The finished floor elevation of the adjacent	
	properties to the west and north, which are located at a higher	
	elevation, are 599.25 feet (1350 Ladera Circle) and 612.40 feet	
	(803 W. Stevens Road), respectively. The proposed finished floor	
	at the project site where the highest portion of the building will be	
	located is 592.00 feet. The cross section (Sheet A1.2) exhibits	

Guidelines [PSZC 93.13.00(B)(4)(a)]	Compliance
ample separation distance between the proposed residence and	
the new residence at 803 W. Stevens Road. The eye-level	
elevation at 803 W. Stevens Road is approximately 617.4 feet	
(finished pad height of 612.40 feet plus 5 feet), which will be higher	
than the highest point of the proposed residence (608.08 feet) by	
8.6 feet. The portion of the proposed residence closest to 1350	
Ladera Circle is the 10-foot-high garage. The eye-level at 1350	
Ladera Circle is approximately 604.25 feet (finished floor elevation	
of 599.25 feet plus 5 feet), which is almost identical to the height	
of the garage measured at the elevation of 605.00 feet. This	
indicates that the impact of the proposed residence on the view	
corridors will be insignificant.	

Architectural Review Criteria and Findings: PSZC Section 94.04.00(E) requires the approval authority to evaluate the application and make findings for conformance to the following criteria:

	Criteria and Findings [PSZC 94.04.00(E)]	Compliance
1.	The architectural treatment is consistent on all four sides of the proposed building(s), unless otherwise approved by the ARC;	Υ
	The architectural treatment of the proposed residence is consistent	
	on all sides as exemplified by the extensive integration of vertical (e.g. glazing) and horizontal (e.g. clerestory windows, fascia, steel	
	grille) lines. Identical building materials will be applied on all	
	elevations in a similar yet different fashion for consistency while	
	avoiding a monotonous appearance.	
2.	The design of accessory structures, such as carports, cabanas, and similar accessory structures, shall be consistent with the form,	Y
	materials and colors of the principal building(s), unless otherwise approved by the ARC;	
	The project proposes a freestanding covered patio in the front yard which will be constructed of painted steel and a fabric or perforated metal shade. Both materials are appropriate for the shade structure, and the overall form of the structure incorporates the rectilinear form of the primary residence for continuity.	
3.	The façade elements and fenestration are composed in a harmonious manner;	Υ
	The vertical windows and doors are arranged in such a manner to compensate the strong horizontal profile of the proposed residence. The exterior of the residence is devoid of ornamental features, and the windows and doors add details and rhythm to the	
	building elevations adequately to avoid a static look.	

	Criteria and Findings [PSZC 94.04.00(E)]	Compliance
4.	The proposed materials are consistent with the context of the site,	Y
	adjacent buildings, and the desert environment;	
	The project proposes the use of various construction materials which include weathered and painted steel, plaster, concrete, and	
	anodized aluminum for window systems. These building materials	
	are commonly used locally, and they are appropriate for the desert	
	environment. The project site is adjacent to a Class 1 historic	
	property to the west (1350 Ladera Circle). Although the proposed	
	construction materials may not be exactly identical to those found	
	at the adjacent properties, such materials are contextually	
	appropriate for the neighborhood which exhibits the collection of	
	eclectic architecture and buildings that have been constructed in	
	different periods of architectural significance.	
5.	The proposed color scheme is appropriate to the desert	Υ
	environment and consistent with the site context;	1
	The proposed color palette consists of desert-neutral colors, such	
	as gray, beige, brown, and black, which are appropriate for the	
	desert environment.	
6.	Shading devices and sun control elements, excluding landscape	
	materials, are provided to address environmental conditions and	Y
	solar orientation;	
	The proposed residence is designed with prominent roof overhang	
	for sun control as exemplified by the roof overhang on the south	
7.	elevation which extends to the covered patio in the front yard.  The proposed landscape plan is consistent with the requirements	
' -	of PSMC Chapter 8.60;	Y
	The project proposes turf areas totaling 317 square feet in area.	
	The proposed turf area is approximately 5.3% of the total	
	landscape area (total landscape area: 5,939 SF) and meets the	
	15-percent-maximum turf limitation for a new single-family	
	residential requirement. The proposed plant palette includes	
	materials that are not listed in the Lush & Efficient gardening book.	
	However, they will be generally located in the interior landscape	
	area and they will have little impact on the overall landscape or the site's character.	
8.	The proposed landscape plan is consistent with all applicable	
0.	zoning requirements, including any streetscape requirements,	Yes, as
	landscape buffer requirements, and screening requirements;	conditioned
	Pursuant to PSZC Sections 93.02.00(D)(1) and (2), landscaping	
	which exceeds a height of 3.5 feet is considered a visual	
	obstruction and cannot be located within the corner cutback area.	
	The landscape plan proposes plant materials that exceed 3.5 feet	
	in height in the corner cutback area (e.g. Mexican Fan Palm,	
	Ocotillo, Mexican Grass Tree). To address this issue, staff is	

	Criteria and Findings [PSZC 94.04.00(E)]	Compliance
	recommending a condition of approval, which requires the planting materials that exceed 3.5 feet in height to be located out of the cutback area, except for the existing California Fan Palm. As conditioned, the project meets this criteria.	
9.	The shading for pedestrian facilities on the subject site or abutting public right(s)-of-way is adequate;  A steel trellis is proposed for the main entrance on the west elevation, and shade is provided over the pedestrian path that leads from the driveway to the secondary access to the north	Υ
10	elevation of the primary residence by a roof overhang.	
10.	The proposed lighting plan is consistent with the requirements of PSZC Section 93.21.00, and the proposed lighting will not materially impact adjacent properties;	Yes, as conditioned
	The project proposes the installation of outdoor landscape light fixtures, which include LED spotlight, wide spot lights, and path lights. The light sources are shielded in compliance with the applicable law. A few landscape light fixtures are directed towards	
	the adjacent property, which need to be adjusted. Staff is recommending a condition which requires all outdoor light fixtures to be directed towards the project site. As conditioned, the project meets this criteria.	
11.	Appropriateness of signage locations and dimensions relative to the building façade(s), or appropriateness of the site location for any freestanding signage, as may be warranted for the development type;  Signage is not proposed for the project	N/A
12.	Signage is not proposed for the project.  Screening is provided for mechanical equipment and service yards, so as to screen such facilities from view from public rights-of-way and abutting properties;	Υ
	Mechanical equipment will be installed in the east and west side yards. The equipment will be enclosed by a 6-foot-high wall, and it will be located behind the 6-foot-high weathered steel fence and gate for concealed view from the adjacent streets.	
13.	The proposed application is consistent with any adopted design standards of an applicable specific plan, planned development district, or other applicable adopted design standards and regulations.	N/A
	The project site is located neither within a Specific Plan area nor Planned Development District, and there are no specific design standards or regulations that are applicable to the project.	

Administrative Minor Modification (AMM) Findings:

PSZC Section 94.06.01(B)(3) requires the approval authority to evaluate the application and make findings for conformance to the following criteria:

	nake findings for conformance to the following criteria:	Compliance
1	Guidelines [PSZC 94.06.01(B)(3)]	Compliance
1.	The requested minor modification is consistent with the general plan, applicable specific plan(s) and overall objectives of the zoning ordinance;	Y
	This AMM is requested in accordance with PSZC Section 94.06.01(A)(10), which allows a building height increase up to 30 feet on a hillside property, given that granting such a modification will not have detrimental effect on the adjacent properties. Granting AMM approval will not create detrimental impact on the adjacent properties as analyzed below. Additionally, the AMM approval will not alter the nature of the project, which proposes the construction of a single-family residence in the VLDR (Very Low Density Residential) General Plan land use designation area. Therefore, the requested AMM is consistent with the objectives of	
2.	the General Plan and Zoning Code.  The neighboring properties will not be adversely affected as a result of the approval or conditional approval of the minor modification;	Y
	As noted earlier in this report, AMM approval is requested for the rear portion of the residence where the ADU, gym/office, and garage will be located. The building height of this portion of the residence measured from the adjacent grade is 10 feet. However, the point of building height measurement is set at a lower elevation of 592 feet due to the site's hillside topography. Based on this measurement method, the rear building height is 13 feet and exceeds the 12-foot-maximum permitted at the rear and side yard setbacks. The total building height proposed for the residence is 16'-1", and it is within the maximum allowable building height of 18 feet for a single-family residence. As explained in Criterion 7 of the Hillside Review Criteria above, the proposed building height will not cause visual impact or negatively affect the privacy of the neighboring properties due to elevation difference and setback. Therefore, the project meets this finding.	
3.	The approval or conditional approval of the minor modification will not be detrimental to the health, safety, or general welfare of persons residing or working on the site or in the vicinity; and  The approval of this AMM application will not affect or alter the single-family residential use of the subject property. The proposed residence will be required to be constructed in accordance with the applicable Zoning Code regulations and the California Building Code for safety compliance. Therefore, it will not adversely affect the individuals who live or work on the site or its vicinity.	Y

#### **ENVIRONMENTAL ANALYSIS:**

The proposed development is considered a "project" pursuant to the terms of the California Environmental Quality Act ("CEQA"), and has been determined to be categorically exempt pursuant to Section 15303(a) of the CEQA Guidelines (Class 3, New Single-Family Residence).

#### CONCLUSION:

The proposed project generally meets the applicable development standards except for the building height which is 13 feet measured at the rear of the residence in accordance with PSZC Section 91.00.10(B). Palm Springs Zoning Code Section 94.06.01(A)(10) provides a mechanism which allows the applicant to seek relief from the 12-foot-maximum (at the setbacks) building height regulation, and the applicant has submitted an AMM application to request the increased building height in accordance with applicable law. With regards to the proposed landscape design, the developer shall address the plant height issue in the corner cutback area in the front yard and changes to the rows of Olive and Mulga in the front yard for a more natural appearance, enhanced composition, and smoother spatial transition, as set forth in the conditions of approval. The proposed building design is appropriate for the site, and modifications to the landscape plan to address the design issues will not alter the character of the proposed project. In conclusion, staff recommends that the Architectural Review Committee (ARC) approve the proposed project subject to conditions of approval included in attached draft resolution (Exhibit A).

Architectural Review Committee Memo Case 3.4329 MAJ & Case 7.1652 AMM July 18, 2022 – Page 11 of 11

PREPARED BY:	Noriko Kikuchi, AICP, Associate Planner
REVIEWED BY:	David Newell, AICP, Assistant Director of Planning


#### **ATTACHMENTS**:

- 1. Vicinity Map
- Resolution and Conditions of Approval
   Adjacent Property Development Comparison Sheet
   Aerial View
- 5. Public Comments
- 6. Pool enclosure details
- 7. Plans



### Department of Planning Services Vicinity Map



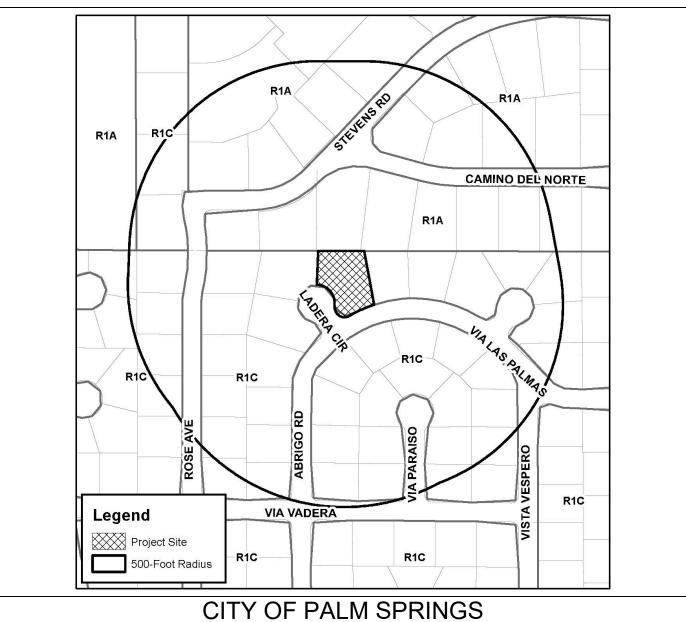

Case 3.4329 MAJ & Case 7.1652 AMM

850 Via Las Palmas Shahbaz/Glaser Residence (APN: 505-082-011)

RESOLUTION NO.	
----------------	--

A RESOLUTION OF THE ARCHITECTURAL REVIEW COMMITTEE OF THE CITY OF PALM SPRINGS. CALIFORNIA, APPROVING MAJOR ARCHITECTURAL AND ADMINISTRATIVE MINOR MODIFICATION APPLICATIONS TO CONSTRUCT A 6,180-SQUARE-FOOT SINGLE-FAMILY RESIDENCE ON A 19,602-SQUARE-FOOT HILLSIDE PARCEL LOCATED AT 850 SOUTH VIA LAS PALMAS (APN: 505-082-011), ZONE R-1-C, SECTION 10 (CASES 3.4329 MAJ & 7.1652 AMM).

#### THE ARCHITECTURAL REVIEW COMMITTEE FINDS AND DETERMINES AS FOLLOWS:

- A. Kappe Architects ("Applicant"), on behalf of Michael Shahbaz and Brian Glaser ("Owners"), filed applications with the City, pursuant to Palm Springs Zoning Code (PSZC) Sections 94.04.00 (Architectural Review), 93.13.00 (Hillside Development), and 94.06.01 (Minor Modifications) of the Palm Springs Zoning Code, for construction of a 6,180-square foot single family residence with the building height of 13 feet for the rear portion of the residence at 850 South Via Las Palmas ("the Project").
- B. On April 8, 2021, the City Council adopted Ordinance No. 2042, amending Section 94.04.00 of the PSZC to reassign review of Major Architectural Review (MAJ) applications from the City's Planning Commission to the City's Architectural Review Committee.
- C. On July 6 and 7, 2022, City staff notified the owners of properties immediately adjacent to the Project site of the scheduling of an Architectural Review Committee meeting to consider the subject application, pursuant to PSZC 93.13.00 (B,1,c).
- D. On July 18, 2022, the City's Architectural Review Committee held a public meeting in accordance with applicable public law. At said meeting, the Architectural Review Committee carefully reviewed and considered all of the evidence presented in connection with the Project, including, but not limited to, the staff report, and all written and oral testimony presented.

#### THE ARCHITECTURAL REVIEW COMMITTEE RESOLVES:

<u>Section 1</u>: The proposed single-family residence is considered a project pursuant to the California Environmental Quality Act (CEQA). The Architectural Review Committee has evaluated the Project pursuant to CEQA and determined it to be Categorically Exempt from further analysis under CEQA Guidelines Section 15303(a) (Class 3, New Construction or Conversion of Small Structures).

<u>Section 2:</u> As demonstrated in the staff report, the Project conforms to the Architectural Guidelines of PSZC Sections 93.13.00 ("hillside development") and 94.04.00 ("architectural review"), in addition to the findings of 94.06.01 (Minor Modifications), subject to conditions.

#### Section 3:

Based upon the foregoing, the Architectural Review Committee hereby approves Case 3.4329 MAJ and Case 7.652 AMM, for the construction of a 6,180-square-foot single-family residence with the building height of 13 feet for the rear portion of the residence located at 850 South Via Las Palmas, subject to the conditions of approval attached herein as Exhibit A.

ADOPTED this 18th day of July, 2022.

AYES:
NOES:
ABSENT:

ATTEST:

CITY OF PALM SPRINGS, CALIFORNIA

David Newell, AICP
Assistant Director of Planning

#### **EXHIBIT A**

Case 3.4329 MAJ & Case 7.1652 AMM

Shahbaz/Glaser Residence (Hillside Single-Family Residence)

850 South Via Las Palmas (APN: 505-082-011)

July 18, 2022

#### **CONDITIONS OF APPROVAL**

Before final acceptance of the project, all conditions listed below shall be completed to the satisfaction of the City Engineer, Development Services Director, Building Official, the Chief of Police, the Fire Chief or their designee, depending on which department recommended the condition.

Any agreements, easements or covenants required to be entered into shall be in a form approved by the City Attorney.

#### **ADMINISTRATIVE CONDITIONS**

- ADM 1. <u>Project Description</u>. This approval is for the project described per Case 3.4329 MAJ and Case 7.1652 AMM except as modified by the conditions below.
- ADM 2. Reference Documents. The site shall be developed and maintained in accordance with the approved plans, which include site plans, architectural elevations, exterior materials and colors, landscaping, and grading on file in the Planning Division except as modified by the conditions below.
- ADM 3. Conform to all Codes and Regulations. The project shall conform to the conditions contained herein, all applicable regulations of the Palm Springs Zoning Ordinance, Municipal Code, and any other City County, State and Federal Codes, ordinances, resolutions and laws that may apply.
- ADM 4. <u>Minor Deviations</u>. The Director of Development Services or designee may approve minor deviations to the project description and approved

plans in accordance with the provisions of the Palm Springs Zoning Code.

- ADM 5. Indemnification. The owner shall defend, indemnify, and hold harmless the City of Palm Springs, its agents, officers, and employees from any claim, action, or proceeding against the City of Palm Springs or its agents, officers or employees to attach, set aside, void or annul, an approval of the City of Palm Springs, its legislative body, advisory agencies, or administrative officers concerning Cases 3.4329 MAJ and Case 7.1652 AMM. The City of Palm Springs will promptly notify the applicant of any such claim, action, or proceeding against the City of Palm Springs and the applicant will either undertake defense of the matter and pay the City's associated legal costs or will advance funds to pay for defense of the matter by the City Attorney. If the City of Palm Springs fails to promptly notify the applicant of any such claim, action or proceeding or fails to cooperate fully in the defense, the applicant shall not, thereafter, be responsible to defend, indemnify, or hold harmless the City of Palm Springs. Notwithstanding the foregoing, the City retains the right to settle or abandon the matter without the applicant's consent but should it do so, the City shall waive the indemnification herein, except, the City's decision to settle or abandon a matter following an adverse judgment or failure to appeal, shall not cause a waiver of the indemnification rights herein.
- ADM 6. Maintenance and Repair. The property owner(s) and successors and assignees in interest shall maintain and repair the improvements including and without limitation all structures, sidewalks, bikeways, parking areas, landscape, irrigation, lighting, signs, walls, and fences between the curb and property line, including sidewalk or bikeway easement areas that extend onto private property, in a first class condition, free from waste and debris, and in accordance with all applicable law, rules, ordinances and regulations of all federal, state, and local bodies and agencies having jurisdiction at the property owner's sole expense. This condition shall be included in the recorded covenant agreement for the property if required by the City.
- ADM 7. <u>Time Limit on Approval</u>. Approval of the Major Architectural Application (MAJ) shall be valid for a period of two (2) years from the effective date of the approval. Extensions of time may be granted by the Planning Commission upon demonstration of good cause.

#### **ENVIRONMENTAL ASSESSMENT CONDITION**

ENV 1. <u>Notice of Exemption</u>. The project is exempt from the California Environmental Quality Act (CEQA), and a Riverside County Clerk processing fee of \$50 will be required.

#### PLANNING DEPARTMENT CONDITIONS

- PLN 1. <u>Building Height</u>. The building height of 13 feet measured at the rear portion of the residence (garage, office/gym, ADU) shall be subject to the approval of the Administrative Minor Modification (AMM) application, Case 7.1652 AMM.
- PLN 2. <u>Pad Elevations</u>. Final building pad elevations shall not vary more than 12 inches above or below the pad elevation established by the approved preliminary grading plan and / or tentative map. Any deviations from this provision shall require approval by the Planning Commission.
- PLN 3. Water Efficient Landscaping Conformance. The project is subject to the Water Efficient Landscape Ordinance (Chapter 8.60.00) of the Palm Springs Municipal Code and all other water efficient landscape ordinances. The applicant shall submit the final landscape and irrigation plans to the Planning Division for review prior to the issuance of a building permit. Prior to the final submission, the landscape plan shall be reviewed and approved (wet-stamped) by the Riverside County Agricultural Commissioner's Office. The landscape plans also shall be certified by the local water agency that the plans are in conformance with the water agency's and the State's Water Efficient Landscape Ordinances. The irrigation plan shall be prepared in accordance with **PSMC** Section 8.60.070 (Irrigation Design (https://library.gcode.us/lib/palm springs ca/pub/municipal code/item/t itle 8-chapter 8 60?view=all). Submit wet-stamp approved plans to the Planning Division.
- PLN 4. Olive (Olea Europa 'Montra'). Remove the row of Olive proposed in the front yard. Instead, install them sparingly for a more natural appearance.
- PLN 5. <u>Mulga (Acacia aneura)</u>. The installation location of Mulga in the front yard shall be modified in such a manner that the trees will not define the property line for smoother spatial transition to the site's surroundings.
- PLN 6. <u>Landscaping in Corner Cutback Area</u>. Planting materials that exceed 3.5 feet in height shall be located out of the cutback area, except for the existing California Fan Palm.
- PLN 7. Outdoor/Landscape Lighting. The light source of all outdoor lighting fixture shall be directed towards the project site. Outdoor/landscape lighting shall not case disability glare, discomfort glare, light trespass, or light pollution as required in the Outdoor Lighting Standards (PSZC Section 93.21.00).

#### **BUILDING DEPARTMENT CONDITIONS**

The Following Standard Building & Safety Conditions of Approval Are Applicable to This Project:

- BLDG 1. Prior to any construction on-site, all appropriate permits must be secured.
- BLDG 2. Shall comply with the latest adopted edition of the following codes as applicable:
  - A. 2019 California Residential Code
  - B. 2019 California Electrical Code
  - C. 2019 California Mechanical Code
  - D. 2019 California Plumbing Code
  - E. 2019 California Energy Code
  - F. 2019 California Fire Code
  - G. 2019 California Green Building Standards Code

#### **ENGINEERING DEPARTMENT CONDITIONS**

Before final acceptance of the project, all conditions listed below shall be completed to the satisfaction of the City Engineer.

All Grading Plans, Improvement Plans, Required Studies and Documents listed below, must be submitted to Engineering Services Department for review and approval.

#### STREETS

- ENG 1. The Engineering Services Department recommends deferral of off-site improvement items (identified as "**Deferred**") at this time due to lack of full improvements in the immediate area. The owner shall execute a street improvement covenant agreeing to construct all required street improvements upon the request of the City of Palm Springs City Engineer at such time as deemed necessary. The covenant shall be executed and notarized by the property owner(s) prior to approval of the Grading Plan or issuance of grading or building permits. A current title report; or a copy of a current tax bill and a copy of a vesting grant deed shall be provided to verify current property ownership. A covenant preparation fee in effect at the time that the covenant is submitted shall be paid by the applicant prior to issuance of any grading or building permits.
- ENG 2. Any improvements within the public right-of-way require a City of Palm Springs Encroachment Permit. All improvements are subject to inspection and a 48-hour inspection notification is required.

ENG 3. Provide revised design due to drainage easement along western property line. Provide determination regarding the necessity of a private drainage easement for the proposed drainage systems meant to direct off-site flows through the property. This information required prior to site plan approval.

#### VIA LAS PALMAS

- ENG 4. Construct a future 5 feet wide sidewalk behind the curb along the entire frontage in accordance with City of Palm Springs Standard Drawing No. 210. **Deferred.**
- ENG 5. Construct a future Type B curb ramp meeting current California State Accessibility standards at the northeastern corner of the intersection of Via Las Palmas and Ladera Circle in accordance with City of Palm Springs Standard Drawing No. 213. **Deferred.**
- ENG 6. Remove and replace existing asphalt concrete pavement where required, in accordance with applicable City standards. **Deferred.**
- ENG 7. All broken or off grade street improvements along the project frontage shall be repaired or replaced.

#### LADERA CIRCLE

- ENG 8. Construct a 6-inch concrete driveway, unless otherwise approved by the City Engineer, from the property line to the existing back of curb.
- ENG 9. Construct a future 5 feet wide sidewalk behind the curb along the entire frontage in accordance with City of Palm Springs Standard Drawing No. 210. **Deferred.**
- ENG 10. Remove and replace existing asphalt concrete pavement where required, in accordance with applicable City standards. **Deferred.**
- ENG 11. All broken or off grade street improvements along the project frontage shall be repaired or replaced.

#### SANITARY SEWER

ENG 12. All sanitary facilities shall be connected to the public sewer system. New laterals shall not be connected at manholes.

#### **GRADING**

- ENG 13. Submit a Precise Grading Plan prepared by a California registered Civil engineer to the Engineering Services Department for review and approval. The Precise Grading Plan shall be approved by the City Engineer prior to issuance of grading permit.
  - A Fugitive Dust Control Plan shall be prepared by the applicant and/or its grading contractor and submitted to the Engineering Services Department for review and approval. The applicant and/or its grading contractor shall be required to comply with Chapter 8.50 of the City of Palm Springs Municipal Code, and shall be required to utilize one or more "Coachella Valley Best Available Control Measures" as identified in the Coachella Valley Fugitive Dust Control Handbook for each fugitive dust source such that the applicable performance standards are met. The applicant's or its contractor's Fugitive Dust Control Plan shall be prepared by staff that has completed the South Coast Air Quality Management District (AQMD) Coachella Valley Fugitive Dust Control Class. The applicant and/or its grading contractor shall provide the Engineering Services Department with current and valid Certificate(s) of Completion from AQMD for staff that have completed the required training. For information on attending a Fugitive Dust Control Class and information on the Coachella Valley Fugitive Dust Control Handbook and related "PM10" Dust Control issues, please contact AQMD at (909) 396-3752, or at http://www.AQMD.gov. A Fugitive Dust Control Plan, in conformance with the Coachella Valley Fugitive Dust Control Handbook, shall be submitted to and approved by the Engineering Services Department prior to approval of the Grading plan.
  - b. The first submittal of the Grading Plan shall include the following information: a copy of final approved conformed copy of Conditions of Approval; a copy of a final approved conformed copy of the Site Plan; a copy of current Title Report; a copy of Soils Report; and a copy of the associated Hydrology Study/Report.
- Prior to approval of a Grading Plan (or issuance of a Grading Permit), the applicant shall obtain written approval to proceed with construction from the Agua Caliente Band of Cahuilla Indians, Tribal Historic Preservation Officer or Tribal Archaeologist (a copy of the written approval must be provided to the City). The applicant shall contact the Tribal Historic Preservation Officer or the Tribal Archaeologist at <a href="ACBCI-THPO@aguacaliente.net">ACBCI-THPO@aguacaliente.net</a> to determine their requirements, if any, associated with grading or other construction. The applicant is advised to contact the Tribal Historic Preservation Officer or Tribal Archaeologist as early as possible. If required, it is the responsibility of the applicant to coordinate scheduling of Tribal monitors during grading or other construction, and to arrange payment of any required fees associated with Tribal monitoring.

- ENG 15. In accordance with an approved PM-10 Dust Control Plan, temporary dust control perimeter fencing shall be installed. Fencing shall have screening that is tan in color; green screening will not be allowed. Temporary dust control perimeter fencing shall be installed prior to issuance of Grading Permit and commencement of grading operations.
- ENG 16. Temporary dust control perimeter fence screening shall be appropriately maintained, as required by the City Engineer. Cuts (vents) made into the perimeter fence screening shall not be allowed. Perimeter fencing shall be adequately anchored into the ground to resist wind loading.
- ENG 17. Within 10 days of ceasing all construction activity and when construction activities are not scheduled to occur for at least 30 days, the disturbed areas on-site shall be permanently stabilized, in accordance with Palm Springs Municipal Code Section 8.50.022. Following stabilization of all disturbed areas, perimeter fencing shall be removed, as required by the City Engineer.
- ENG 18. Prior to issuance of grading permit, the applicant shall provide verification to the City that the Tribal Habitat Conservation Plan (THCP) fee has been paid to the Agua Caliente Band of Cahuilla Indians in accordance with the THCP.
- ENG 19. Drainage swales shall be provided adjacent to all curbs and sidewalks to keep nuisance water from entering the public streets, roadways, or gutters.
- ENG 20. In accordance with City of Palm Springs Municipal Code, Section 8.50.022 (h), the applicant shall post with the City a cash bond of eight hundred dollars (\$800) (if there is disturbance of 5,000 square feet or more) at the time of issuance of grading permit for mitigation measures for erosion/blowsand relating to this property and development.
- ENG 21. A Geotechnical/Soils Report prepared by a California registered Geotechnical Engineer shall be required for and incorporated as an integral part of the grading plan for the proposed development. A copy of the Geotechnical/Soils Report shall be submitted to the Engineering Services Department with the first submittal of a grading plan. (if required)
- ENG 22. The applicant shall provide all necessary geotechnical/soils inspections and testing in accordance with the Geotechnical/Soils Report prepared for the project. All backfill, compaction, and other earthwork shown on the approved grading plan shall be certified by a California registered geotechnical or civil engineer, certifying that all grading was performed in accordance with the Geotechnical/Soils Report prepared for the project. Documentation of all compaction and other soils testing are to be

provided <u>even though there may not be a grading plan for the project</u>. Prior to issuance of Building Permits.

- ENG 23. The applicant shall provide Grading Certification for all building (or structure) pads in conformance with the approved grading plan to the Engineering Services Department for review and approval.
- ENG 24. In cooperation with the California Agricultural Commissioner and the California Department of Food and Agriculture Red Imported Fire Ant Project, applicants for grading permits involving a grading plan and involving the export of soil will be required to present a clearance document from a Department of Food and Agriculture representative in the form of an approved "Notification of Intent To Move Soil From or Within Quarantined Areas of Orange, Riverside, and Los Angeles Counties" (Revised RIFA Form CA-1) prior to approval of the Grading Plan (if required). The California Department of Food and Agriculture office is located at 6819 East Gage Avenue, Commerce, CA 90040 (Phone (760) 782-3271, (562) 505-6415), Sonia.Oran@cdfa.ca.gov.

#### **DRAINAGE**

- ENG 25. All stormwater runoff passing through the site shall be accepted and conveyed across the property in a manner acceptable to the City Engineer. For all stormwater runoff falling on the site, on-site retention or other facilities approved by the City Engineer shall be required to contain the increased stormwater runoff generated by the development of the property. Provide a hydrology study to determine the volume of increased stormwater runoff due to development of the site, and to determine required stormwater runoff mitigation measures for the proposed development. Final retention basin sizing and other stormwater runoff mitigation measures shall be determined upon review and approval of the hydrology study by the City Engineer and may require redesign or changes to site configuration or layout consistent with the findings of the final hydrology study. No more than 40-50% of the street frontage parkway/setback areas should be designed as retention basins. On-site open space, in conjunction with dry wells and other subsurface solutions should be considered as alternatives to using landscaped parkways for on-site retention.
- ENG 26. The project is subject to flood control and drainage implementation fees. The acreage drainage fee at the present time is \$10,311.99 per acre in accordance with Resolution No. 15189. Fees shall be paid prior to issuance of a building permit.

#### **GENERAL**

- ENG 27. Any utility trenches or other excavations within existing asphalt concrete pavement of off-site streets required by the proposed development shall be backfilled and repaired in accordance with City of Palm Springs Standard Drawing No. 115.
- ENG 28. All proposed utility lines shall be installed underground.
- ENG 29. All existing utilities shall be shown on the improvement plans if required for the project. The existing and proposed service laterals shall be shown from the main line to the property line.
- ENG 30. Upon approval of any improvement plan (if required) by the City Engineer, the improvement plan shall be provided to the City in digital format, consisting of a DWG (AutoCAD drawing filetype), DXF (AutoCAD ASCII drawing exchange filetype), and PDF (Adobe Acrobat document filetype) formats. Variation of the type and format of the digital data to be submitted to the City may be authorized, upon prior approval by the City Engineer.
- ENG 31. The original improvement plans prepared for the proposed development and approved by the City Engineer (if required) shall be documented with record drawing "as-built" information and returned to the Engineering Services Department prior to issuance of a final certificate of occupancy. Any modifications or changes to approved improvement plans shall be submitted to the City Engineer for approval prior to construction.
- ENG 32. Nothing shall be constructed or planted in the corner cut-off area of any intersection or driveway which does or will exceed the height required to maintain an appropriate sight distance per City of Palm Springs Zoning Code Section 93.02.00, D.
- ENG 33. All proposed trees within the public right-of-way and within 10 feet of the public sidewalk and/or curb shall have City approved deep root barriers installed in accordance with City of Palm Springs Standard Drawing No. 904.

#### TRAFFIC

- ENG 34. All damaged, destroyed, or modified pavement legends, traffic control devices, signing, striping, and streetlights, associated with the proposed development shall be replaced as required by the City Engineer prior to issuance of a Certificate of Occupancy.
- ENG 35. Construction signing, lighting and barricading shall be provided during all phases of construction as required by City Standards or as directed by the City Engineer. As a minimum, all construction signing, lighting and barricading shall be in accordance with Part 6 "Temporary Traffic Control"

of the California Manual on Uniform Traffic Control Devices (CAMUTCD), dated November 7, 2014, or subsequent editions in force at the time of construction.

ENG 36. This property is subject to the Transportation Uniform Mitigation Fee which shall be paid prior to issuance of building permit.

#### FIRE DEPARTMENT CONDITIONS

- FID 1. These Fire Department conditions may not provide all requirements. Owner/developer is responsible for all applicable state and locally adopted fire codes. Detailed plans are still required for review. Conditions are subject to final plan check and review.
- FID 2. Fire Department Conditions were based on the 2019 California Fire Code as adopted by City of Palm Springs, Palm Springs Municipal Code, PSFD Appendix "T" Development Requirements. This building will require fire sprinklers.
- FID 3. Materials and Construction Methods for Exterior Wildfire Exposure: All Materials and Construction Methods shall comply with Chapter 7A of the Building Code for High Fire Areas.
- FID 4. Conditions of Approval "Conditions of Approval" received from the Palm Springs Planning Department must be submitted with each plan set. Failure to submit will result in a delay of plan approval.
- FID 5. Plans and Permits (CFC 105.1):

Permits and scaled drawings are required for this project. Plan reviews can take up to 20 working days. Submit a minimum of three (3) sets of drawings for review. Upon approval, the Fire Prevention Bureau will retain one set.

Plans shall be submitted to:

City of Palm Springs

**Building and Safety Department** 

3200 E. Tahquitz Canyon Way

Palm Springs, CA 92262

Counter Hours: 8:00 AM – 6:00 PM, Monday – Thursday

A deposit for Plan Check and Inspection Fees is required at the time of Plan Submittal. These fees are established by Resolution of the Palm Springs City Council.

Complete listings and manufacturer's technical data sheets for all system materials shall be included with plan submittals. All system materials shall be UL listed or FM approved for fire protection service and approved by the Fire Prevention Bureau prior to installation.

Plans shall include all necessary engineering features, including all hydraulic reference nodes, pipe lengths and pipe diameters as required by the appropriate codes and standards. Plans and supporting data, (calculations and manufacturers technical data sheets) including fire flow data, shall be submitted with each plan submittal. Complete and accurate legends for all symbols and abbreviations shall be provided on the plans.

- FID 6. Access During Construction (CFC 503): Access for firefighting equipment shall be provided to the immediate job site at the start of construction and maintained until all construction is complete. Fire apparatus access roads shall have an unobstructed width of not less than 24 feet and an unobstructed vertical clearance of not less than 13'-6". Fire Department access roads shall have an all-weather driving surface and support a minimum weight of 73,000 lbs.
- FID 7. Required access (CFC 504.1): Exterior doors and openings required by this code or the California Building Code shall be maintained readily accessible for emergency access by the fire department. An approved access walkway leading from fire apparatus access roads to exterior openings shall be provided when required by the fire code official.
- FID 8. NFPA 13D Fire Sprinklers Required: An automatic fire sprinkler system is required. Only a C-16 licensed fire sprinkler contractor shall perform system design and installation. System to be designed and installed in accordance with NFPA standard 13D, 2016 Editions, as modified by local ordinance.
- FID 9. Residential Smoke Alarms Required: Shall be interconnected so that operation of any smoke alarm or fire sprinkler flow switch causes all smoke alarms within the dwelling & guest house to sound and activate the exterior horn/strobe

#### **END OF CONDITIONS**

	Property	General Plan	Zone	Lot Size (Acre)	Residence Size* (Includes Garage/Carport)	Lot Coverage	
1	850 Via Las Palmas (Project Site)	VLDR	R-1-C	0.45	6,180 SF	31.5%	
2	1350 Ladera Circle	VLDR	R-1-C	0.48	5,505 SF	26.3%	
3	1345 Ladera Circle	VLDR	R-1-C	0.45	6,130 SF	31.3%	
4	877 Via Las Palmas	VLDR	R-1-C	0.27	3,160 SF	26.9%	
5	855 Via Las Palmas	VLDR	R-1-C	0.27	Data Not Available	N/A	
6	840 Via Las Palmas	VLDR	R-1-C	0.32	2,882 SF	20.7%	
7	777 Camino Del Norte	ER	R-1-A	0.60	4,747 SF	18.2%	
8	803 W. Stevens	ER	R-1-A	0.63	5,170 SF**	18.8 %	
	Average – Existing (Excludes 855 Via Las Palmas) 23.7%						

<sup>\*</sup>Data obtained from City of Palm Springs GISNexus Parcel Explorer \*\*New SFR in construction. Per Resolution No. 1003.







From: Doug Barnum <dsbarnum@gmail.com>
Sent: Wednesday, July 06, 2022 7:33 PM

To: Noriko Kikuchi

**Subject:** 850 South Via Las Palmas

**NOTICE:** This message originated outside of The City of Palm Springs -- **DO NOT CLICK** on **links** or open **attachments** unless you are sure the content is safe.

Hi Noriko,

I write to you and the ARC to enthusiastically embrace the proposed new design for the Shahbaz / Glaser residence at 850 S Via Las Palmas.

My partner and I reside at 1345 Ladera Circle, directly across the circle from the proposed building site. We're about to begin our own renovation project, and along

with the "Elvis house" renovation between us, it is great to see all 3 lots on the circle reach their potential.

We love this design, and appreciate the massing and the siting on the lot. In particular, tucking the garage and ADU back against the sharp upslope at the N lot line seems ideal.

The materials palette is pleasant and harmonious with the surrounding properties. We would wholeheartedly welcome this addition to the neighborhood as presented in the mailing.

Best regards,

Douglas Barnum 1345 Ladera Cir

p.s. Apologies for this letter being a bit tardy-- I've been getting over Covid, like everyone else, the past week or so.

From: Dan Bridge <br/>
Sent: Dan Bridge <br/>
Wednesday, July 06, 2022 10:29 PM

To: Noriko Kikuchi

**Cc:** Michael Shahbaz; brianjasonglaser1@gmail.com

**Subject:** In support of 850 via Las Palmas

**NOTICE:** This message originated outside of The City of Palm Springs -- **DO NOT CLICK** on **links** or open **attachments** unless you are sure the content is safe.

Ms. Noriko Kikuchi
Associate Planner
City of Palm Springs
3200 E. Tahquitz Canyon
Palm Springs, CA 92262
noriko.kikuchi@palmspringsca.gov

July 6,2022

Dear Ms. Kikuchi,

I am co-owner of the Palm Springs Class 1 Historic Alexander Residence (aka The House of Tomorrow).

This note is to indicate my support for home proposed by Michael Shahbaz and Brian Glaser next door to me, at 850 Via las Palmas.

The owners have taken care to select a design, materials, and landscape that will fit well into the Vista las Palmas neighborhood.

Please know that I support this project and look forward to its completion and to having Michael and Brian as neighbors.

Sincerely,

Rabbi Dan Bridge 1350 Ladera Circle Palm Springs, CA 92262

**From:** fracarpsla@aol.com

**Sent:** Saturday, July 09, 2022 10:10 AM

To: Noriko Kikuchi

**Subject:** new home 850 Via Las Palmas

**NOTICE:** This message originated outside of The City of Palm Springs -- **DO NOT CLICK** on **links** or open **attachments** unless you are sure the content is safe.

Dear Noriko I am the owner of the house at 840 Via Las Palmas in Palm Springs and the next door neighbor to Brian Glaser and Michael Shahbaz. I am completely supportive of the new home that's going to be built on the lot next to me at 850 Via Las Palmas. The landscape design, material palette, and overall feel of the proposed design will only enhance our neighborhood. The simplicity of the architectural lines, along with the house layout, has been well thoughtfully designed and will maintain the aesthetic standards that this neighborhood has become known for. I fully support this project and look forward to its completion Best, Frank Carroll

From: kevin@kevinjcorcoran.com

Sent: Monday, July 11, 2022 11:15 AM

To: Noriko Kikuchi

**Cc:** kevin@kevinjcorcoran.com

**Subject:** 850 Via Las Palmas Review - questions for staff and ARC

**NOTICE:** This message originated outside of The City of Palm Springs -- **DO NOT CLICK** on **links** or open **attachments** unless you are sure the content is safe.

#### Noriko:

Thanks for sharing information and providing direction for the review of 850 Via Las Palmas. As you know, we provided a list of questions from several homeowners to the owners and had a zoom call with their architect, Finn Kappe. Based on information shared in the call, here are a list of comments and questions that we would like to share with city staff and the ARC.

- 1. Requested Adminstrative Minor Modification to increase roof height to 19 feet ++. Is it necessary? The architect said that the proposed roof height and overall density of the plan would not impact views from the east or the north of the property. We suggested that the architect (or contractor) conduct a story pole test and provide sight renderings from the properties to the north as was done for all impacted neighbors when we submitted the application for 803 Stevens Road. None of these renderings were included in the orignal packet. We would like to see this information and the story pole test before the review is completed.
- 2. Roof top solar panels on the north roof of the property can they be moved? We were told that the proposed landscaping plan from 803 Stevens would more than cover the exposed panels on the north side of the property. The plan does not include tall trees in the middle of the lot to block the proposed house or solar panels. Is there another spot for these panels?
- 3. **Replacing 2 jacaranda trees proposed for the back wall can they be replaced?** Several neighbors were concerned with the choice of jacaranda trees on the north side of the house. The concern was that the trees grow very large quickly blocking views and are extremely messy. My landscape architect, Bennett Peterbaugh, suggested other, less obtrusive options. Would like to see the landscape update reflecting the changes.
- 4. **Roof color Tan.** We requested a physical sample of the roof color and are awaiting follow up from the architect.
- 5. Engaging more than the 7 neighbors that boarder the property, why not? The owners have not been transparent with enough neighbors about this project. It is concerning that only 7 neighbors were contacted about this application and that the review session is scheduled for July when most neighbors have left the desert for the summer. I think the neighbors on Stevens Rd, Camino del Norte and especially Via Las Palmas need to see the plans and understand the density, scale and design of the home and its impact on the street. The project plans should be shared with all neighbors within 500 feet which has been standard for other projects of this nature and in this neighborhood.

Let me know if you have any questions.


All the best,


Kevin Kevin J. Corcoran P.O. Box 5537 Palm Springs, CA 92263

#### Kevin@kevinjcorcoran.com www.kevinjcorcoran.com

(206) 617-9098

BCC: Neighbors on Stevens, Camino Norte and Via Las Palmas

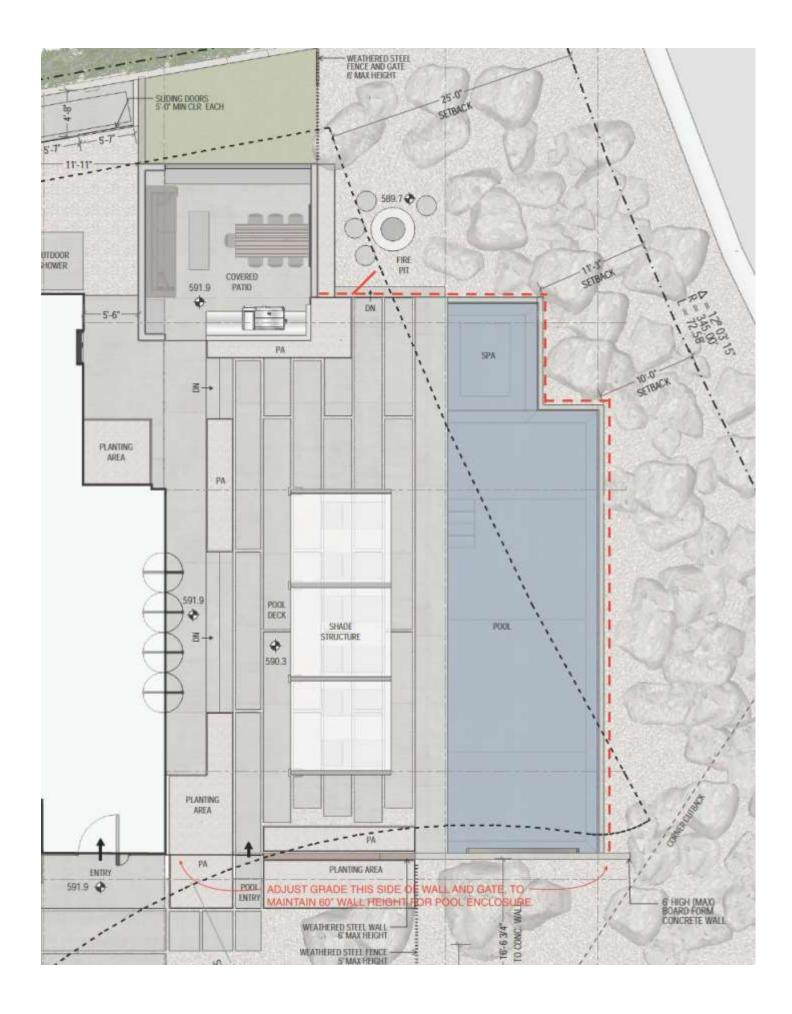

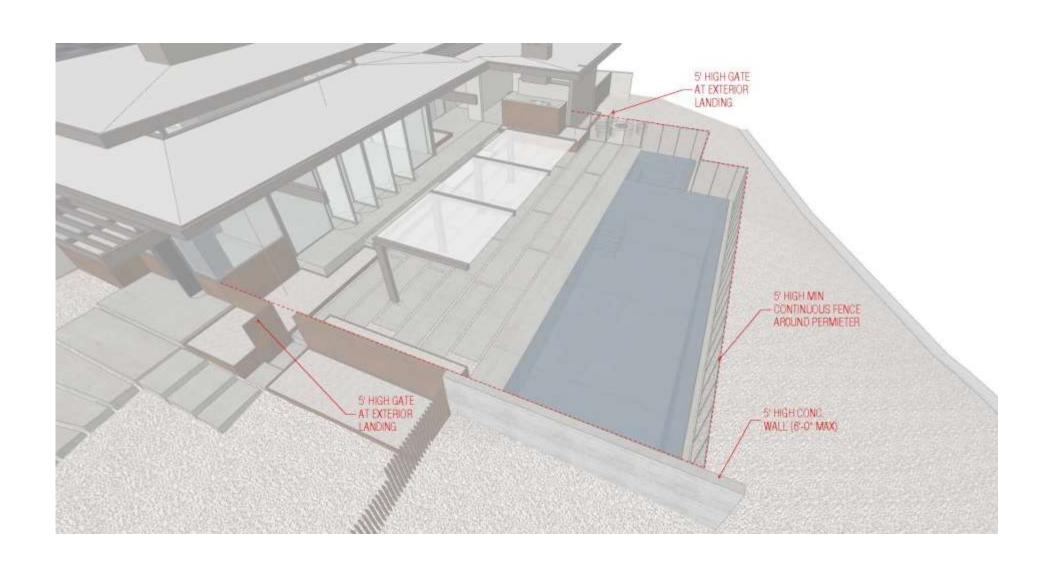

# SHAHBAZ/GLASER RESIDENCE

# 850 VIA LAS PALMAS

# PALM SPRINGS, CALIFORNIA

SURVEYOR:

760.346.8016

760.346.8016

LANDSCAPE:

801 D STREET

KAPPE ARCHITECTS

SAN RAFAEL, CA 94901

GEOTECHNICAL:

FIERO ENGINEERING, INC.

PALM DESERT, CA 92211

FIERO ENGINEERING, INC.

PALM DESERT, CA 92211

EARTH SYSTEMS PACIFIC

BERMUDA DUNES, CA 92203

79-811 COUNTRY CLUB DRIVE, SUITE B

75060 GERALD FORD DRIVE

75060 GERALD FORD DRIVE

### VICINITY MAP



### FIRE DEPARTMENT NOTES

FIRE DEPARTMENT NOTES (NFPA 13D):

I. THE INSTALLATION OF THE SPRINKLER SYSTEM OR MODIFICATIONS TO EXISTING SPRINKLER SYSTEMS SHALL COMPLY WITH: - NFPA 13D

- CALIFORNIA RESIDENTIAL CODE (2019 EDITION) - CALIFORNIA FIRE CODE (2019 EDITION)

THE CITY OF PALM SPRINGS MUNICIPAL CODE CHAPTER 8, SECTIONS 8.04.500 AND 8.04.510 - PALM SPRINGS FIRE DEPARTMENT DEVELOPMENT REQUIREMENTS. APPENDIX "T"

2. WATER FLOW SWITCH AND ALARM. A WATER FLOW SWITCH SHALL BE INSTALLED IN EVERY DWELLING UNIT FIRE SPRINKLER SYSTEM. THE SYSTEM SHALL INCLUDE: - AN APPROVED AUDIBLE SPRINKLER FLOW ALARM (HORN/STROBE WITH WEATHER-PROOF BACK

BOX OR EQUAL) SHALL BE PROVIDED ON THE EXTERIOR OF THE BUILDING IN AN APPROVED LOCATION. THE HORN/STROBE SHALL BE OUTDOOR-RATED. INTERCONNECTED SO THAT OPERATION OF ANY SMOKE ALARM OR FIRE SPRINKLER FLOW SWITCH CAUSES ALL SMOKE ALARMS WITHIN THE DWELLING TO SOUND AND ACTIVATE THE EXTERIOR HORN/STROBE. THE WIRING OF THIS SYSTEM SHALL BE IN ACCORDANCE WITH THE

**GMEP ENGINEERS** 26439 RANCHO PKWY S., SUITE 120 LAKE FOREST, CA 92630 949.267.9095

AND POOL DESIGN: GM FUTURE DESIGNS, INC P.O. BOX 5703, LA QUINTA, CA. 92248

# PROJECT TEAM

MICHAEL SHAHBAZ AND BRIAN GLASER 325 W 13TH STREET UNIT 2 NEW YORK, NEW YORK 10014

ARCHITECT: KAPPE ARCHITECTS SAN RAFAEL, CA 94901

TARZANA, CA 91356

STRUCTURAL: REISS, BROWN, EKMEKJI, INC. 18980 VENTURA BOULEVARD SUITE 350

818.757.1501

LANDSCAPE LIGHTING, IRRIGATION,

## PROJECT DATA

SCOPE OF WORK: NEW SINGLE-FAMILY RESIDENCE AND ATTACHED ADU WITH TWO-CAR GARAGE, POOL AREA WITH SHADE STRUCTURE AND SPA, PHOTOVOLTAIC ARRAYS, AND SITE LANDSCAPING.

ZONE: R1C

HILLSIDE PARCEL: YES

OCCUPANCY: R-3/U

LOT AREA: .45 AC PER RIVERSIDE COUNTY ASSESSOR

MAX LOT COVERAGE: 35%

PROJECT AREAS: RESIDENCE: 4,180 SF 1,190 SF OFFICE / GYM: 340 SF

TOTAL:

LOT COVERAGE: 6,180 SF/19,602 SF = 31.5%

SETBACKS: FRONT YARD: 25'-0" CUL-DE-SAC: 20'-0" SIDE YARDS: 10'-0" REAR YARD: 15'-0"

> BUILDING HEIGHT: 21'-7 1/2" TO ROOF EAVE FROM CALCULATED BUILDING HEIGHT ELEVATION DATUM PER PSZC 91.00.10

### INDEX OF DRAWINGS

T1.5 SURVEY

T1.0 COVER SHEET AND PROJECT INFORMATION

ARCHITECTURAL

A1.0 SITE PLAN

A1.2 SITE SECTIONS

A2.1 FLOOR PLAN A2.3 ROOF PLAN

A3.1 BUILDING ELEVATIONS

A4.1 BUILDING SECTIONS

A8.0 EXTERIOR COLORS AND MATERIALS

A8.1 SITE PHOTOS

A9.0 PERSPECTIVE VIEWS

C1.1 PRELIMINARY GRADING PLAN C1.2 PRELIMINARY GRADING PLAN

L1.1 LANDSCAPE AND PLANTING PLAN L1.1A LANDSCAPE PLANT PALETTE

L1.2 LANDSCAPE LIGHTING PLAN L2.1 IRRIGATION PLAN

L2.2 IRRIGATION DETAILS

EX1 ADDITIONAL VIEWS

TO ADDRESS NEIGHBOR CONCERNS AND SITE

MODIFICATIONS TO BUILDING ELEVATIONS (A3.1) AND BUILDING SECTIONS (A4.1) AT THE REAR

REVISIONS TO **20220624 Drawing Package** 

CONDITIONS AT THE REAR YARD:

SITE WALL AND FENCING AT NORTH PROPERTY LINE CLARIFIED ON NORTH ELEVATION, SHOWING EXISTING GRADE, OUTLINE OF SITE WALL, AND OUTLINE OF FENCING. FENCING ADDED TO BUILDING SECTIONS AT NORTH PROPERTY LINE

MODIFICATIONS TO LANDSCAPE AND PLANTING PLAN (**L1.1**) AT THE REAR YARD:

-CERCIDIUM X DESERT MUSEUM (PALO VERDE) SUBSTITUTED FOR JACARANDA MIMOSIFOLIA

-BOUGAINVILLEA COLOR CHANGED FROM PURPLE TO CALIFORNIA GOLD

-ALOE TONGAENSIS 'MEDUSA' (MOZAMBIQUE TREE ALOE) SUBSTITUTED FOR HYOPHORBE LAGENICAULIS (BOTTLE PALM)

LANDSCAPE PLANT PALETTE (**L1.1A**)

ADDED FOR FURTHER CLARIFICATION OF PLANT EXHIBIT SHEET OF ADDITIONAL VIEWS (EX1) ADDED FOR FURTHER CLARIFICATION OF SITE

CONDITIONS AT THE NORTH PROPERTY LINE AND

850 VIA LAS PALMAS PALM SPRINGS, CA 92262

APN: 505082011

MAJ REVIEW 06/24/2022 All drawings and written material herein are the original and unpublished property of and all rights are reserved by Kappe Architects. The same

Material herein is for use by authorized contractors, bidders and subcontractors in connection with this project only. All dimensions on Contractors shall be responsible to verify all dimensions and conditions on the job. This office must be notified of any variations from the dimensions and conditions shown by these drawings. Shop drawings must be reviewed by this office before proceeding with fabrication.

**COVER SHEET AND PROJECT INFORMATION** 

Sheet Number:

Project: 850 VIA LAS PALMAS PALM SPRINGS, CA 92262

APN: 505082011



 Project No.:
 21002

 Drawn By:
 JK

Checked By: FK

MAJ REVIEW 06/24/2022

MAJ REVIEW 06/24/2022 REV1 07/11/2022

All drawings and written material herein are the original and unpublished property of and all rights are reserved by Kappe Architects. The same may not be duplicated, used without written or disclosed consent. Material herein is for use by authorized contractors, bidders and subcontractors in connection with this project only. All dimensions on these drawings shall take precedence over scaled dimensions. Contractors shall be responsible to verify all dimensions and conditions

these drawings shall take precedence over scaled dimensions.


Contractors shall be responsible to verify all dimensions and conditions on the job. This office must be notified of any variations from the dimensions and conditions shown by these drawings. Shop drawings must be reviewed by this office before proceeding with fabrication.

Sheet Title: SURVEY

Scale: 1" = 1'-0"

Sheet Number:

T1.5

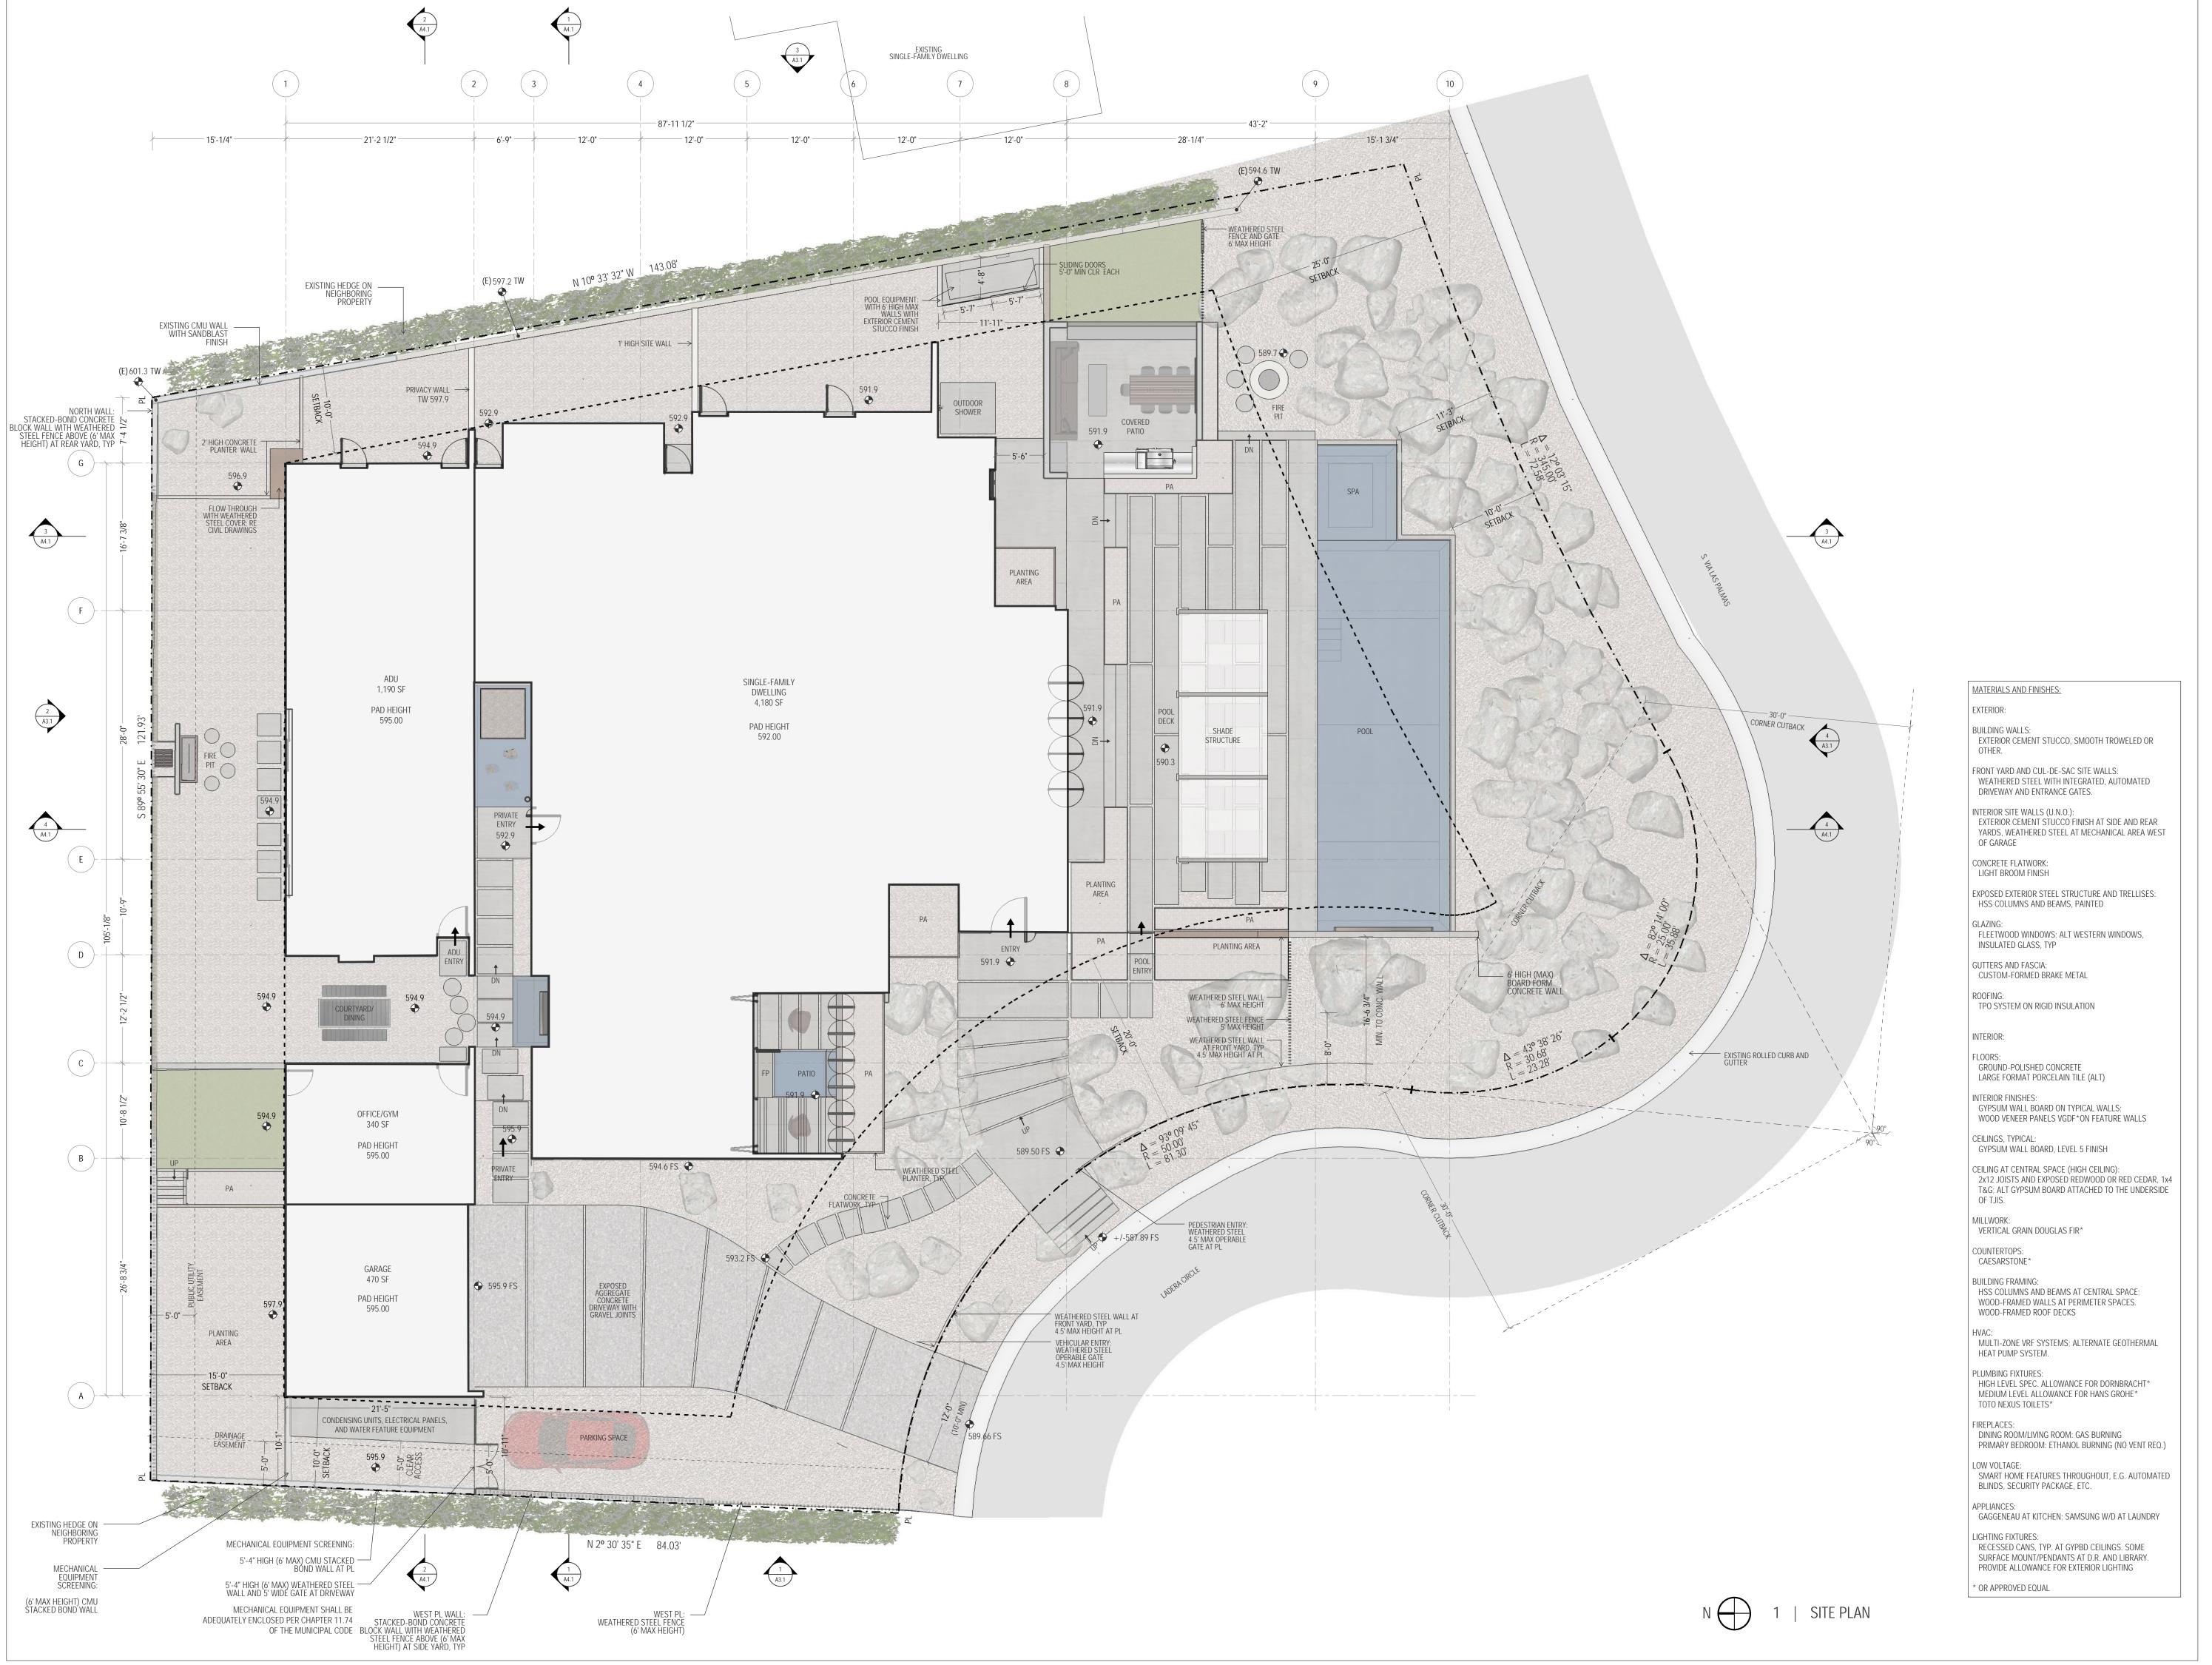

SIDENCE Ŋ

SHAHB/

Project: 850 VIA LAS PALMAS PALM SPRINGS, CA 92262

RON H. KAPPE

C-18457

6-30-2023

All drawings and written material herein are the original and unpublished

property of and all rights are reserved by Kappe Architects. The same

Contractors shall be responsible to verify all dimensions and conditions

may not be duplicated, used without written or disclosed consent.

Material herein is for use by authorized contractors, bidders and subcontractors in connection with this project only. All dimensions on

these drawings shall take precedence over scaled dimensions.

on the job. This office must be notified of any variations from the

must be reviewed by this office before proceeding with fabrication.

dimensions and conditions shown by these drawings. Shop drawings

RENEWAL DATE

OF CALIFO

21002

APN: 505082011

Registration:

Project No.:

Drawn By:


Checked By:


MAJ REVIEW 06/24/2022


REV1 07/11/2022


Sheet Title: SITE PLAN

Scale: 1/8" = 1'-0"

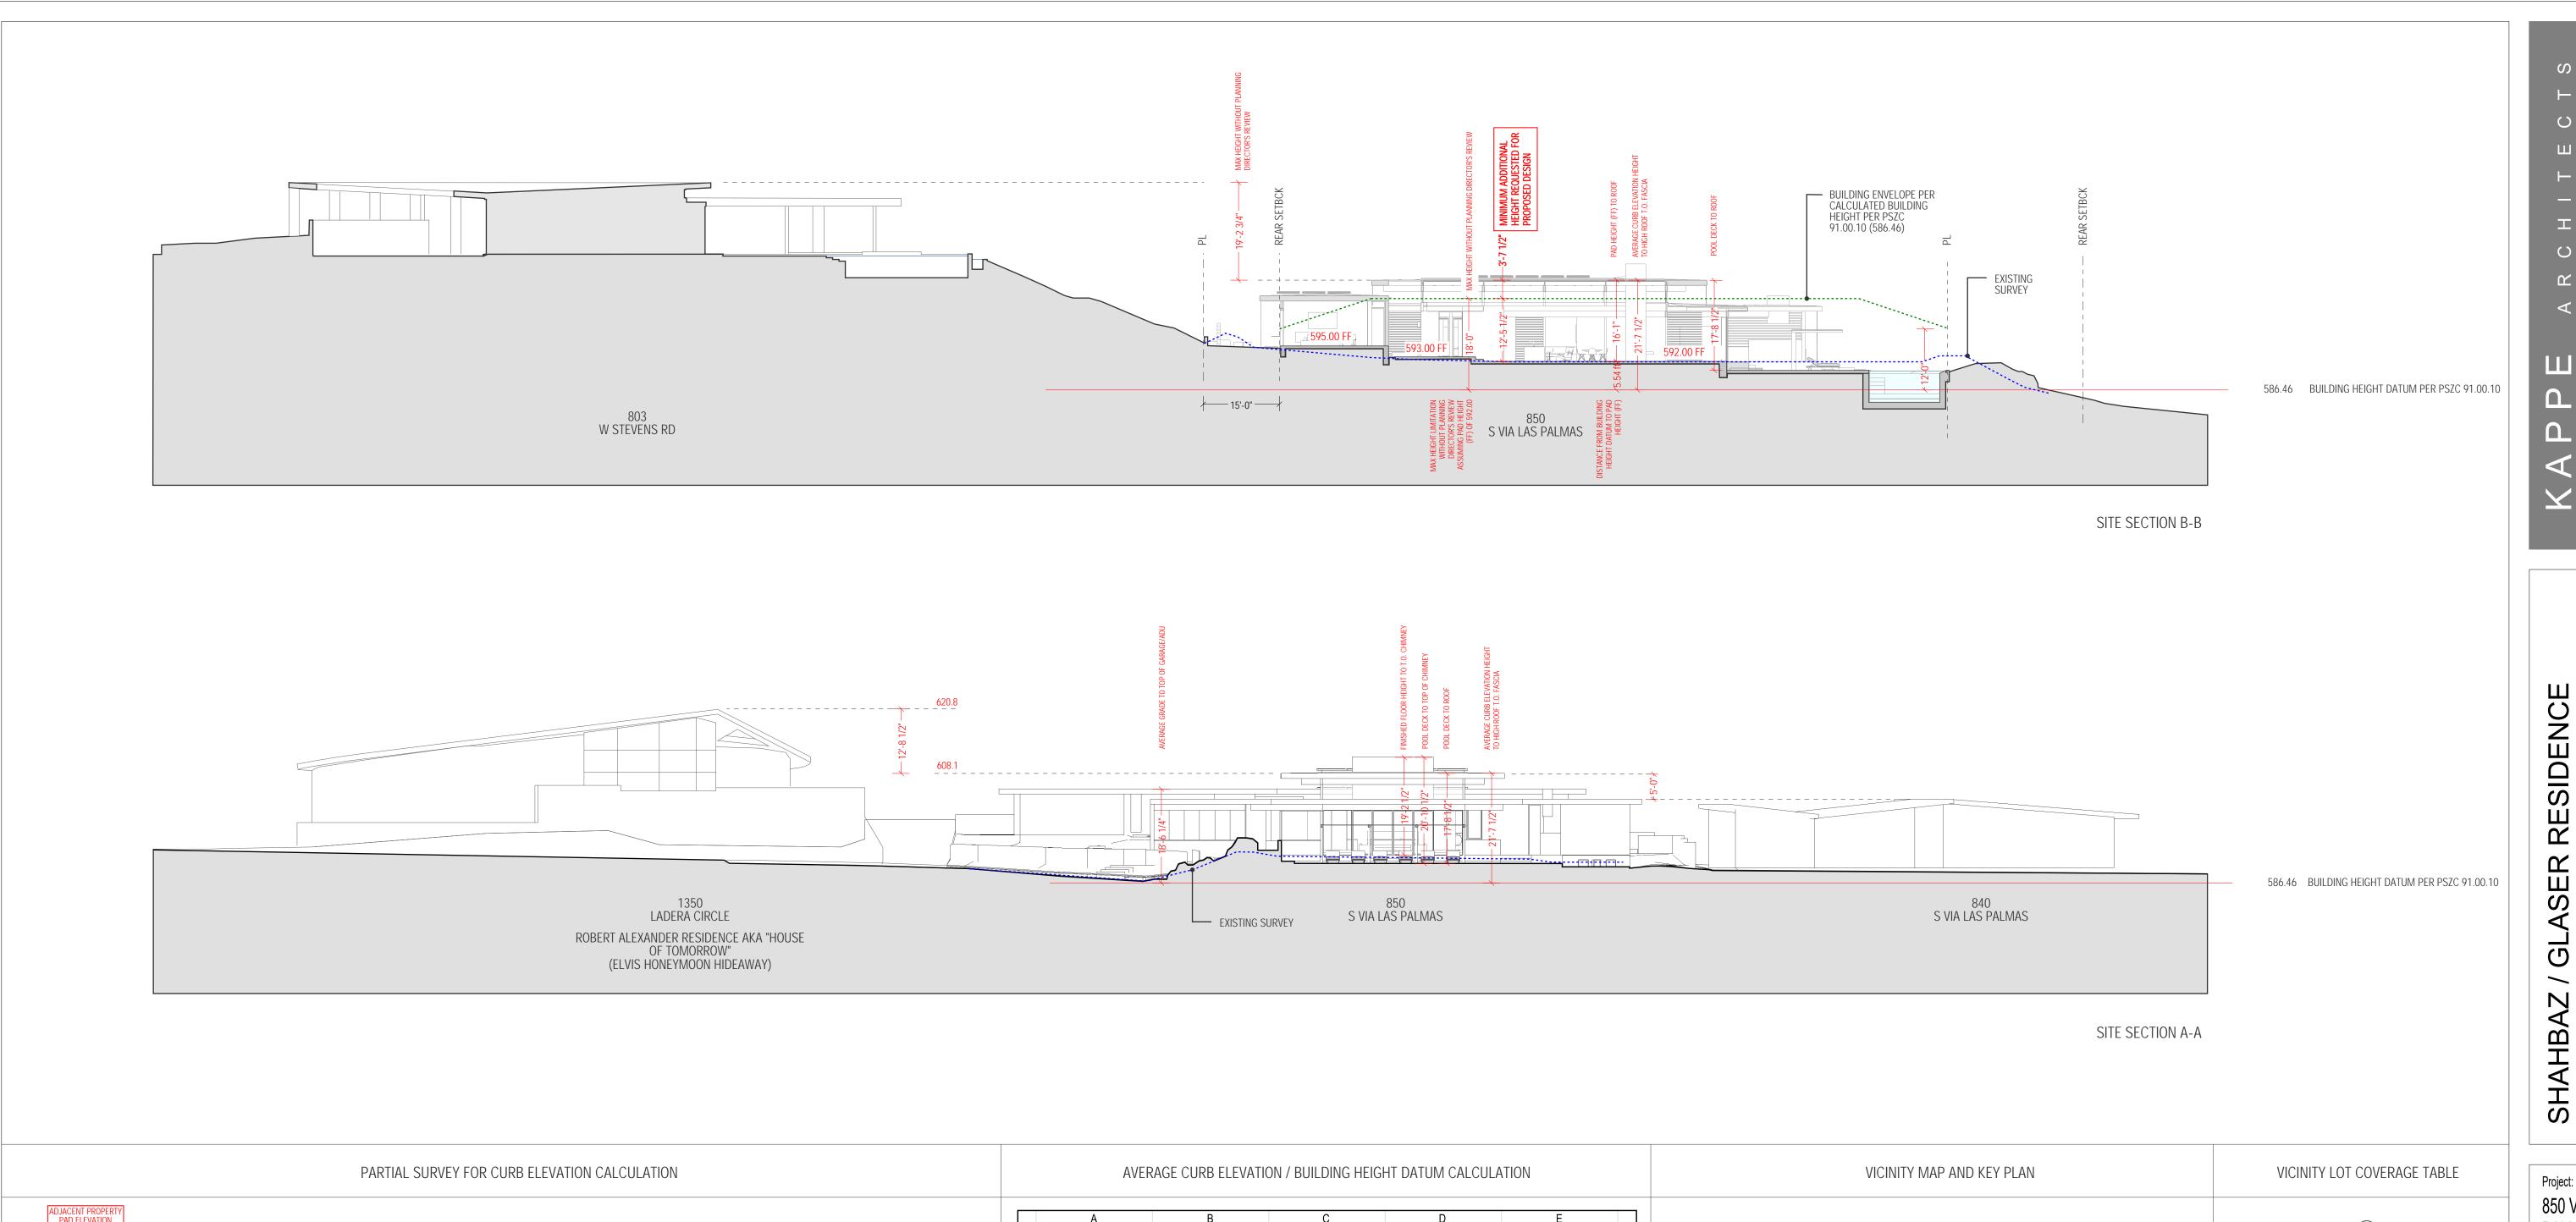

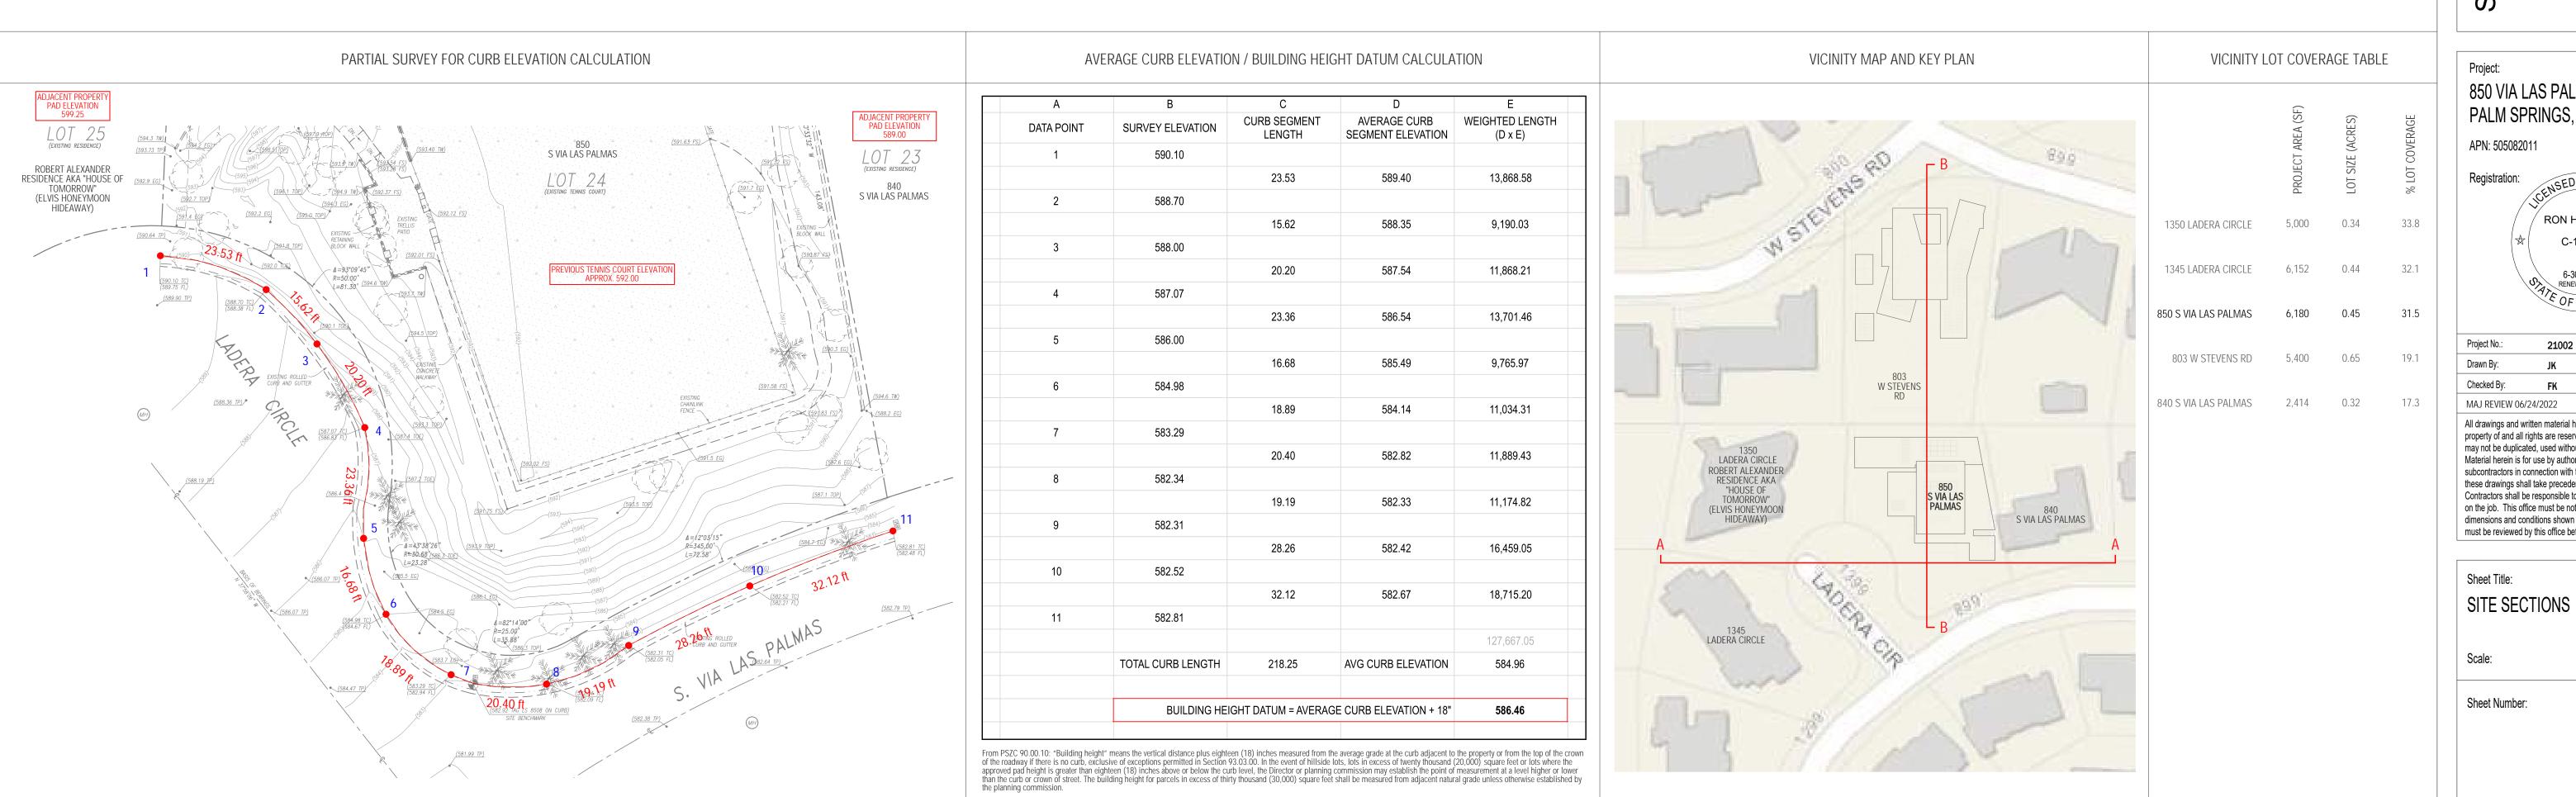

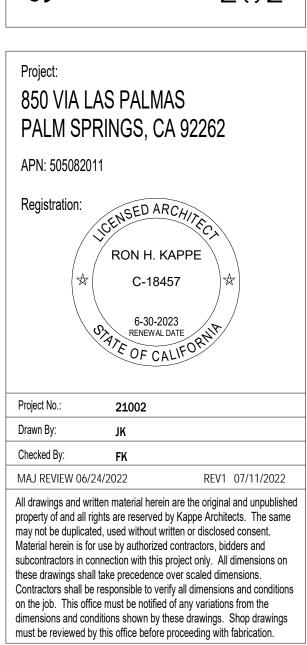

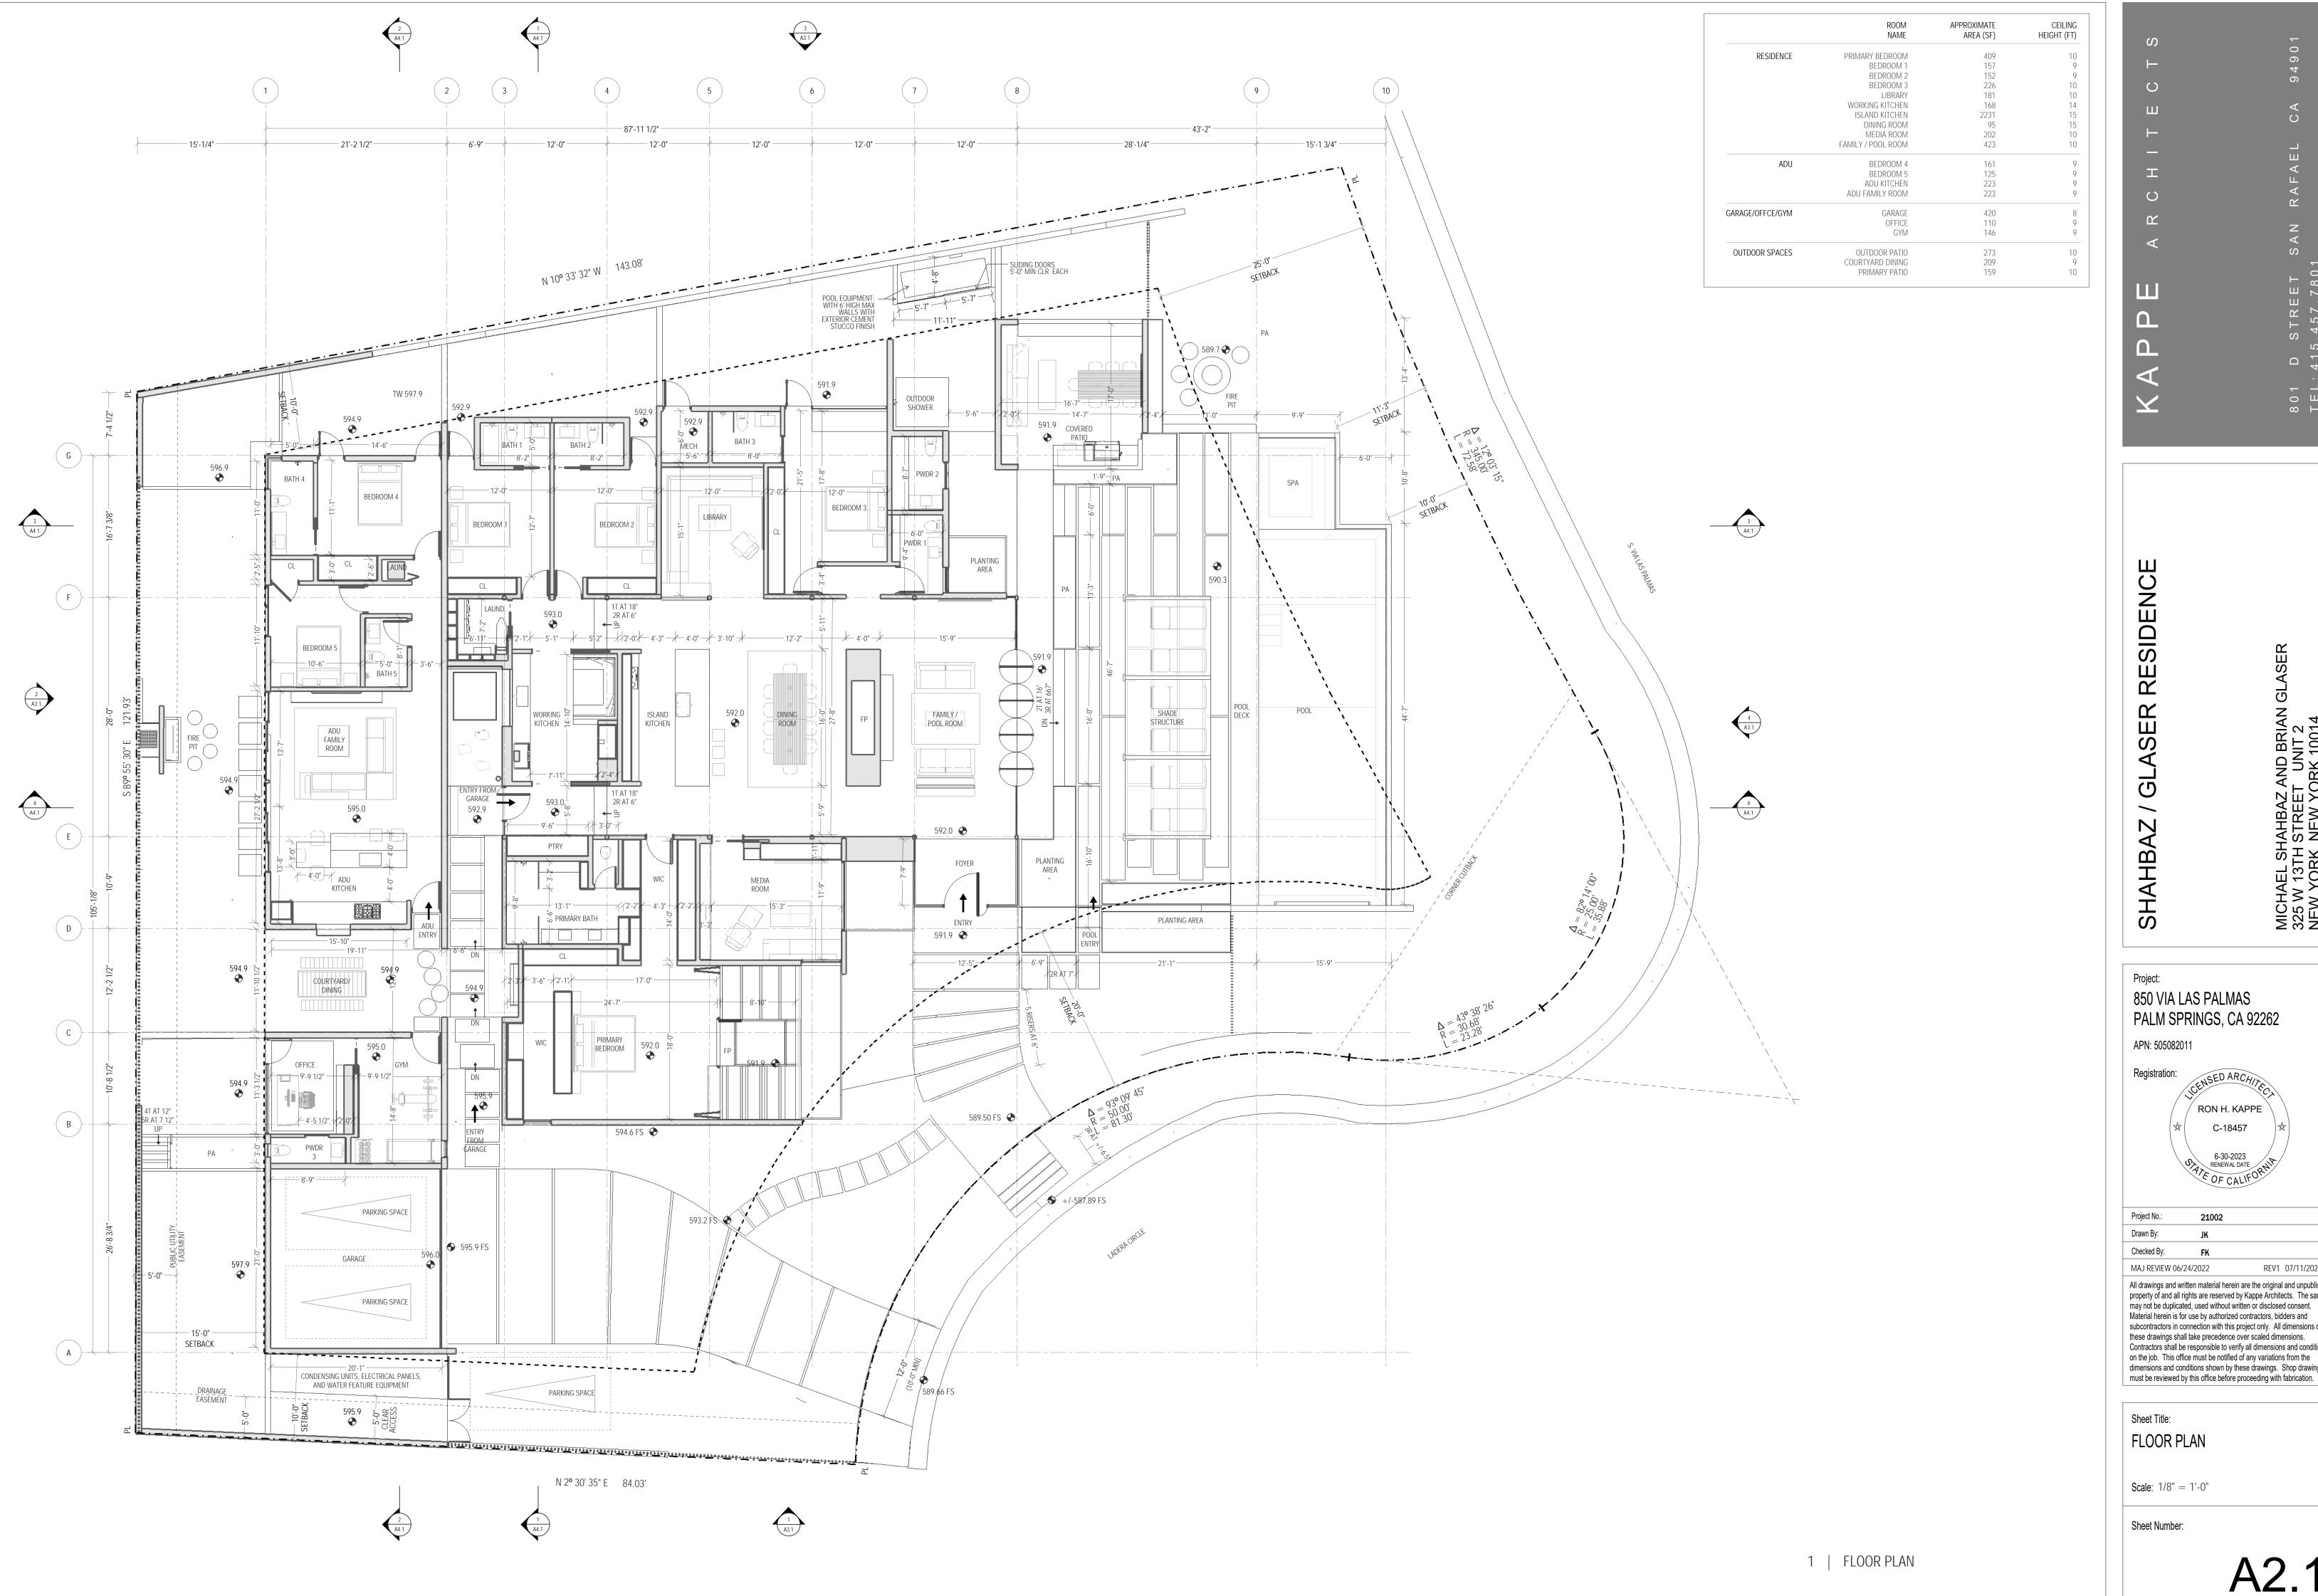

RESIDENCE

Project: 850 VIA LAS PALMAS PALM SPRINGS, CA 92262

APN: 505082011




Project No.: 21002 Drawn By: Checked By:

MAJ REVIEW 06/24/2022 REV1 07/11/2022

All drawings and written material herein are the original and unpublished property of and all rights are reserved by Kappe Architects. The same may not be duplicated, used without written or disclosed consent. Material herein is for use by authorized contractors, bidders and subcontractors in connection with this project only. All dimensions on these drawings shall take precedence over scaled dimensions. Contractors shall be responsible to verify all dimensions and conditions on the job. This office must be notified of any variations from the dimensions and conditions shown by these drawings. Shop drawings

Sheet Title: FLOOR PLAN

Scale: 1/8" = 1'-0"

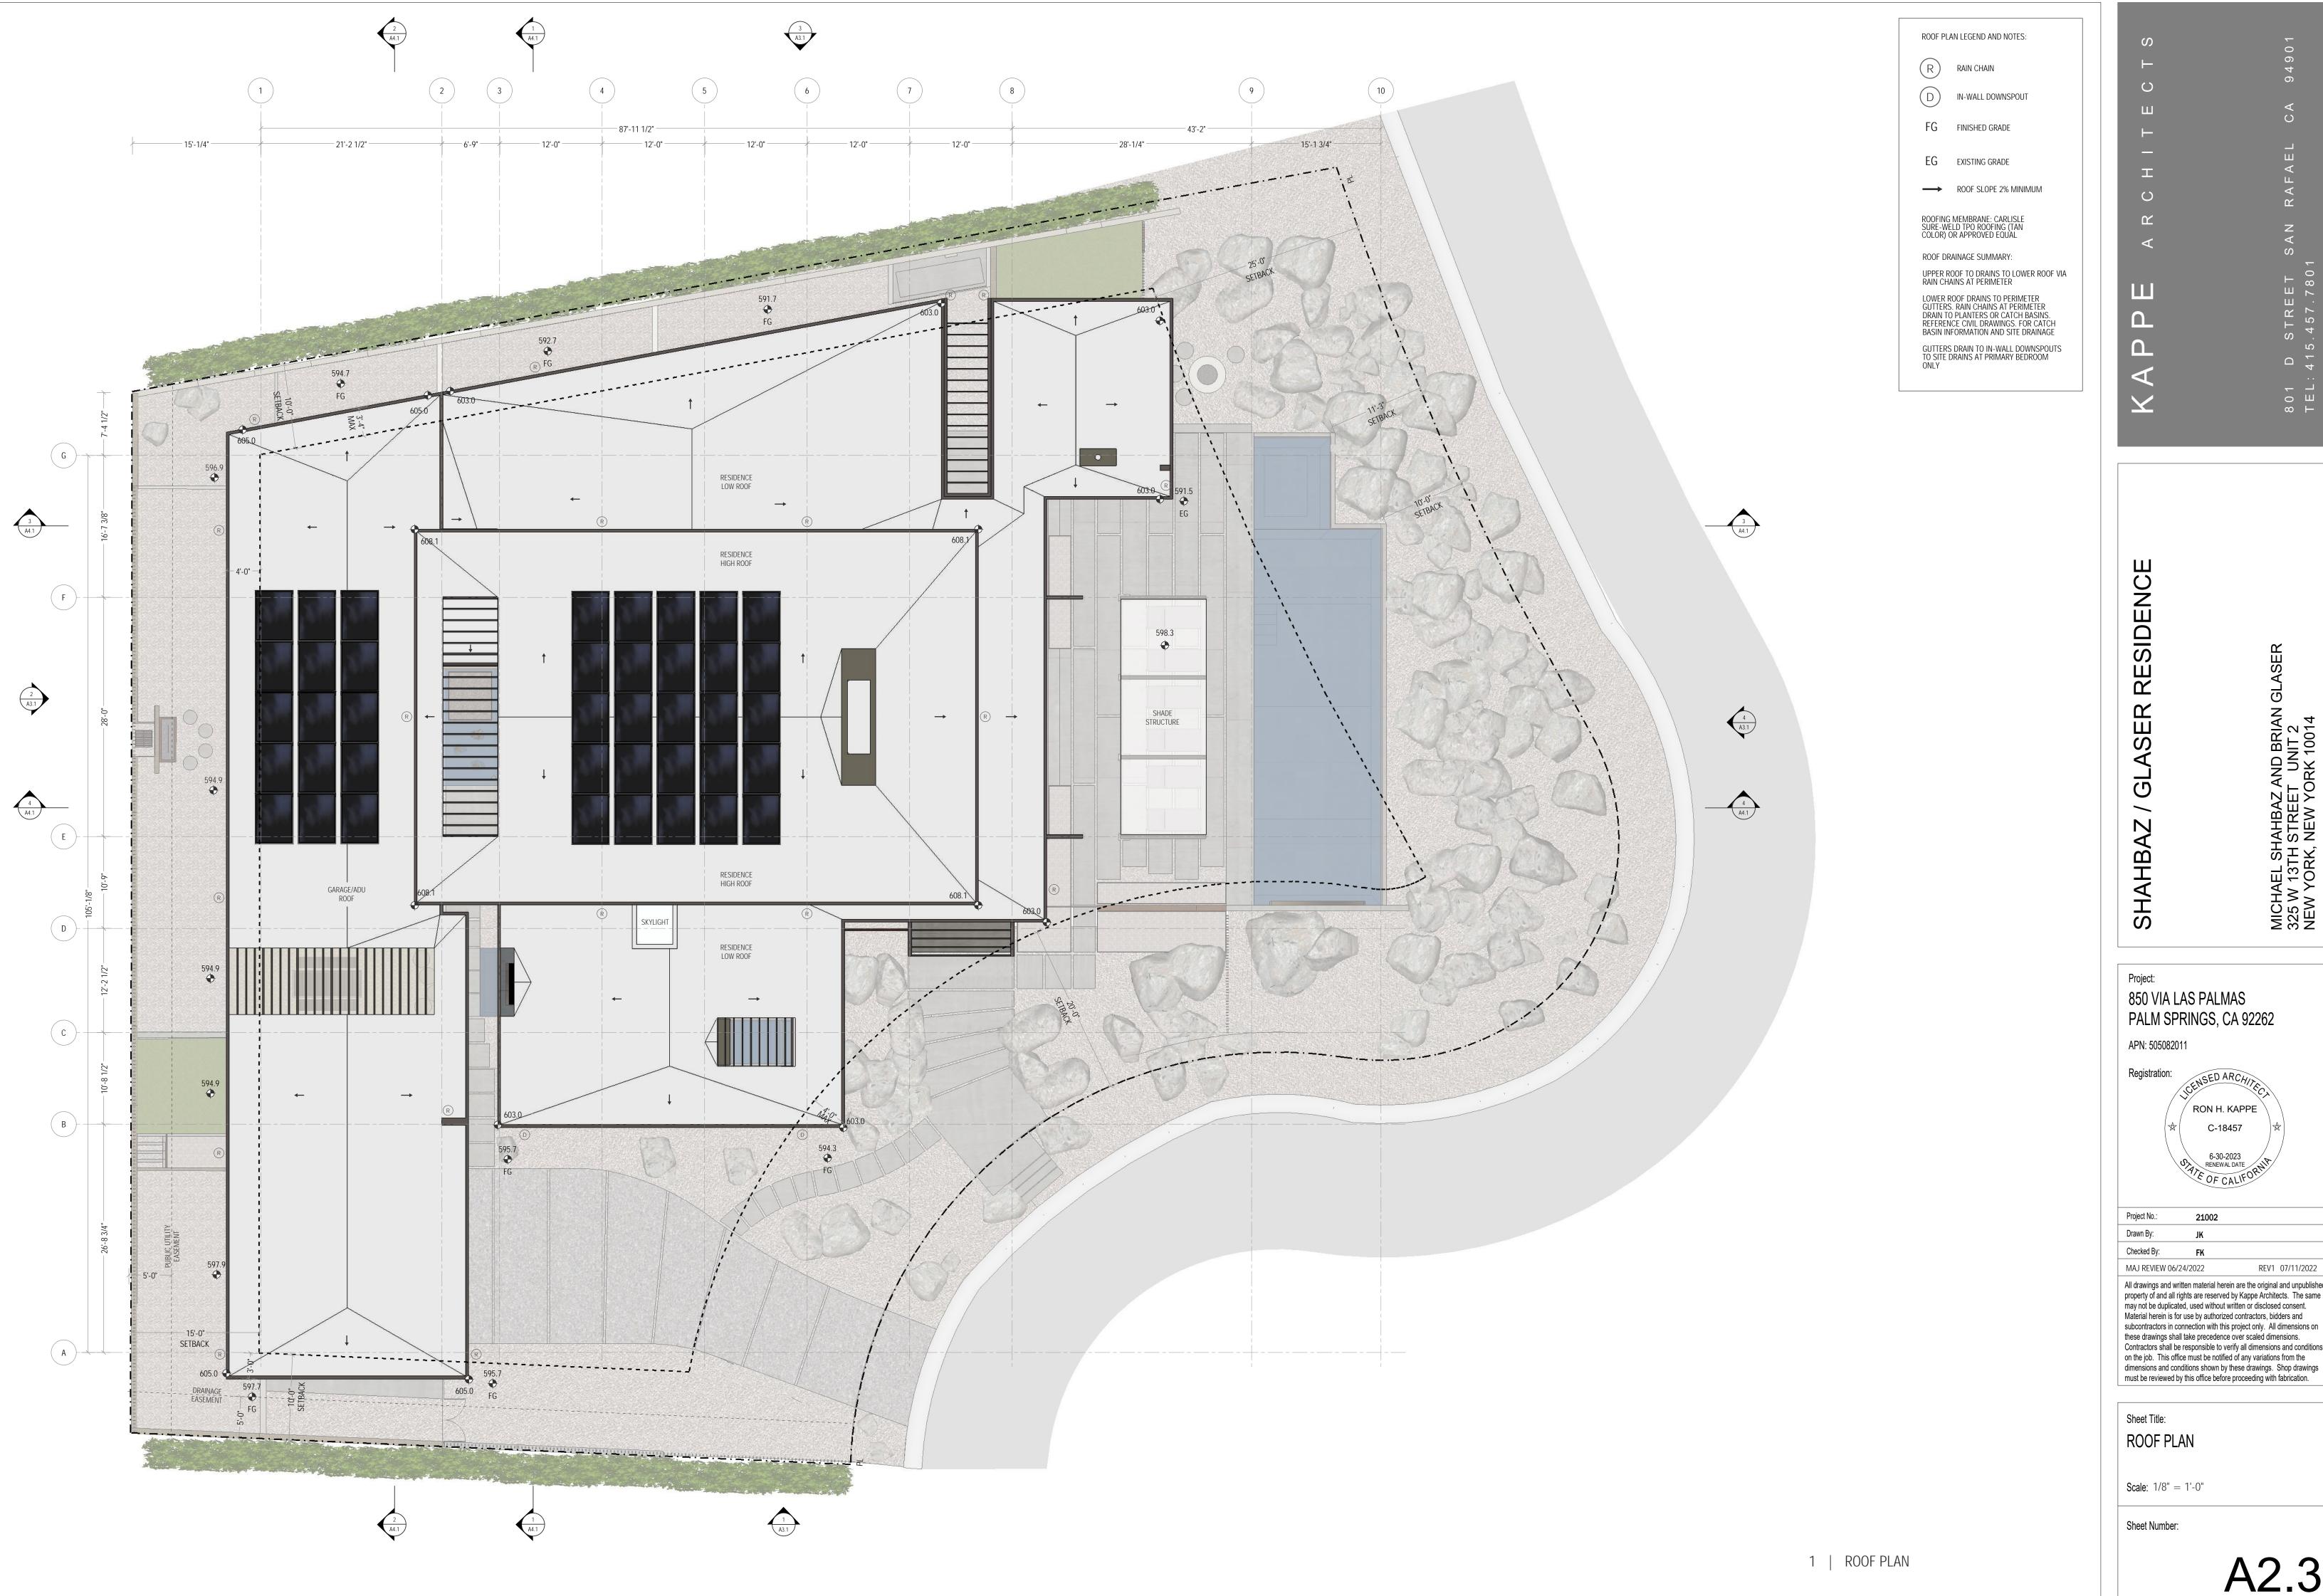

RESIDENCE

Project: 850 VIA LAS PALMAS PALM SPRINGS, CA 92262

APN: 505082011

Registration: RON H. KAPPE

Project No.: 21002 Drawn By: Checked By:


MAJ REVIEW 06/24/2022

All drawings and written material herein are the original and unpublished property of and all rights are reserved by Kappe Architects. The same may not be duplicated, used without written or disclosed consent. Material herein is for use by authorized contractors, bidders and subcontractors in connection with this project only. All dimensions on these drawings shall take precedence over scaled dimensions. Contractors shall be responsible to verify all dimensions and conditions on the job. This office must be notified of any variations from the

REV1 07/11/2022

Sheet Title: **ROOF PLAN** 

Scale: 1/8" = 1'-0"

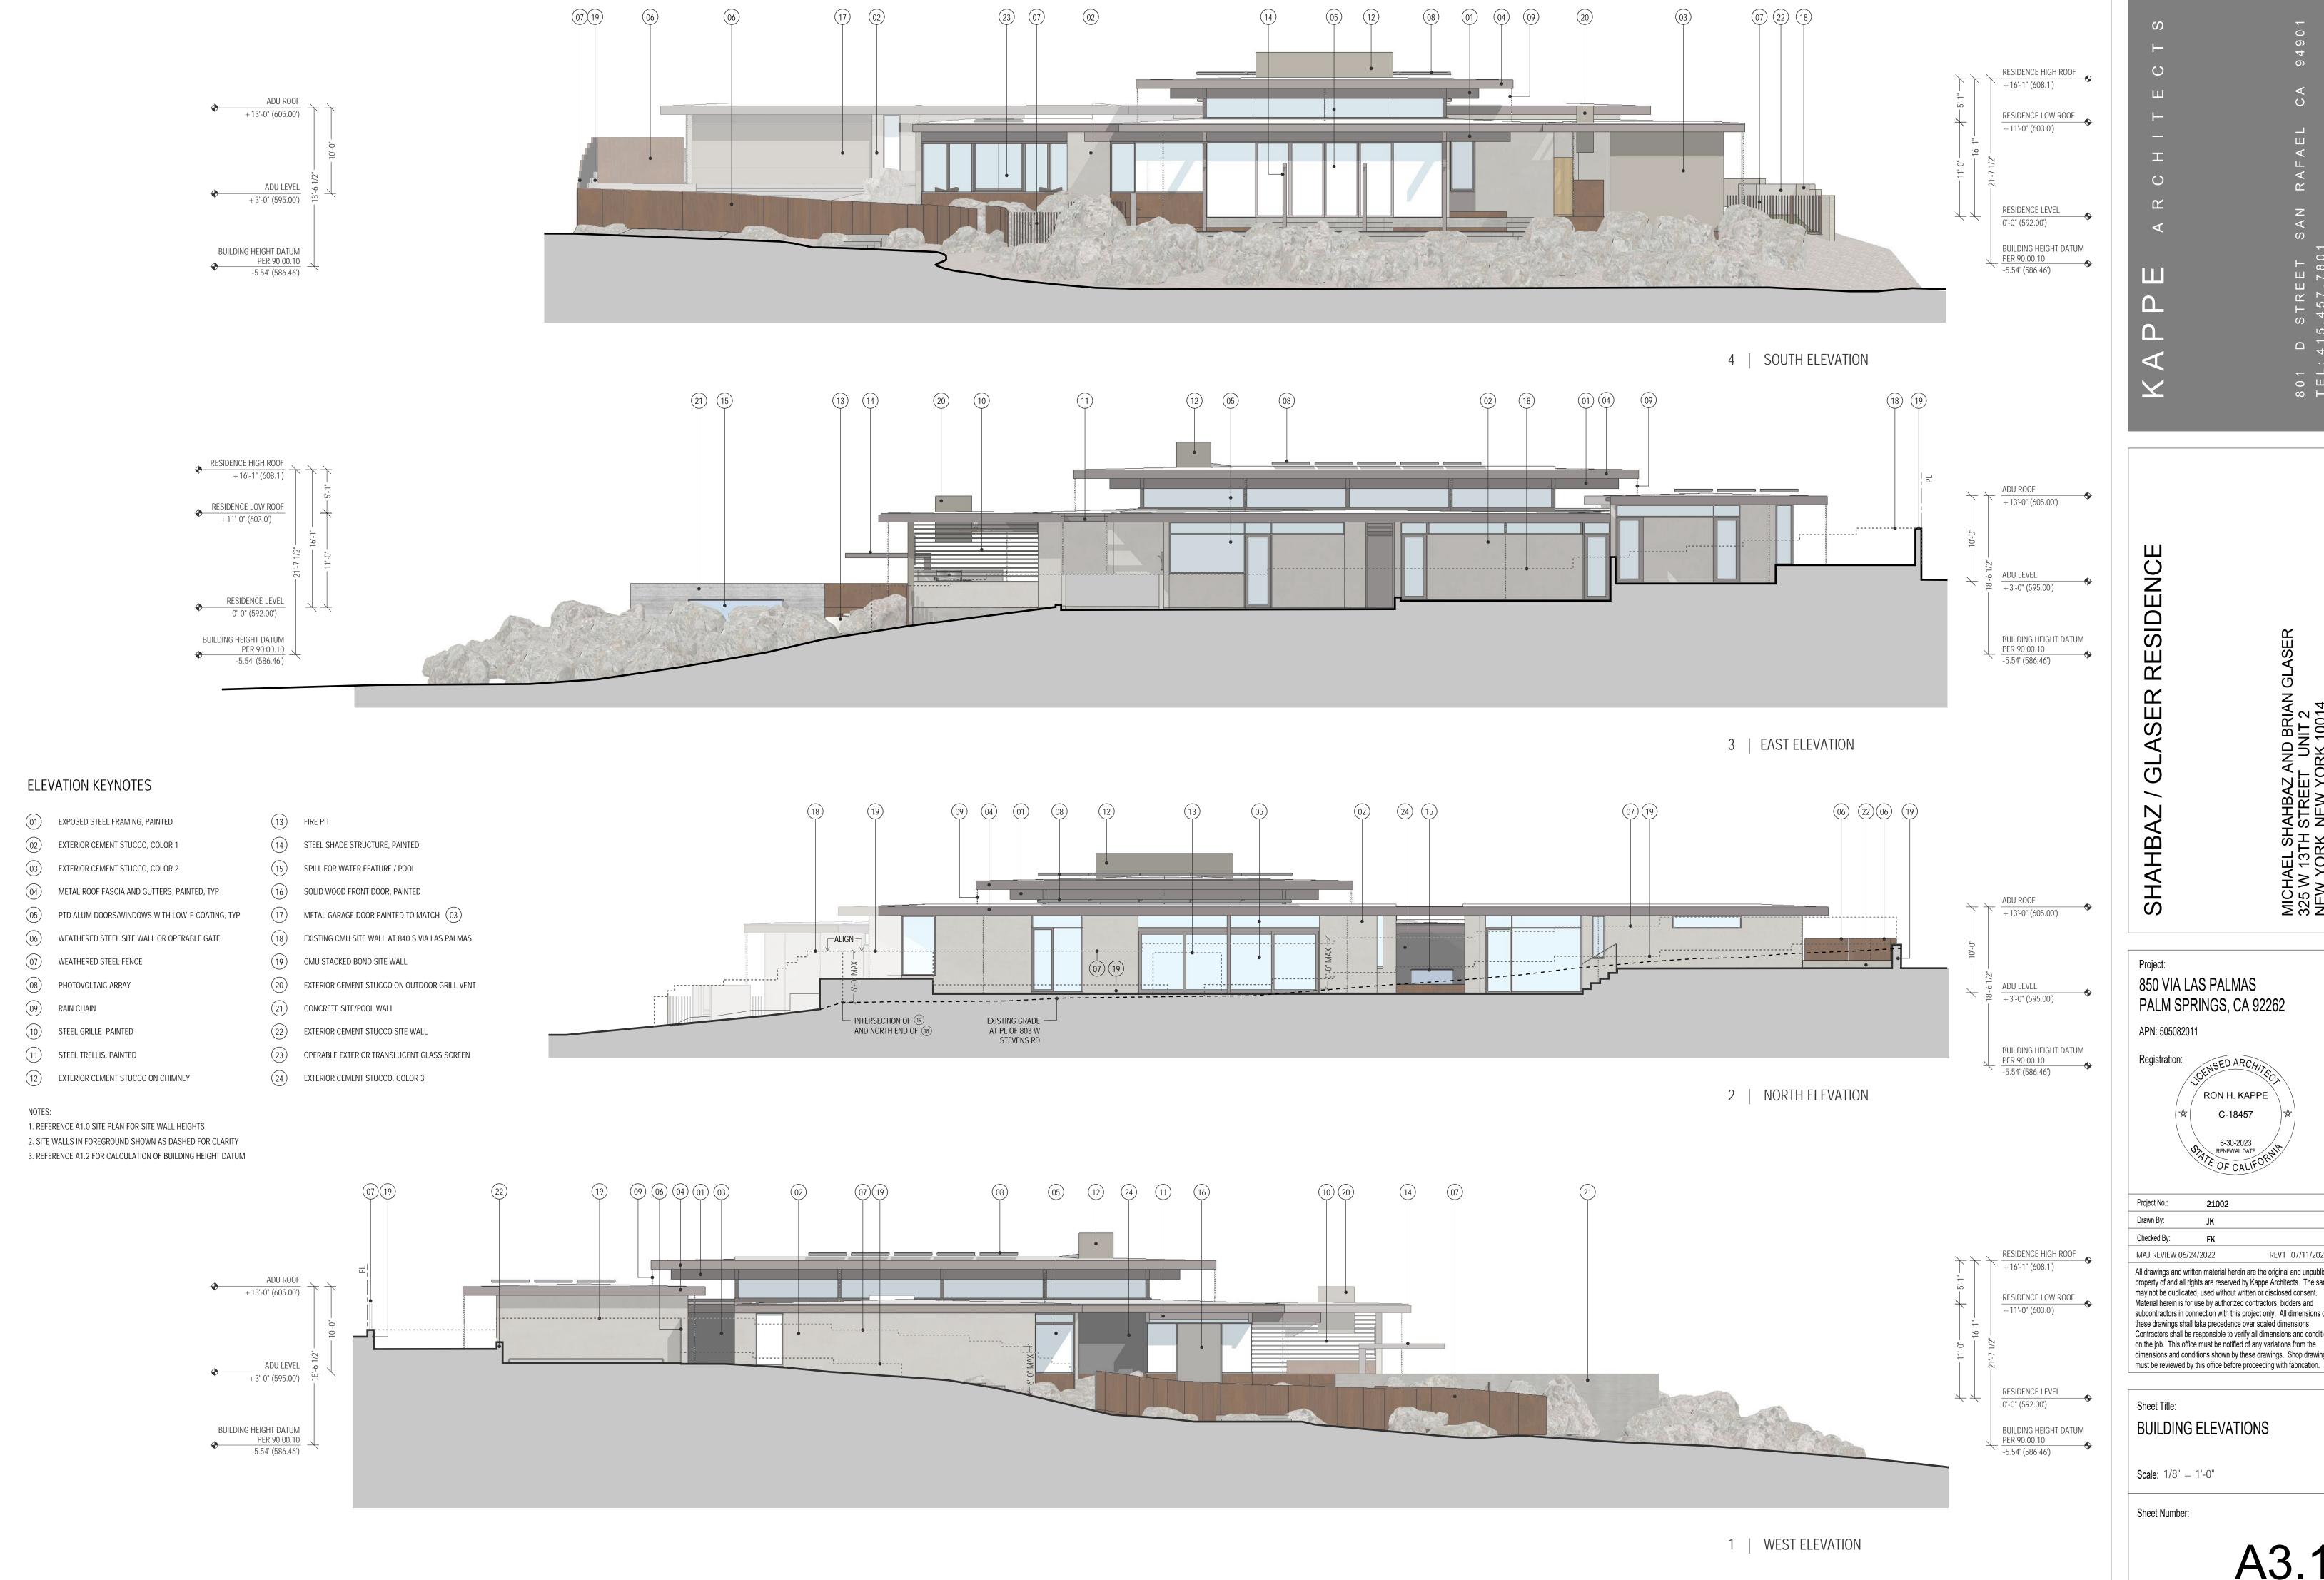


801 D STREET TEL:415.457.780

RON H. KAPPE C-18457 6-30-2023 RENEWAL DATE OF CALIFO

REV1 07/11/2022

All drawings and written material herein are the original and unpublished property of and all rights are reserved by Kappe Architects. The same may not be duplicated, used without written or disclosed consent. Material herein is for use by authorized contractors, bidders and subcontractors in connection with this project only. All dimensions on these drawings shall take precedence over scaled dimensions. Contractors shall be responsible to verify all dimensions and conditions on the job. This office must be notified of any variations from the dimensions and conditions shown by these drawings. Shop drawings

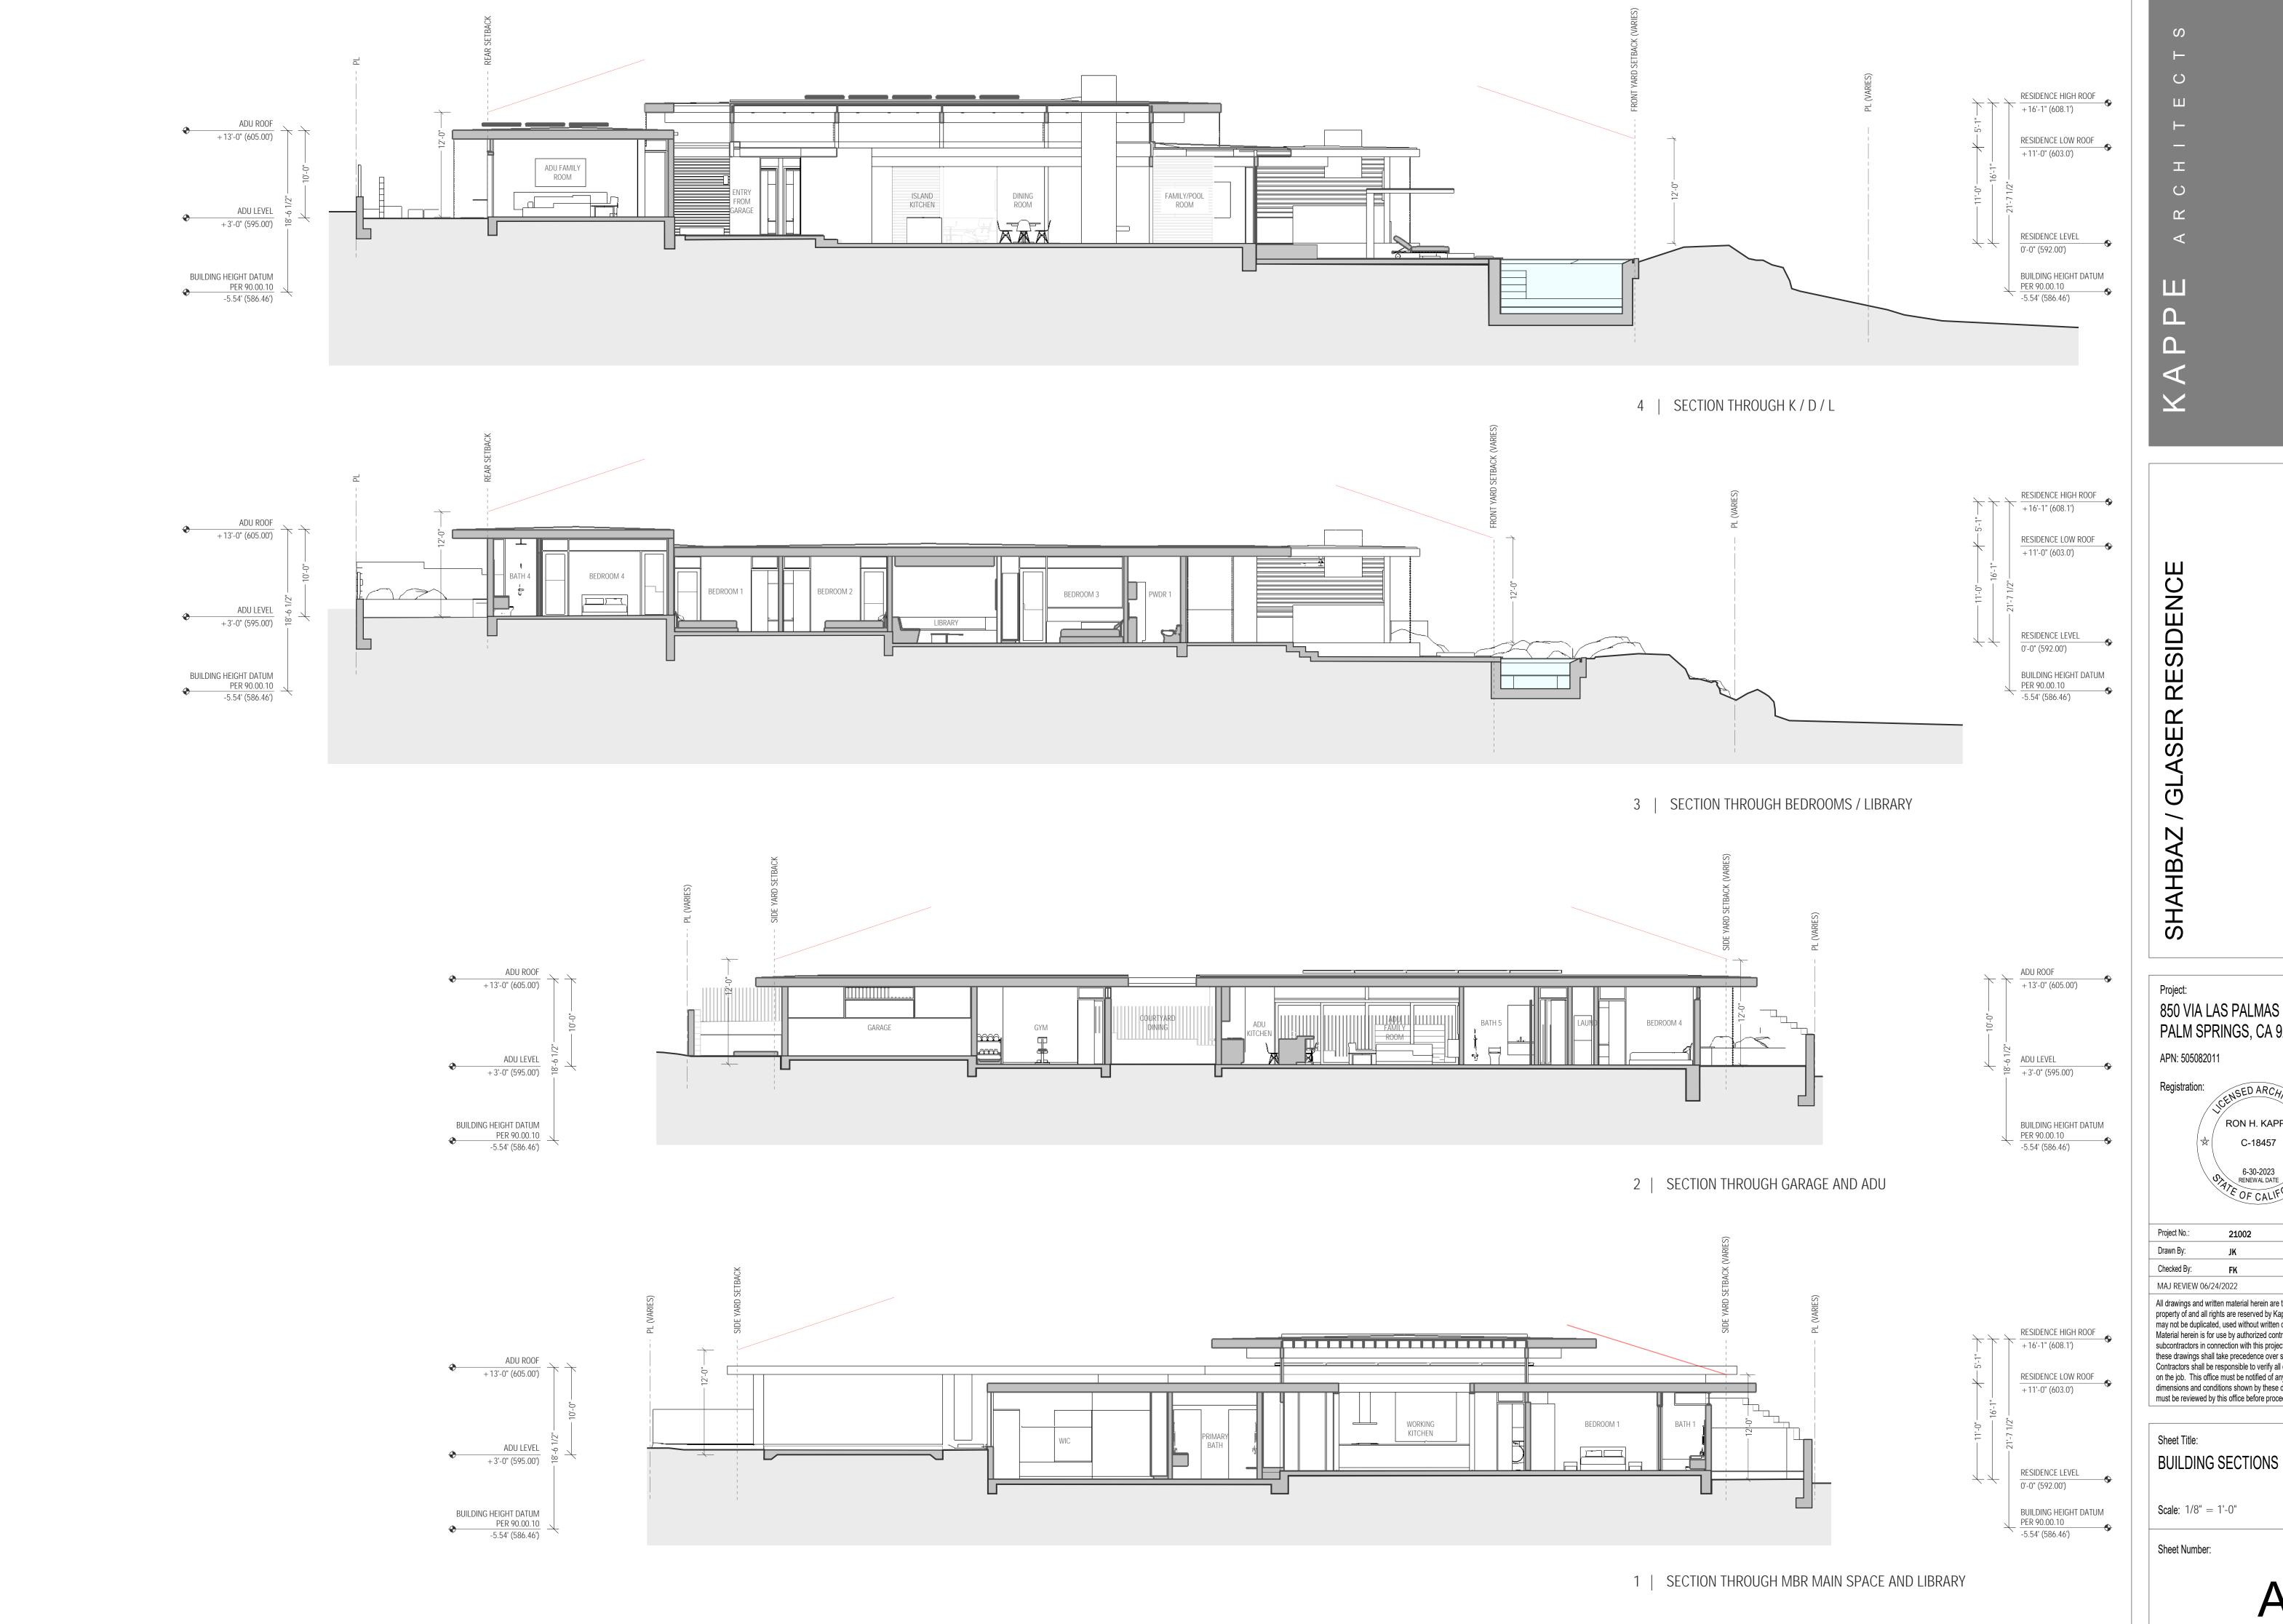

801 D STREET TEL:415.457.780

850 VIA LAS PALMAS PALM SPRINGS, CA 92262

APN: 505082011

RON H. KAPPE C-18457 6-30-2023
RENEWAL DATE
OF CALIFORN

21002

MAJ REVIEW 06/24/2022 REV1 07/11/2022

All drawings and written material herein are the original and unpublished property of and all rights are reserved by Kappe Architects. The same may not be duplicated, used without written or disclosed consent. Material herein is for use by authorized contractors, bidders and subcontractors in connection with this project only. All dimensions on these drawings shall take precedence over scaled dimensions. Contractors shall be responsible to verify all dimensions and conditions on the job. This office must be notified of any variations from the dimensions and conditions shown by these drawings. Shop drawings must be reviewed by this office before proceeding with fabrication.

Scale: 1/8" = 1'-0"

GRAVEL SITE GROUNDCOVER

TPO MEMBRANE ROOFING MEMBRANE





FABRIC OR PERFORATED METAL POOL DECK SUNSHADE



PAINTED TUBE STEEL EXPOSED STRUCTURE AND TRELLIS MEMBERS




PAINTED METAL FASCIA ROOF EAVES AND GUTTERS



SMOOTH TROWELED PLASTER ENTRY ACCENT WALL




SMOOTH TROWELED PLASTER
SELECTED ACCENT WALLS (GARAGE DOOR TO MATCH COLOR)

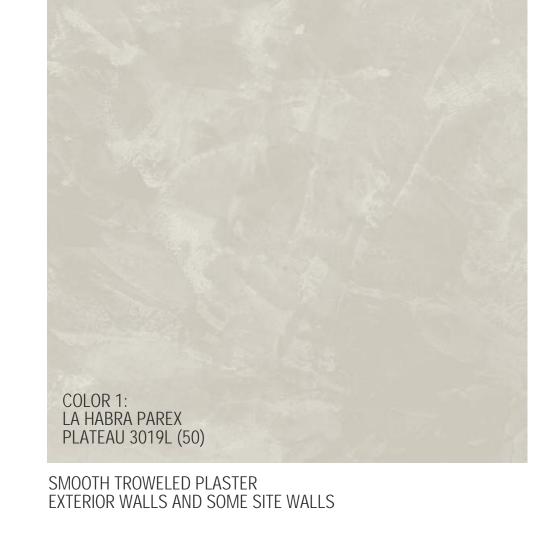



CLEAR INSULATED GLASS UNITS WITH LOW-E COATING EXTERIOR WALL

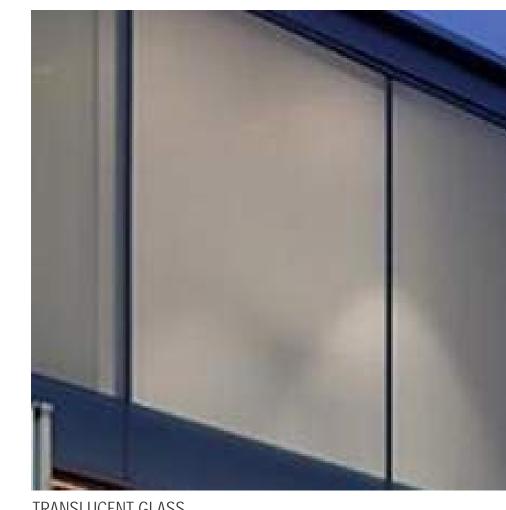

TRANSLUCENT GLASS EXTERIOR WALL






CAST-IN-PLACE CONCRETE WITH EXPOSED AGGREGATE DRIVEWAY



CAST-IN-PLACE CONCRETE EXTERIOR PAVERS; INTERIOR FLOOR FINISH

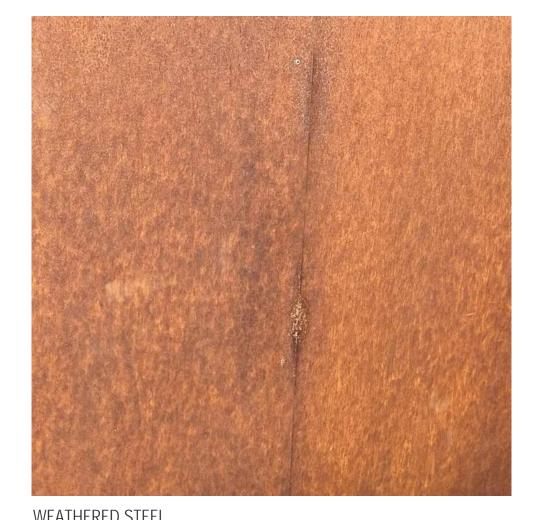

WEATHERED STEEL PERIMETER SITE FENCING AND GATES, PLANTERS



PAINTED BRONZE ANODIZED OR CUSTOM COLOR ALUMINUM WINDOW FRAMES AND TRELLIS MEMBERS



850 VIA LAS PALMAS PALM SPRINGS, CA 92262 APN: 505082011

RESIDENCE

/GLASER

Ŋ

Project No.: 21002 Checked By:

MAJ REVIEW 06/24/2022 REV1 07/11/2022 All drawings and written material herein are the original and unpublished property of and all rights are reserved by Kappe Architects. The same may not be duplicated, used without written or disclosed consent. Material herein is for use by authorized contractors, bidders and subcontractors in connection with this project only. All dimensions on these drawings shall take precedence over scaled dimensions. Contractors shall be responsible to verify all dimensions and conditions on the job. This office must be notified of any variations from the dimensions and conditions shown by these drawings. Shop drawings must be reviewed by this office before proceeding with fabrication.

Sheet Title: EXTERIOR COLORS AND MATERIALS

RESIDENCE

 Drawn By:
 JK

 Checked By:
 FK

 MAJ REVIEW 06/24/2022
 REV1 07/11/2022


All drawings and written material herein are the original and unpublished property of and all rights are reserved by Kappe Architects. The same may not be duplicated, used without written or disclosed consent. Material herein is for use by authorized contractors, bidders and subcontractors in connection with this project only. All dimensions on these drawings shall take precedence over scaled dimensions. Contractors shall be responsible to verify all dimensions and conditions on the job. This office must be notified of any variations from the dimensions and conditions shown by these drawings. Shop drawings must be reviewed by this office before proceeding with fabrication.

Sheet Title:
SITE PHOTOS

cale:

Sheet Number:


A8.

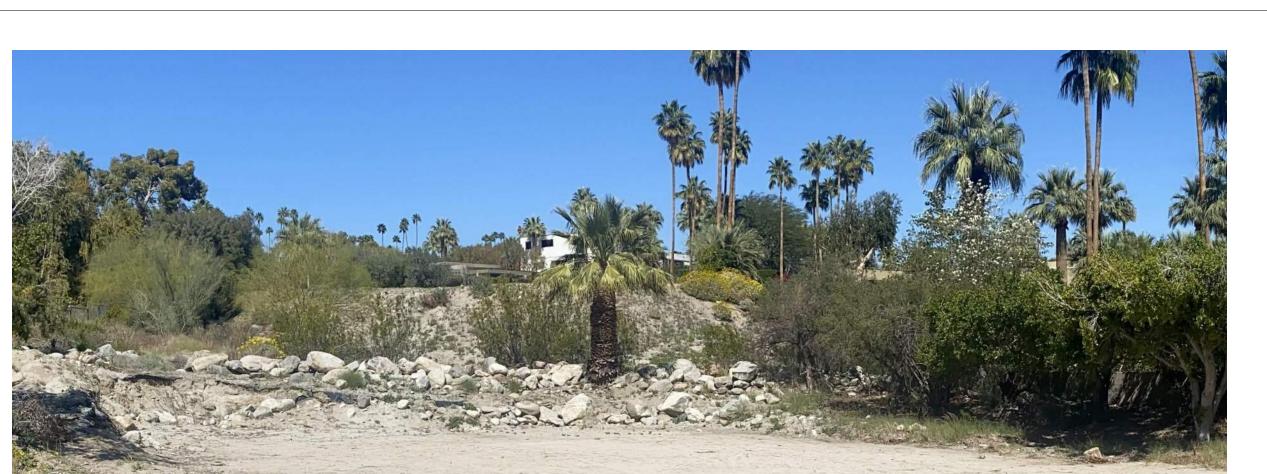

VIEW 7 - NORTH



FRIAL VIEW LOOKING NORTH

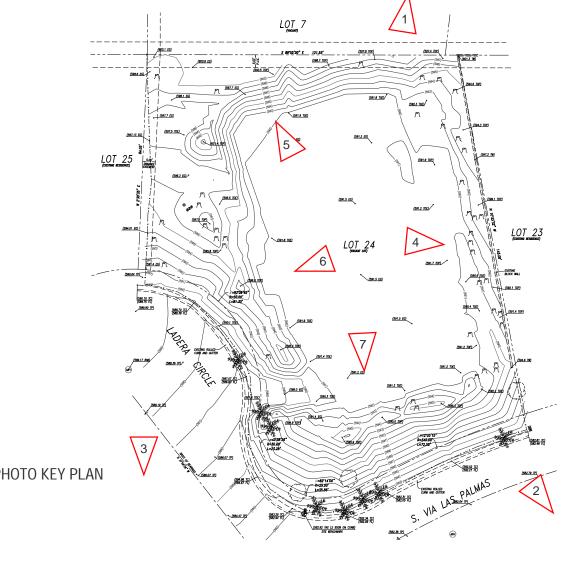


VIEW 6 - EAST



VIEW 1 - VIEW ABOVE SITE FROM NORTH




VIEW 5 - SOUTH

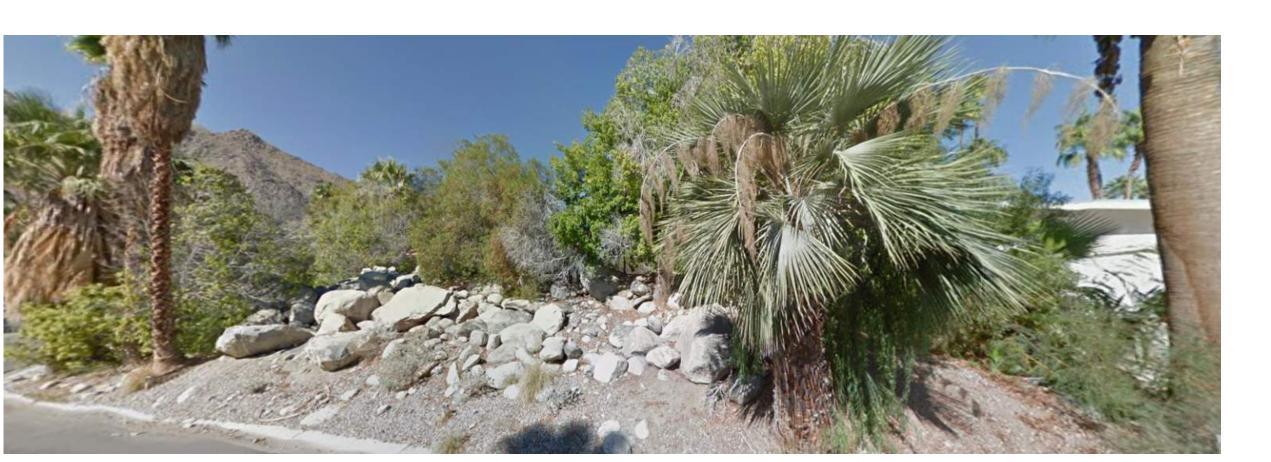

VIEW 2 - STREET VIEW ON VIA LAS PALMAS LOOKING NORTHWEST




VIEW 4 - WEST

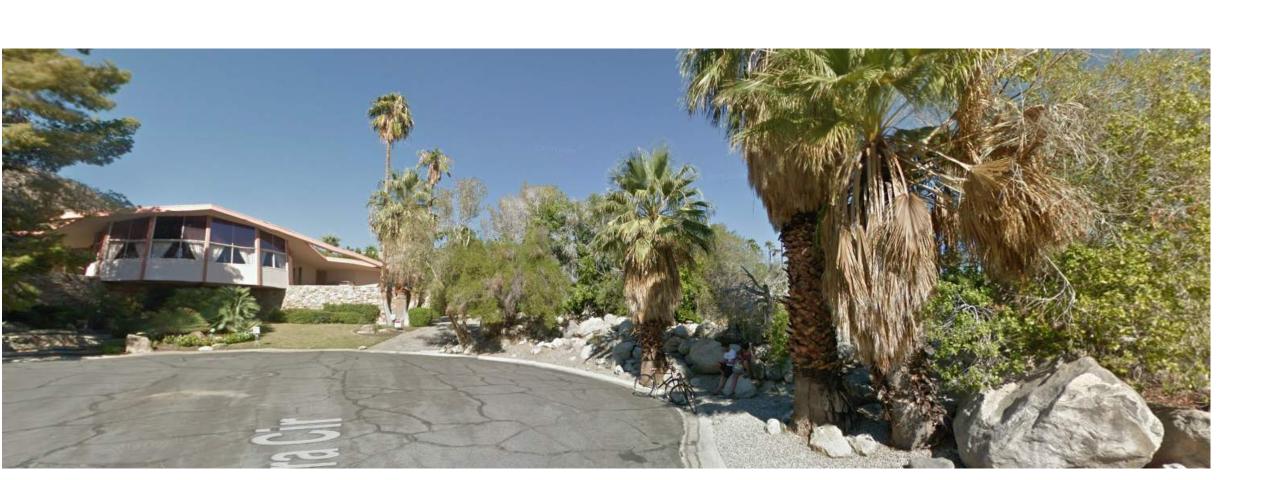

VIEW 3 - STREET VIEW ON LADERA CIRCLE LOOKING NORTH

APN: 505082011

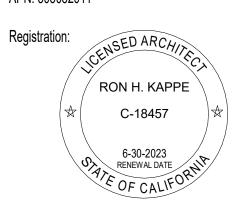

MAJ REVIEW 06/24/2022

REV1 07/11/2022

All drawings and written material herein are the original and unpublished property of and all rights are reserved by Kappe Architects. The same may not be duplicated, used without written or disclosed consent. Material herein is for use by authorized contractors, bidders and subcontractors in connection with this project only. All dimensions on these drawings shall take precedence over scaled dimensions. Contractors shall be responsible to verify all dimensions and conditions on the job. This office must be notified of any variations from the dimensions and conditions shown by these drawings. Shop drawings must be reviewed by this office before proceeding with fabrication.

Sheet Title:

PERSPECTIVE VIEWS

Sheet Number:

A9.0



4 | PANORAMIC VIEW - PHOTO MATCHING STUDY WITH ROBERT ALEXANDER RESIDENCE




2 | EXTERIOR PERSPECTIVE VIEW






3 | EXTERIOR PERSPECTIVE VIEW

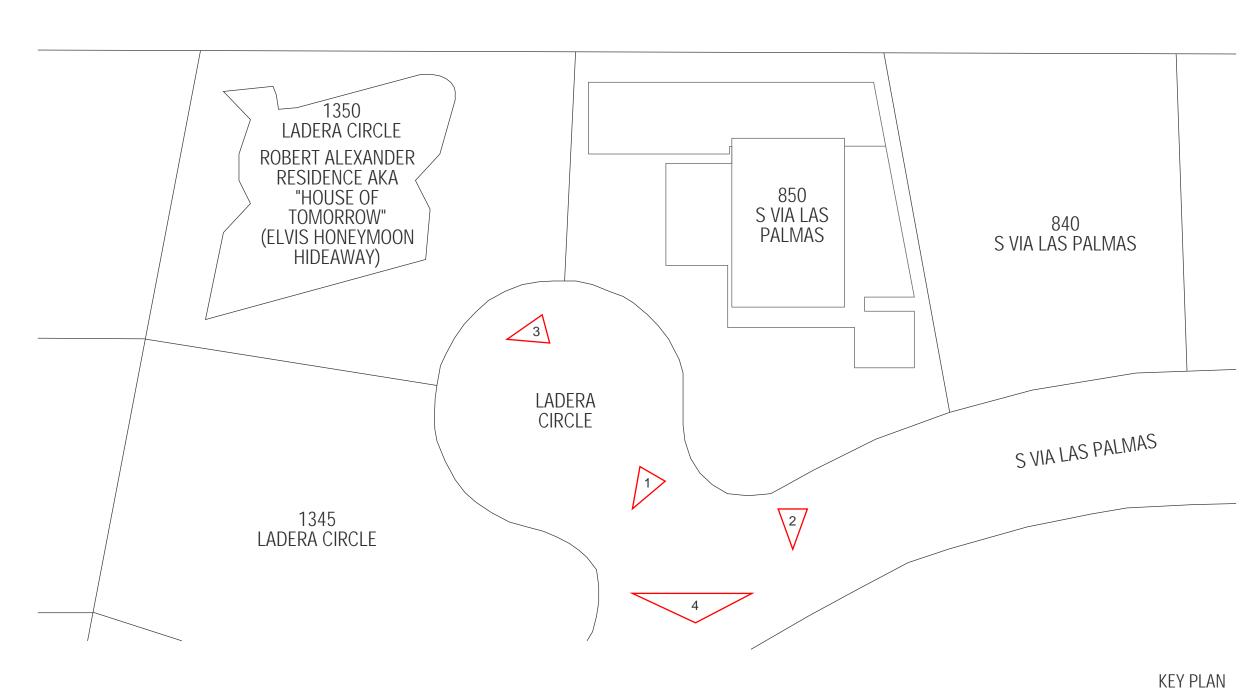


# Preliminary Grading Plan

850 S Las Palmas

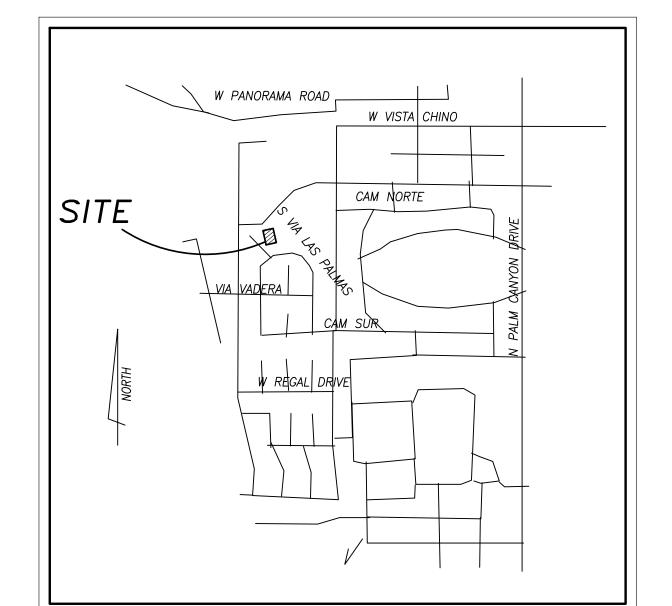

VICINITY MAP NOT TO SCALE

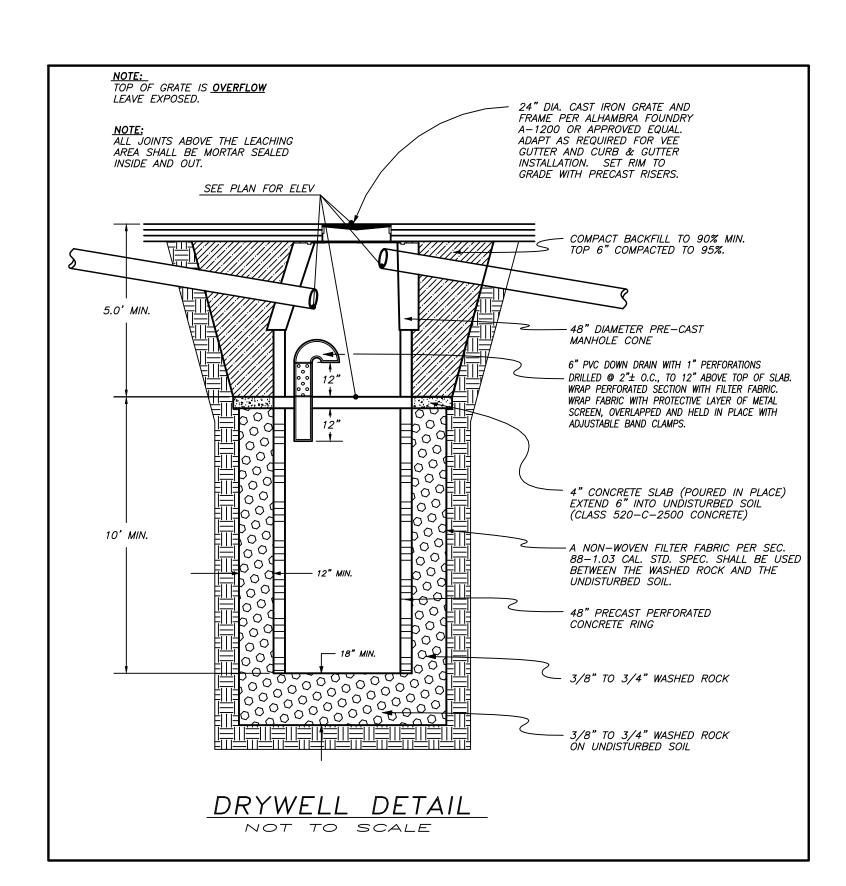

OWNER: MICHAEL SHAHBAZ 325 W 13TH STREET, UNIT 2 NEW YORK, NY 10014 (408) 425-6865 michael.shahbaz@gmail.com

**SITE ADDRESS:** 850 S LAS PALMAS, PALM SPRINGS, CA. 92262 **LEGAL DESCRIPTION:** Lot 82, Vista Las Palmas No.1, Per

BASIS OF BEARINGS:

MB 32/45

CENTERLINE OF LADERA CIRCLE AS N 37°58'06" W, PER MB 32/45. BENCHMARK:

CITY OF PALM SPRINGS #10-2 CHISELED BOX AT N.N.W. B.C.R., VIA MONTE VISTA AND LAS PALMAS ELEVATION = (562.813')

TAG LS 8508 ON CURB IN FRONT OF LOT 24 ON SOUTHERN CORNER.

# (ELEVATION = 582.92')SITE BENCHMARK:

 $\bigoplus$  INDICATES THE BENCHMARK AT THE SITE WHICH THE ENGINEER OF RECORD SHALL USE TO CERTIFY PAD ELEVATION AND FINAL GRADING CERTIFICATION. THE CONTRACTOR SHALL NOTIFY THE ENGINEER OF RECORD OF ANY DISCREPANCIES BETWEEN THIS BENCHMARK AND THE BENCHMARK USED BY THE CONTRACTOR PRIOR TO ANY GRADING.

**SOURCE OF TOPOGRAPHY:** THE TOPOGRAPHY SHOWN HEREON WAS OBTAINED BY A

FIELD SURVEY BY FEIRO ENGINEERING, INC ON 5-31-2021 AND SURVEYED AGAIN ON 4-6-2022

QUANTITIES ESTIMATE SHOWN IS FOR PERMIT PURPOSES ONLY. IT IS THE CONTRACTOR'S RESPONSIBILITY TO DETERMINE THE QUANTITIES FOR HIS BID AND PAYMENT PURPOSES.

QUANTITIES ESTIMATE DOES NOT INCLUDE CLEARING. SHRINKAGE, SUBSIDENCE, ANY OTHER LOSSES, OR ANY GRADING OR EXCAVATION COVERED UNDER A SEPARATE

## EARTHWORK QUANTITIES ESTIMATE: CUT = 350 CU YDS

FILL = 150 CU YDSNET = 200 CU YDS [EXPORT]

EARTHWORK QUANTITIES DO NOT INCLUDE LOSSES DUE TO SITE DEMOLITION, POOL, RETENTION, OR WALL FOOTINGS.

# PROJECT & PROPERTY INFORMATION

OCCUPANCY GROUP: R-3/U TYPE OF CONSTRUCTION: TYPE V-B

SCOPE OF WORK: A NEW RETAINING WALL ALONG THE SOUTHERN PROPERTY LINE OF LOT 26 (SUBJECT PROPERTY)

APPLICABLE CODES: 2019 CRC 2019 CPC 2019 CMC 2019 CEC

2019 CALIFORNIA ENERGY CODE AND INCLUDING ALL LOCAL ORDIANCE AND STATE LAW AS APPLICABLE AS IT RELATES TO THIS SCOPE OF WORK ONLY.

UTILITIES SHOWN REFLECT AVAILABLE PUBLIC RECORDS. IT SHALL BE THE RESPONSIBILITY OF THE CONTRACTOR TO VERIFY AND PROTECT ALL UTILITIES IN THE CONSTRUCTION AREA, WHETHER SHOWN OR NOT HEREON, AND TO NOTIFY UNDERGROUND SERVICE ALERT AT 1-800-422-4133, 48 HOURS IN ADVANCE.

# NOTE TO OWNER AND CONTRACTOR:

IT IS THE OWNER'S RESPONSIBILITY TO SCHEDULE REGULAR MAINTENANCE OF THE DRAINAGE SYSTEM, INCLUDING BUT NOT LIMITED TO AREA DRAINS, DRAIN LINES, DRYWELLS AND BUBBLER

CONTRACTOR SHALL RECOMMEND MAINTENANCE SCHEDULE TO OWNER BASED UPON INSTALLED EQUIPMENT AND AS-BUILT CONDITIONS. ROOF DRAINS.


ENGINEER-OF-RECORD SHALL BE CONSULTED PRIOR TO ADDING ADDITIONAL DRAINAGE (ROOF DRAINS, POT DRAINS, ETC) INTO THE SYSTEM SHOWN HEREON TO ENSURE ADEQUATE PIPE

SOUTHERN CALIFORNIA EDISON DESERT WATER AGENCY SEWER CITY OF PALM SPRINGS CABLE TV TIME WARNER CABLE VERIZON TELEPHONE COMPANY TELEPHONE SOUTHERN CALIFORNIA GAS CO. WHITEWATER MUTUAL WATER CO. C/O DESERT WATER AGENCY

DEMOLITION PERMIT

(760) 202-4250 ATTN: AMBER WRIGHT (760) 323—4971×146 ATTN: DEBBIE RANDALL (760) 323-8166x2 ATTN: GARY GRAY (760) 674–5952 ATTN: DALE SCRIVNER ATTN: LARRY MOORE (760) 778–3603 (800) 427-2200 (760) 323-4971x146 ATTN: DEBBIE RANDALL

**REQUIRED PERMITS:** 

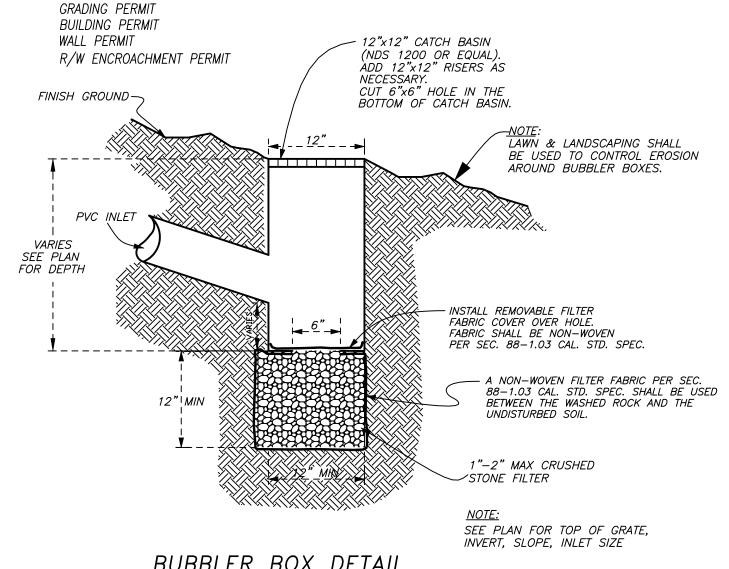

BUBBLER BOX DETAIL SCALE: 1" = 1'INDICATED ON PLAN:

GRATE SIZE SHALL BE DETERMINED FROM THESE PLANS (4" UNLESS OTHERWISE NOTED). GRATE STYLE, TYPE, COLOR AND/OR FINISH SHALL BE DETERMINED BY THE OWNER OR LANDSCAPE ARCHITECT. √9" GRATES USE NDS 9"X9" LOW PROFILE ADAPTER, 12" GRATES USE NDS 12"X12" LOW PROFILE ADAPTER, OR EQUAL. NDS 3"&4" UNIVERSAL OUTLET, OR GRADE PER PLAN 4" SDR-35 PVC \_ OR SOLID WALL HDPE **VARIES** 12" MINIMUM 4"x45" BEND COVER (1/8 BEND) PIPE CONTINUES SEWER BRANCH WYE WHEN NOT END OF LINE. (MAIN SIZE x 4") DIR. OF FLOW AT 1% MIN. - CAP/PLUG WHEN END OF LINE. SDR-35 PVC (4", 6" OR 8" - SIZE PER PLAN)

DRAIN DETAIL SCALE: 1"=1" INDICATED ON PLAN: CITY OF PALM SPRINGS —— GRADING PLAN GENERAL NOTES:

1. THE WORK SHALL BE DONE IN ACCORDANCE WITH THE STANDARD DRAWINGS OF THE CITY OF PALM SPRINGS AND THE

STANDARD SPECIFICATIONS FOR PUBLIC WORKS CONSTRUCTION, 2016 EDITION. 2. THE CONTRACTOR SHALL BE RESPONSIBLE FOR PROVIDING AN EFFECTIVE MEANS OF DUST CONTROL WHICH SHALL INCLUDE PROVISIONS FOR ADEQUATE WATERING DURING THE GRADING PROCESS AND PROVISIONS FOR CONTINUANCE OF DUST CONTROL UNTIL THE GRADED SURFACE PRESENTS SUFFICIENT COVER AGAINST WIND OR WATER EROSION, SO THAT SPECIAL DUST CONTROL MEASURES ARE NO LONGER NECESSARY.

3. NOTHING IN THESE PLANS SHALL RELIEVE THE CONTRACTOR FROM OBTAINING PERMITS AS REQUIRED BY CHAPTER 14.16 OF THE CITY OF PALM SPRINGS MUNICIPAL CODE.

4. THE CONTRACTOR SHALL SET AN APPOINTMENT FOR INSPECTION WITH THE ENGINEERING INSPECTOR A MINIMUM OF 24 HOURS PRIOR TO THE DATE OF INSPECTION.

5. ALL GRADING SHALL COMPLY WITH SECTION 1804 AND APPENDIX J OF THE 2019 CALIFORNIA BUILDING CODE. 6. THE LOCATION OF EXISTING UNDERGROUND UTILITIES ARE TO BE SHOWN IN A SCHEMATIC MANNER ONLY. SUBJECT TO THE PROVISIONS OF SECTION 4215 OF THE CALIFORNIA GOVERNMENT CODE, THE CONTRACTOR SHALL DETERMINE THE EXACT LOCATION OF ALL EXISTING UTILITIES BEFORE COMMENCING THE WORK. CONTACT UNDERGROUND SERVICE ALERT (U.S.A.) AT 1-800-422-4133 TWO WORKING DAYS PRIOR TO ANY EXCAVATION.

7. DIMENSIONING TO CURBS SHALL BE TO FACE OF CURB. 8. CONTRACTOR SHALL DISPOSE OF ALL DEBRIS OFF-SITE DAILY, UNLESS OTHERWISE SPECIFIED BY THE CITY ENGINEER.

9. CONTRACTOR SHALL REMOVE ANY ABANDONED UTILITY FACILITIES AND SHOW LIMITS OF REMOVALS ON THE

10. THE CONTRACTOR SHALL BE RESPONSIBLE FOR THE REMOVAL. REPLACEMENT OR RELOCATION OF ALL REGULATORY, WARNING AND GUIDE SIGNS.

11. A 'RECORD DRAWING' (FORMERLY CALLED "AS-BUILT" DRAWING) OF THIS PLAN SHALL BE SUBMITTED BY THE PROJECT

ENGINEER OF RECORD TO THE CITY ENGINEER, FOR APPROVAL PRIOR TO ACCEPTANCE OF THE WORK. 12. CONSTRUCTION SIGNING, LIGHTING AND BARRICADING SHALL BE PROVIDED ON ALL PROJECTS AS REQUIRED BY CITY STANDARDS OR AS DIRECTED BY THE CITY ENGINEER. AS A MINIMUM, ALL CONSTRUCTION SIGNING, LIGHTING AND BARRICADING SHALL BE IN ACCORDANCE WITH PART 6" TEMPORARY TRAFFIC CONTROL" OF THE CALIFORNIA MANUAL ON UNIFORM TRAFFIC CONTROL DEVICES FOR STREETS AND HIGHWAYS, DATED JANUARY 13, 2012, OR SUBSEQUENT EDITIONS IN FORCE AT THE TIME OF CONSTRUCTION.

13. THE FLOW LINE OF ALL CURB AND GUTTERS AND CROSS GUTTERS SHALL BE WATER TESTED BEFORE ACCEPTANCE OF THE

14. PARKING STALLS SHALL BE CLEARLY DELINEATED WITH A 4 TO 6 INCH STRIPE "HAIRPIN" OR ELONGATED "U" DESIGN OR OTHER APPROVED STRIPING OR STALL DELINEATION.

15. FINAL SITE GRADING AND DRAINAGE FLOW LINES SHALL BE CERTIFIED, IN WRITING, BY THE ENGINEER OF RECORD TO BE IN CONFORMANCE TO THE APPROVED GRADING PLAN PRIOR TO FINAL INSPECTION.

16. FOR PROJECTS IN EXCESS OF 1 ACRE, A NOTICE OF INTENT TO COMPLY WITH CALIFORNIA GENERAL CONSTRUCTION STORMWATER PERMIT (WATER QUALITY ORDER 2009-0009-DWQ AS MODIFIED SEPTEMBER 2, 2009, AS WELL AS A COPY OF THE EXECUTED LETTER ISSUING A WASTE DISCHARGE IDENTIFICATION (WDID) NUMBER, IS REQUIRED PRIOR TO ISSUANCE OF GRADING OR BUILDING PERMIT, VIA THE CALIFORNIA REGIONAL WATER QUALITY CONTROL BOARD (PHONE NO. (760) 346—7491). A UPDATED COPY OF THE PROJECT-SPECIFIC STORM WATER POLLUTION PREVENTION PLAN (SWPPP) MUST BE KEPT AT THE PROJECT SITE AT ALL TIMES.

17. A CITY APPROVED FUGITIVE DUST (PM-10) CONTROL PLAN IS REQUIRED PRIOR TO ISSUANCE OF A GRADING PERMIT. ALL DUST CONTROL MEASURES DESCRIBED IN AQMD RULE 403 (BEST AVAILABLE CONTROL MEASURES) AND IN THE CITY-APPROVED FUGITIVE DUST CONTROL PLAN SHALL BE IMPLEMENTED AT ALL TIMES. A WIND FENCE AND PROPER SIGNAGE, SHALL BE ERECTED, INSPECTED AND APPROVED BY THE CITY'S DUST CONTROL INSPECTOR PRIOR TO INITIATION OF CLEARING, GRUBBING, GRADING OR IMPORT/EXPORT OF SOIL, OR FILL MATERIAL AT THE SITE. FAILURE TO CALL 760-323-8253, EXTENSION 8740 FOR INSPECTION 72 HOURS PRIOR TO INITIATING WORK WILL RESULT IN ISSUANCE OF CITATION BY THE CITY.

18. THE BLOCK WALLS, RETAINING WALLS, AND OTHER STRUCTURES SHOWN ON THE GRADING PLAN ARE FOR LOCATION PURPOSES

ONLY. SEPARATE PERMITS FOR THE ABOVE ARE REQUIRED FROM THE BUILDING DEPARTMENT. 19. A GEOTECHNICAL INVESTIGATION REPORT WAS PREPARED FOR THE PROJECT BY SLADDEN ENGINEERING DATED APRIL 12, 2021; PROJECT NO. 544-21078, REPORT NO. 21-04-214, AS "PROPOSED RESIDENTIAL ADDITION/RENOVATION, 1345 LADERA CIRCLE, PALM SPRINGS,CA". IN ADDITION, AN ADDENDUM WAS PREPARED FOR THE PROJECT BY SLADDEN ENGINEERING DATED SEPTEMBER 7, 2021; PROJECT NO. 544-21238, REPORT NO. 21-09-580, AS "PROPOSED RESIDENTIAL ADDITION/RENOVATION, 1345 LADERA CIRCLE, PALM SPRINGS,CA"

20. THE ASPHALT CONCRETE DESIGN SHALL MEET THE CITY OF PALM SPRINGS STD. DWG. NO 110 AND STANDARD SPECIFICATIONS FOR PUBLIC WORKS CONSTRUCTION, 2016 EDITION; USE TYPE B FOR THE BASE LIFT AND TYPE C2 FOR THE FINAL 1" CAP. THE DESIGN SHALL HAVE A HVEEM STABILITY OF 35 AND 33 RESPECTIVELY PER THE CALIFORNIA TEST METHOD 304 AND 366. PERFORMANCE GRADE ASPHALT (PG 70- 10) MEETING THE 2010 CALTRANS STANDARD SPECIFICATIONS SHALL BE USED. THE SPECIFIED MISCELLANEOUS BASE SHALL BE CRUSHED MISCELLANEOUS BASE ACCORDING TO THE STANDARD SPECIFICATIONS FOR PUBLIC WORKS CONSTRUCTION, 2012 EDITION.

TRENCH PAVEMENT 21. STREET CUTS SHALL BE PAVED WITH TEMPORARY A.C. PAVING IMMEDIATELY. MAJOR AND SECONDARY THOROUGHFARES SHALL BE PERMANENTLY PAVED WITHIN 15 DAYS OF THE INITIAL EXCAVATION (30 DAYS ON COLLECTOR AND RESIDENTIAL STREETS) PER CITY OF PALM SPRINGS STD. DWG. NO. 115. SEE ORDINANCE NO. 14.16.375.

22. TRENCHES SHALL BE COMPLETELY BACKFILLED AND COMPACTED TO SUPPORT TRAFFIC AT THE END OF EACH WORK DAY. THE CONTRACTOR SHALL PLACE PERMANENT PAVEMENT THROUGH INTERSECTIONS AT THE END OF EACH WORK DAY. NO TRENCH EXCAVATION OR PIPE LAYING ON FRIDAYS, WEEKENDS OR HOLIDAYS WILL BE PERMITTED ON MAJOR AND SECONDARY THOROUGHFARES OR COLLECTOR STREETS WITHOUT PRIOR APPROVAL OF THE CITY ENGINEER. CONTRACTOR SHALL PLACE PERMANENT PAVING EACH FRIDAY.

23. IF, IN THE OPINION OF THE CITY ENGINEER, THE TRENCH BACKFILL IS UNSAFE TO TRAFFIC, THE CONTRACTOR SHALL PLACE PERMANENT PAVING AT THE END OF EACH WORK DAY.

24. STEEL TRENCH PLATING SHALL CONFORM TO THE CALTRANS ENCROACHMENT PERMIT MANUAL SECTION

25. THE SPECIFIED MISCELLANEOUS BASE SHALL BE CRUSHED MISCELLANEOUS BASE ACCORDING TO THE STANDARD SPECIFICATIONS FOR PUBLIC WORKS CONSTRUCTION, 2016 EDITION.

> P.O. Box 12980 Palm Desert, California 92255 (760) 346-8015

FOR: Shahbaz Residence FILE NO. CITY OF PALM SPRINGS, CALIFORNIA E-XXXXPRELIMINARY GRADING PLAN OF

AS-BUILT ORRECTED APPROVED DATE DATE REVISION APPROVED DATE

BENCH MARK NO. BM 10-2 ELEV. 562.813' CHISELED BOX AT N.N.W. B.C.R., VIA MONTE VISTA AND LAS PALMAS

PREPARED UNDER THE DIRECT SUPERVISION OF DESIGN BY RONALD K. FEIRC CHECKED BY

C52260 R.C.E. NO DATE-


CITY FIELD ENGINEER

REVIEWED BY IOHN M. BRUDIN INITIAL DATE

APPROVED BY: OEL MONTALVO 41836 62624 R.C.E. NO.

850 S Las Palmas Lot 82. Vista Las Palmas No.1. Per MB 32/45: APN 505-082-011

DRAWING NO SHEETS

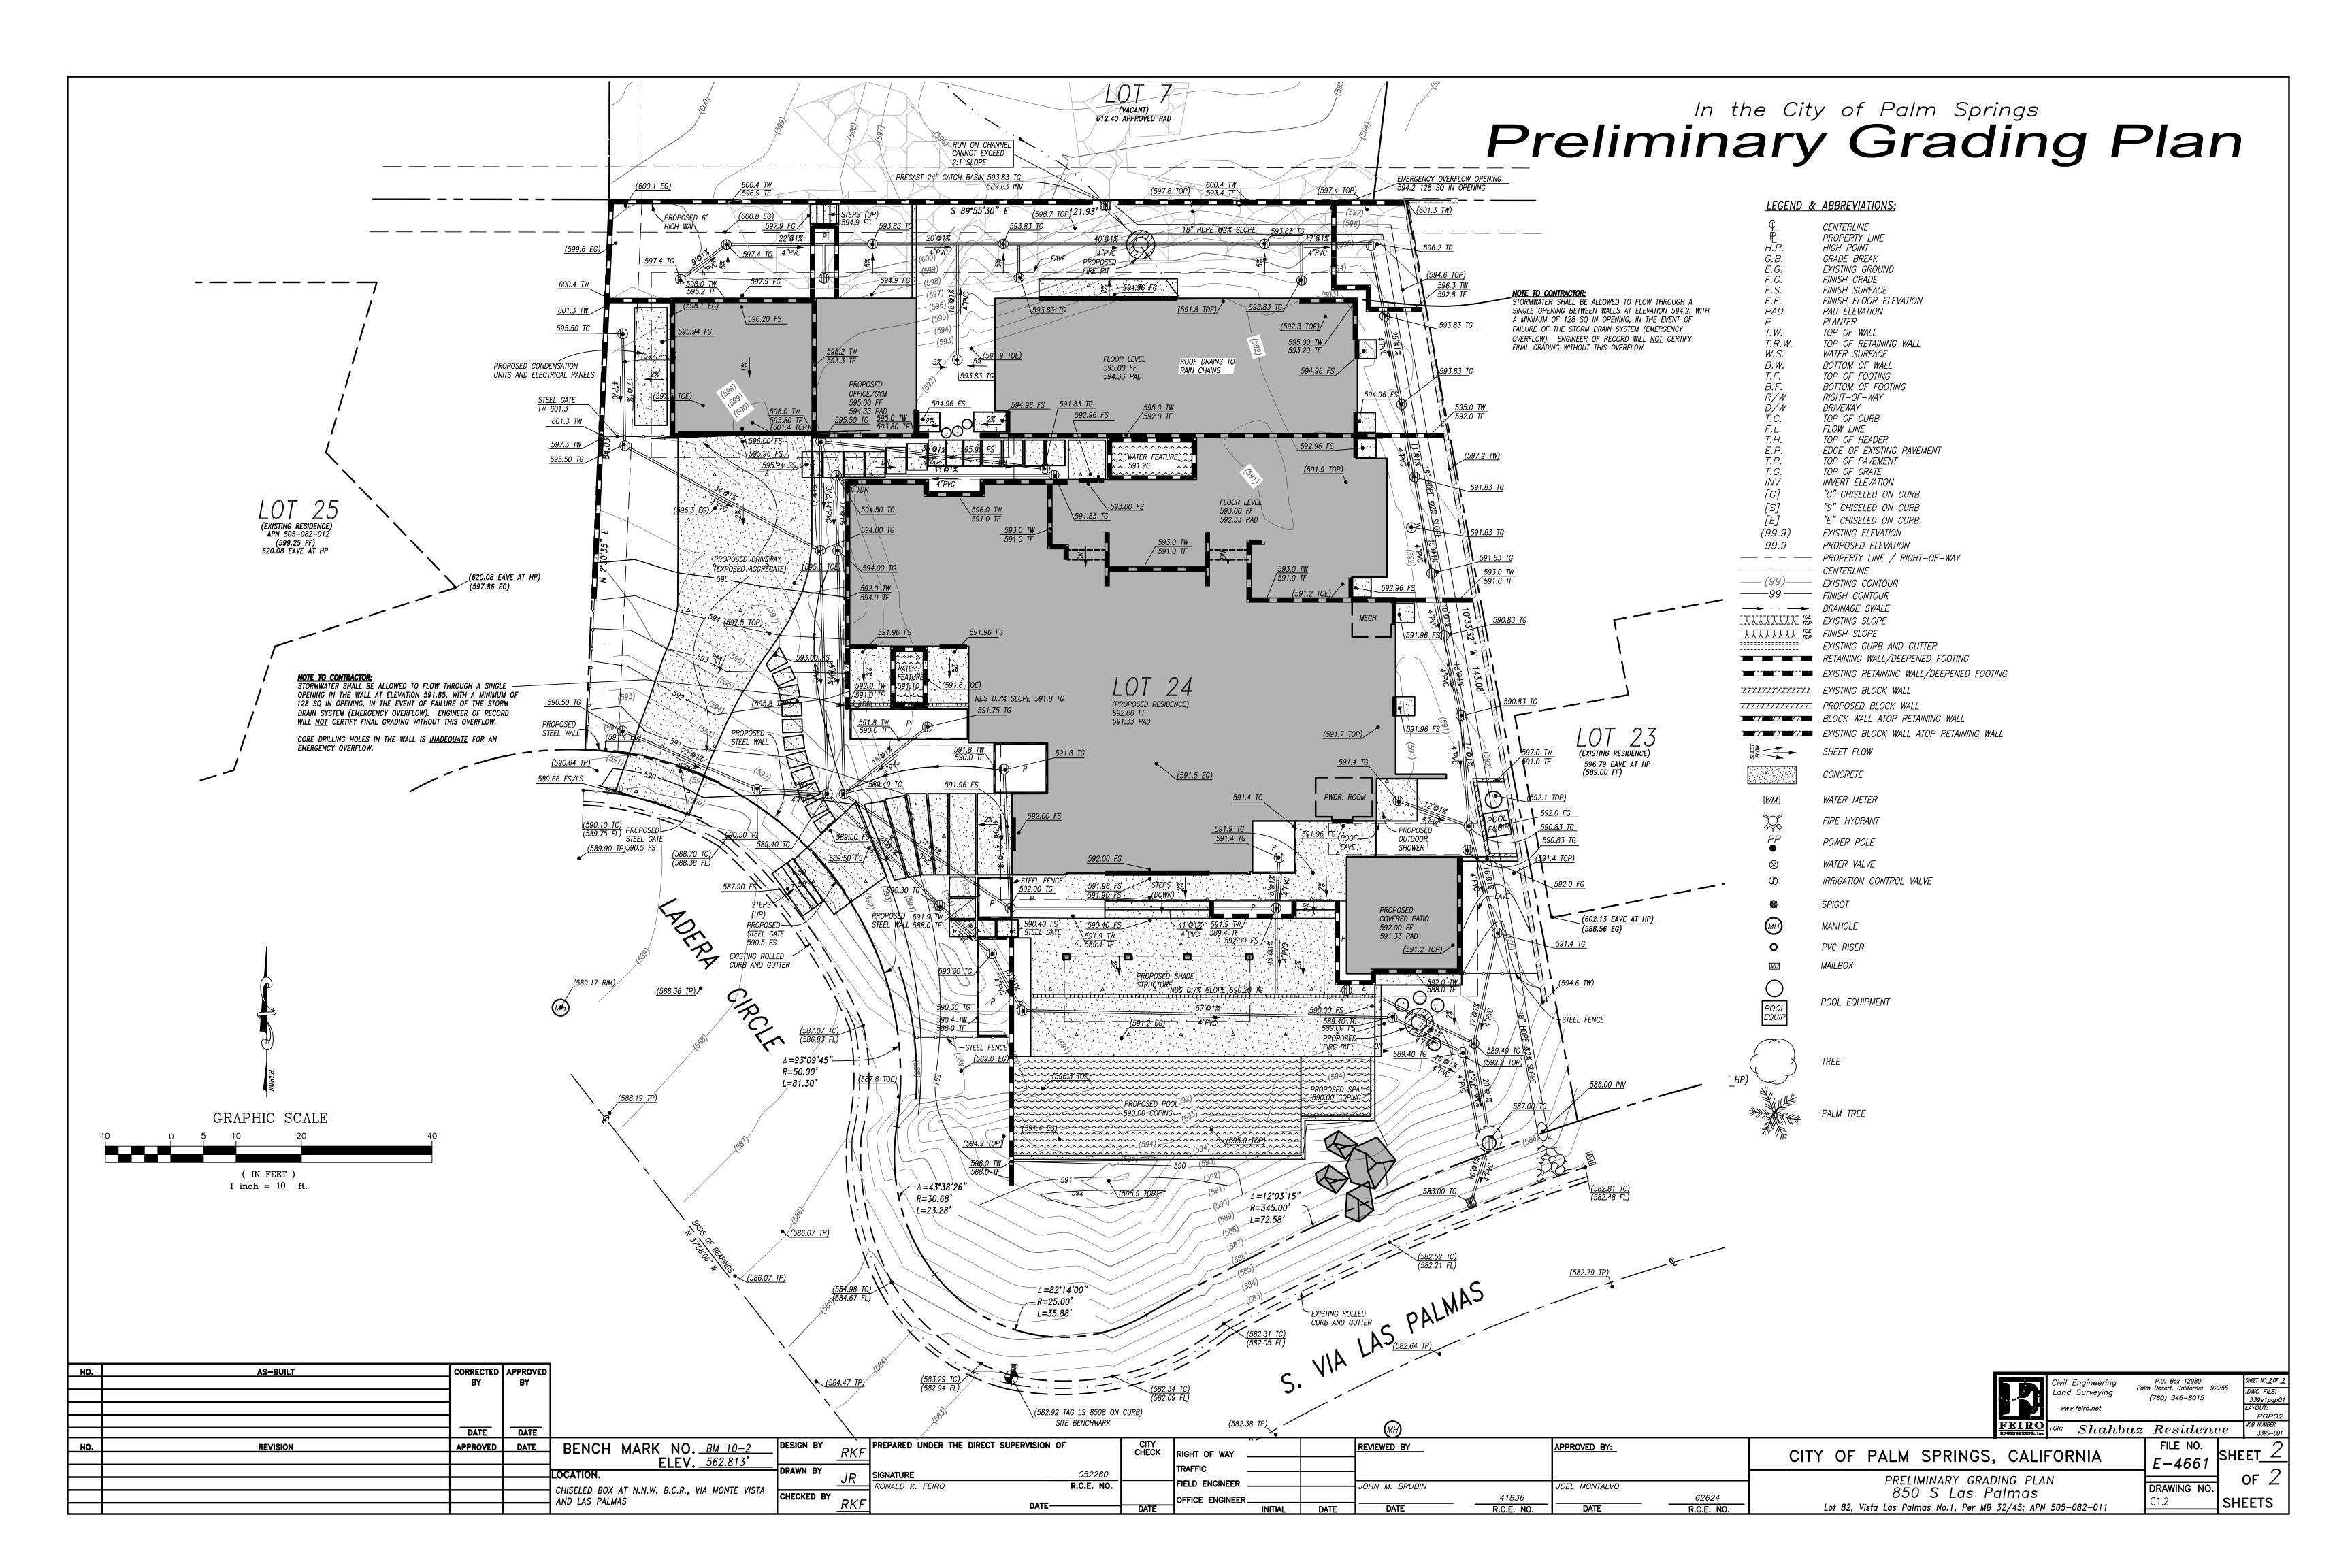



PALM SPRINGS, CA 92262

850 VIA LAS PALMAS APN: 505082011

RON H. KAPPE C-18457

MAJ REVIEW 06/24/2022 REV1 07/11/2022 All drawings and written material herein are the original and unpublished property of and all rights are reserved by Kappe Architects. The same may not be duplicated, used without written or disclosed consent. Material herein is for use by authorized contractors, bidders and subcontractors in connection with this project only. All dimensions on these drawings shall take precedence over scaled dimensions. Contractors shall be responsible to verify all dimensions and conditions on the job. This office must be notified of any variations from the dimensions and conditions shown by these drawings. Shop drawings must be reviewed by this office before proceeding with fabrication.

Sheet Title: LANDSCAPE AND PLANTING PLAN

OLEA EUROPEA 'MAJESTIC BEAUTY' MAJESTIC BEAUTY OLIVE



MUHLENBERGIA CAPILLARIS PINK MUHLY



YUCCA ROSTRATA BEAKED YUCCA



AGAVE 'BLUE FLAME' BLUE FLAME AGAVE



AGAVE PARRYI PARRY'S AGAVE



ACER PALMATUM 'SANGO KAKU' CORAL BARK JAPANESE MAPLE



JASMINUM NITIDUM ANGELWING JASMINE



CERCIDIUM X 'DESERT MUSEUM' DESERT MUSEUM PALO VERDE



ALOE TONGAENSIS 'MEDUSA' MOZAMBIQUE TREE ALOE



BOUGAINVILLEA 'CALIFORNIA GOLD' CALIFORNIA GOLD BOUGAINVILLEA



YUCCA ROSTRATA BEAKED YUCCA



AGAVE 'BLUE FLAME' BLUE FLAME AGAVE



ARTEMISIA CALIFORNICA 'POWIS CASTLE' POWIS CASTLE ARTEMISIA



ACACIA WILLARDIANA PALO BLANCO



AGAVE DESMETTIANA VARIEGATA VARIEGATED SMOOTH AGAVE



CAREX DIVULSA BERKELEY GREY SEDGE



MEXICAN FAN PALM



FICUS NITIDA FICUS



DASYLIRION QUADREANGULATUM MEXICAN GRASS TREE





JUSTICIA CALIFORNICA CHUPAROSA



SPHAERALCEA AMBIGUA APRICOT MALLOW



FOUQUIERIA SPLENDENS OCOTILLO



AGAVE PARRYI PARRY'S AGAVE



AGAVE DESERTII DESERT AGAVE

# BEDROOM COURTYARDS







PLUMERIA RUBRA'DWARF SINGAPORE PINK' DWARF SINGAPORE PINK PLUMERIA




EUPHORBIA CHARACIAS LARGE MEDITERRANEAN SPURGE



AGAVE 'BLUE FLAME' BLUE FLAME AGAVE



ARTEMISIA CALIFORNICA 'POWIS CASTLE' POWIS CASTLE ARTEMISIA

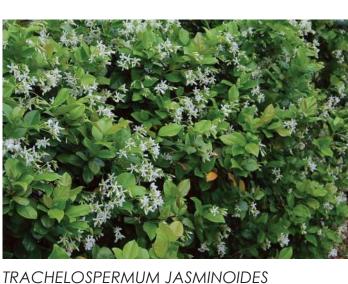

TRACHELOSPERMUM JASMINOIDES STAR JASMINE

# **POOL-SIDE PLANTS**



ACACIA WILLARDIANA PALO BLANCO




OLEA 'LITTLE OLLIE' LITTLE OLLIE DWARF OLIVE



WISTERIA BRACHYBOTRYS 'IKO YAMA FUJI' IKO YAMA FUJI SILKY WISTERIA



AGAVE WEBERII

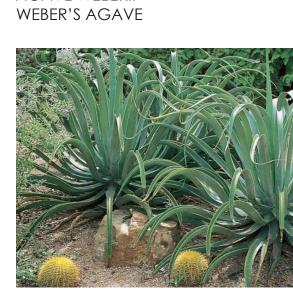

AGAVE VILMORINIANA OCTOPUS AGAVE



AGAVE GEMINIFLORA TWIN-FLOWERED AGAVE



AGAVE DESMETTIANA 'QUICKSILVER' QUICKSILVER SMOOTH AGAVE



ECHEVERIA 'AFTERGLOW' AFTERGLOW ECHEVERIA



ECHEVERIA 'PERLE VON NURNBERG' PERLE VON NURNBERG ECHEVERIA



AGAVE PARRYI PARRY'S AGAVE



EUPHORBIA MYRSINITES CREEPING SPURGE



DICHONDRA ARGENTEA 'SILVER FALLS' SILVER FALLS DICHONDRA

Sheet Title: LANDSCAPE PLANT PALETTE

Sheet Number:

SIDENCE

SHAHBA

Project:

Project No.:

Drawn By: Checked By:

MAJ REVIEW 06/24/2022

APN: 505082011

850 VIA LAS PALMAS

PALM SPRINGS, CA 92262

RON H. KAPPE

C-18457

21002

All drawings and written material herein are the original and unpublished property of and all rights are reserved by Kappe Architects. The same may not be duplicated, used without written or disclosed consent.

Material herein is for use by authorized contractors, bidders and subcontractors in connection with this project only. All dimensions on these drawings shall take precedence over scaled dimensions.

Contractors shall be responsible to verify all dimensions and conditions on the job. This office must be notified of any variations from the dimensions and conditions shown by these drawings. Shop drawings must be reviewed by this office before proceeding with fabrication.

REV1 07/11/2022