DATE: March 7, 2023 NEW BUSINESS

SUBJECT: A REQUEST BY THE CITY OF PALM SPRINGS FOR APPROVAL OF A

CERTIFICATE OF APPROPRIATENESS FOR ALTERATIONS TO "THE PLAZA THEATRE", A CLASS 1 HISTORIC SITE LOCATED AT 128 SOUTH PALM CANYON DRIVE; HSPB #22-A / Case 3.1149. (APN 513-

144-010). (SY).

FROM: Department of Planning Services

#### SUMMARY

This request is to alter and rehabilitate the Plaza Theatre building in order to allow its reopening as a performing arts venue. This City-owned Class 1 (Landmark) Site was constructed in 1936 and designed by architect Harry Williams for Julia Carnell. The proposed scope of work includes interior and exterior restoration, alterations to the covered front entry porch and lobby, updates to HVAC, electrical equipment and other various service upgrades. The rehabilitation is being undertaken by the Plaza Theatre Foundation on behalf of the City of Palm Springs.

#### RECOMMENDATION:

Approve the Certificate of Appropriateness for alterations and rehabilitation of the historic Plaza Theatre as proposed.

#### **BACKGROUND AND SETTING:**

The Plaza Theatre was constructed as a part of the larger mixed-use complex known as La Plaza. The historic theatre is an example of an atmospheric theatre which was constructed using cast-in-place concrete, concrete masonry and heavy timber. This site was granted Class 1 (Landmark) status in 1991 when the City Council adopted Resolution No. 17678. The property was later acquired by the City in 2015 with the condition to maintain its operation as a performing arts venue.

Over the years several condition assessments have been conducted on the building, and last summer Architectural Resources Group, Inc. (ARG) was selected to provide a detailed proposal outlining the renovation/rehabilitation of the theatre.



Relevant and Recent Past Actions Adaptive reuse to develop a combination live theatre and film 1988-1991 screening theatre. Theatre lease agreement to accommodate the "Follies" live performance. They operated out of the Plaza Theatre until 2014. Community Redevelopment Agency (CRA) acquired the Plaza September, 1998 Theatre through a lease/purchase agreement. February, 2014 Conditions assessment prepared by Interactive Corporation. The City of Palm Springs acquires the Plaza Theatre from the September, 2016 CRA. November, 2018 Feasibility and concept design package submitted by Gensler & Associates, Inc. 2021 Formation of the Plaza Theatre Foundation.

#### **ANALYSIS:**

The proposal submitted by ARG on behalf of the Plaza Theatre Foundation dated January 27, 2023 is accompanied by drawings with detailed analysis. Alterations to the exterior mainly deals with new fenestration.

The proposed scope of work is organized into seven categories:

- 1. Front Entry Porch enclose outdoor porch to expand lobby.
  - a. Install new glazed doors and windows, custom steel finish with exterior pulls and panic hardware (A8.00 and A8.01).
  - b. Restore, clean and repair existing finishes in the newly enclosed space (A4.00).



BELOW EXISTING SPACE PROPOSED TO BE ENCLOSED

- 2. Exterior: Install <u>fenestration South elevation.</u>
  - a. Install matching glazed doors and windows with steel frames on the ground level, non-street facing façade (A2.02) in existing blind masonry arches.
- 3. Exterior: Repaint building surface.
  - a. Recommended exterior paint colors based on forensic study of the exterior wall using microscopy analysis (G4.00).
- 4. Exterior: Remove existing felts and clay tile and replace with new felts and reinstallation of existing clay tile replacement of clay tiles as needed.
  - a. Install additional sheathing and underlayment.
  - b. Install new flashing and gutters.
- 5. Exterior: HVAC and electrical equipment update.
  - a. Equipment to be screened from view.
  - b. Condensers and other similar equipment proposed along the east elevation.
  - c. Removal of existing floor and the construction of a new sub floor to contain new air plenums.

- 6. Interior: Restoration work based on forensic study and historic documentation.
  - a. Restore and repair atmospheric sidewalls and ceiling.
  - b. Restore historic light fixtures or replace to match.
  - c. Restore historic finishes and treatments for stenciling in the main lobby and proscenium.
- 7. Interior: Renovations and upgrades.
  - a. Accessible seating area with level floors at the rear of the auditorium.
  - b. Replace all theater seating.
  - c. Creation of new sound control booth at rear of theater.
  - d. New bar and concessions area in the main lobby.
  - e. Renovated restrooms and offices.
  - f. Reconfigured stage for modern use with new suspended stage floor and extended apron.
  - g. New accessible dressing rooms with restrooms below the stage.
  - h. Updated theatrical equipment including lighting truss, AV, and acoustical finishes.
  - i. Renovated south corridor with four (4) steel-framed wall-mounted displays showing historic images of the theater.

Certificates of Appropriateness ("C of A's") are processed pursuant to Municipal Code Section 8.05.110 as follows:

<u>Criteria and Findings for alterations to Class 1 and 2 sites:</u>
The HSPB shall approve the C of A's if the following findings can be met

1. That the proposed alteration does not significantly impact or materially impair the character-defining features of the historic resource as listed in the resolution for historic designation, or, where a character-defining feature may be impacted, the proposed alteration minimizes that impact as much as possible.

The proposed steel framed fenestration to enclose the outer lobby space is a simple and understated solution that supports current operational needs for increased lobby space. This reconfiguration of space does not visually or materially impair any character-defining feature of the historic resource. The interior upgrades are necessary changes to utilize the space as a performing arts venue, and the restoration of features pertaining to the atmospheric theatre is based on forensics and historic analysis. Existing surfaces will be cleaned, repaired and surface paint and stenciled designs will be restored in accordance with the recommendations provided. The project conforms to this finding.

2. That the proposed alteration will assist in restoring the historic resource to its original appearance where applicable, or will substantially aid its preservation or enhancement as a historic resource;

The proposed alterations aid in the enhancement of the historic resource. Enclosing the outer lobby adds space without adding bulk and mass and maintains the original appearance of the historic resource. The interior upgrades to the stage and dressing rooms increase the usability of the space yet maintain the historic layout of the theatre. The project conforms to this finding.

3. That any additions to the historic resource are consistent with the massing, proportions, materials, and finishes of the existing historic resource, and: (i) can be distinguished from the existing historic resource as may be appropriate; or (ii) are indistinguishable from the historic resource as may be appropriate, and where such alterations are clearly documented in the City's archival file for the historic resource as being non-original to the historic resource;

Most of the alterations are simple in style, materials and finishes. Existing historic openings are being utilized and, in some cases, restored to their original function. Once the changes are complete, they will not draw attention but rather be harmonious with the historic resource. The documentation included in this application will be added to the archival file to identify the non-original components that are proposed. Thus, the project also conforms to this finding.

4. That, in cases where Federal funds are to be utilized in financing the proposed alterations, the alterations are consistent with the Standards for the Treatment of Historic Properties, as put forth by the U.S. Secretary of the Interior.

No federal funds are involved in this project. Small test patches were identified for testing cleaning methods and small samples were extracted for further analysis to determine best preservation practice. After surface cleaning, historic finishes are to be treated and restored in accordance with the Secretary of Interior Standards.

#### **ENVIRONMENTAL ASSESSMENT**

The proposed alterations are considered a project pursuant to the guidelines of the California Environmental Quality Act ("CEQA"). Staff has evaluated the proposal relative to the CEQA Guidelines and determined the project to Categorically Exempt from further evaluation under CEQA as a Class 31 because the project proposes restoration, rehabilitation, maintenance, and preservation in a manner that is consistent with the Secretary of the Interior Standards as follows:

Enclosing the outer lobby space is proposed in a manner that minimizes the
physical changes to the structure and does not damage or remove characterdefining materials or finishes that contribute to the historic significance of the
property.

- Installing new fenestration to the south elevation will be harmonious and compatible with the architectural style of the theatre because it will restore the original openings.
- New HVAC and electrical equipment are necessary to meet current code requirements. Equipment will be installed in a discrete location on the back (east) side of the building, fully screened from public view and does not impact any character-defining features of the historic resource.
- New roof membrane is necessary to replace the existing membrane which is at the end of its life cycle. The existing clay tiles will be reused to the best extent possible.
- Damaged clay roof tiles will be replaced with new tile to match existing. The roof work will not damage or alter the historic appearance of the building.
- Cleaning and repainting the exterior of the structure is considered maintenance and the paint colors will be restored to the historic colors as revealed during the analysis. This work is consistent with the Secretary of Interior Standards and does not adversely impact the resource.

#### **CONCLUSION:**

The proposed scope of work does not materially impair any character-defining features or those elements that contribute to the site's historic significance. The restoration work is based on material investigation and reference the original construction drawings for the building. Service updates will improve the operational reliability of the infrastructure systems and meet contemporary codes where possible. The proposed alteration to the outer lobby space does change the historic use of this area but does so in a visually harmonious manner that does not materially impair the historic significance of the site. The necessary criteria for a Certificate of Appropriateness are met, and staff recommends approval.

PREPARED BY:	Sarah Yoon, Associate Planner/Historic Preservation Officer
REVIEWED BY:	Ken Lyon, RA , Principal Planner
REVIEWED BY:	Christopher Hadwin, Director of Planning Services


#### Attachments:


- A. Vicinity Map.
- B. Application, related background materials, photos.
- C. City Council Resolution for Designation.






### Department of Planning Services Vicinity Map

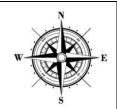

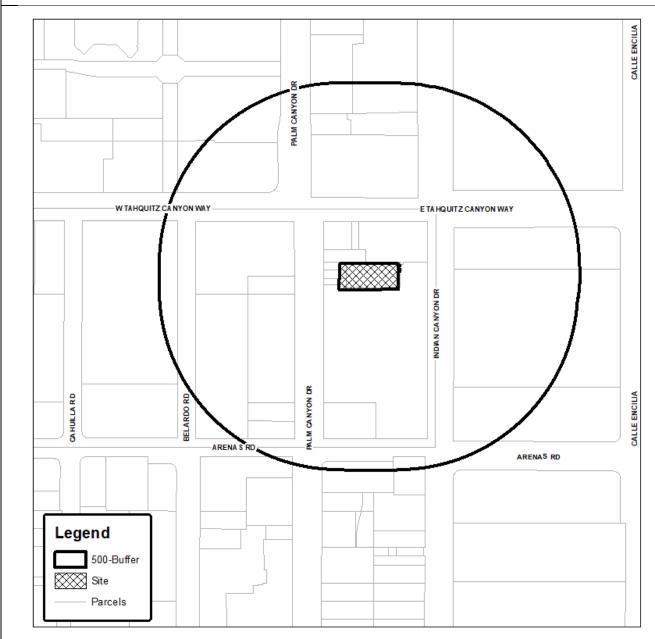

CITY OF PALM SPRINGS HSPB #22-A/ Case #3.1149 – Plaza Theatre 128 S. Palm Canyon Drive

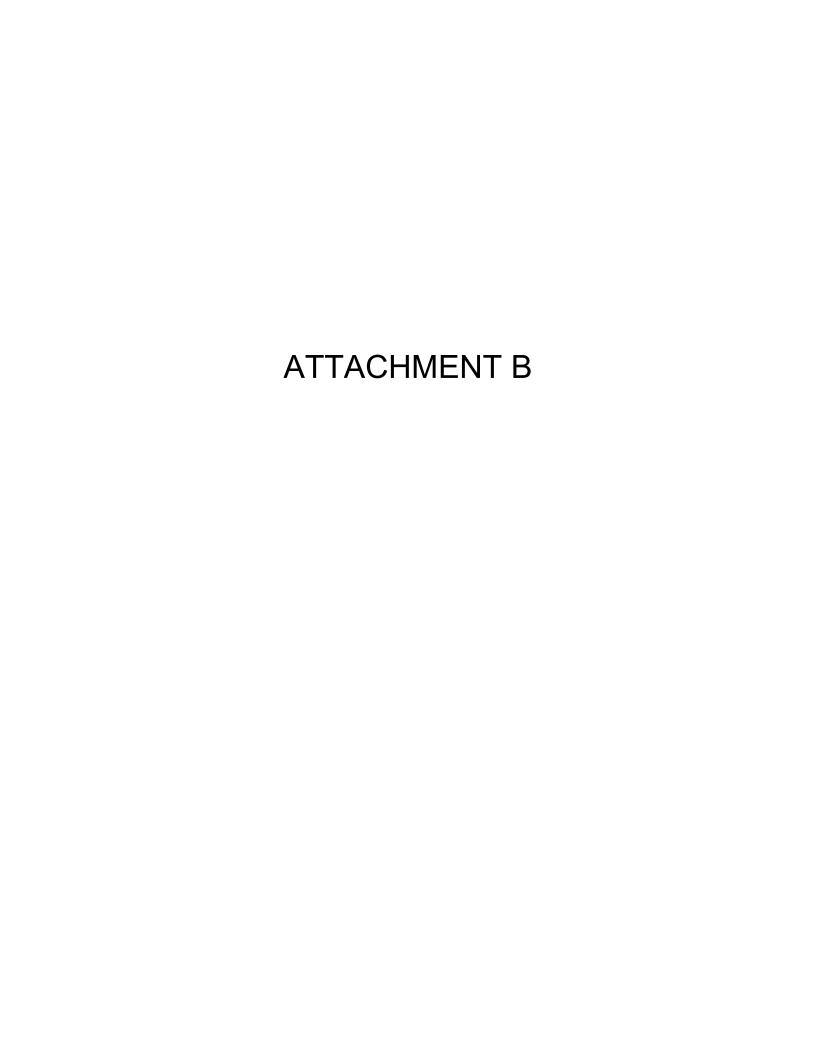



#### CITY OF PALM SPRINGS

Department of Planning Services 3200 E. Tahquitz Canyon Way, Palm Springs, CA 92262 Tel: 760 323 8245 - Fax: 760 322 8360

(For Staff Use Only))
Planning Case Number & HSPB #: HSPB 22A / 3.1149
55
RB
Taken in by (Planner):
01/30/2023
01/30/2023
Date Submitted:

#### CERTIFICATE OF APPROPRIATENESS APPLICATION (C OF A)

TO THE APPLICANT: USE THIS FORM FOR PROPOSED ALTERATIONS TO CLASS 1 AND CLASS 2 HISTORIC SITES AND CONTRIBUTING STRCTURES IN A DESIGNATED HISTORIC DISTRICT. Please fill out the information requested below. Attach any signed authorization letters, drawings, color & material boards,

### photographs, cut sheets and/or any other materials necessary to describe the proposed project. PROJECT INFORMATION. Project Address: (Number and Street name) APN: (9-digit assessor parcel number ex: 000-000-000) Project Name (example: Name of Condo Association or HOA): Zone: General Plan: Section/Township/Range: 15 / Lot Area: Detailed Description of Project: PROPERTY OWNER INFORMATION: Property Owner's Name: Property Owner's Signature: City Owned Property Property Owner's Mailing Address: (Number and Street Name or P.O. Box) Property Owner's Phone: Fax\_ Property Owner's Email: CONTRACTOR, PROJECT MANAGER, OR OWNER'S AGENT AUTHORIZED TO INITIATE THE WORK: Company Name: (Please print) I AM THE: □ OWNER'S AUTHORIZED AGENT (example CONTRACTOR) □ LESSEE (TENANT) □ OTHER Agent's Name & Signature: Jazm Curre Agent's Mailing Address: (Number and Street Name or P.O. Box) State Agent's Phone: Agent's Fax: Agent's Email:

(Please continue to next page)

#### REQUIRED MATERIALS TO BE SUBMITTED FOR A CERTIFICATE OF APPROPRIATENESS:

The following materials are necessary for your application to be evaluated pursuant PSMC 8.05. Use this list to assemble your application materials.

Use	Use:	
<b>X</b>	↓ □	<u>Complete the Certificate of Appropriateness Application:</u> (attached to this instruction packet)
□N/A		<u>Authorization Letter or Contract signed by Owner or HOA representative</u> (if project is within a condo or HOA, or if application is being completed by owners' agent)
X		Photographs of each exterior side of the historic resource or object to be altered or demolished.:
X		<ul> <li>Drawings (Site Plan, Floor Plan, Elevations, etc. Provide a north arrow and the project's street address. Site plans are usually submitted at 24" x 36", to a scale not smaller than 1" = 40'. (An 11"x 17" site plan may be sufficient for minor alterations. The site plan should include the following information:         <ul> <li>All property boundaries and distance to centerline of abutting street (obtain from the Public Works Department) and setbacks.</li> <li>All walls, sidewalks, driveways, gates, pools, accessory structures, landscaping, etc.</li> <li>(Differentiate existing from new work by differing line weights or by notation).</li> </ul> </li> </ul>
X		<u>Color and Material Exhibits:</u> Provide swatches of actual paint colors proposed and cut sheets or small samples of materials where appropriate. Photographs of existing materials that will be matched is encouraged. Where a full color/material board is required, the board should be no larger than 8-1/2" x 11".
		Payment of Application Fees.

<u>PROCEDURE FOR EVALUATING C OF A'S:</u> C of A's for Class 1 and 2 sites are processed as outlined in PSMC 8.05.090 (D,3). C of A's for alterations to contributing sites in a Historic District are processed as outlined in PSMC 8.05.120 (D,3).

<u>CRITERIA FOR APRPOVAL OF C OF A'S:</u> C of A's for Class 1 and 2 sites are evaluated based on the criteria and findings in PSMC 8.05.090 (E). C of A's for contributing sites in a Historic District are evaluated based on the criteria in PSMC 8.05.120(E).

**TIME LIMIT FOR DEVELOPMENT:** Approvals given on Certificate of Appropriateness Applications are valid for two (2) hears from the Effective Date that the approval is made (see definition of Effective Date below). After Planning approvals are granted, applicants must apply for building permits through the City Department of Building and Safety. If building permits are not pulled or the construction initiated within two (2) years of the Effective approval date, the planning approval expires. Blanket C of A approvals have no expiration date.

**EFFECTIVE DATE:** Approval becomes "effective" after an elapsed period of fifteen (15) days from the date of the decision by the Historic Preservation Officer, Historic Site Preservation Board or City Council. Any project for which a building permit application is made, or a building permit is issued <u>prior to</u> the Effective Date of the approval, are deemed to be made "at the risk" of the applicant such that an appeal could modify or overrule the subject approval.



































# PLAZA THEATRE REHABILITATION



# PALM SPRINGS PLAZA THEATRE

### REHABILITATION

**HSPB SUBMITTAL** 

128 S PALM CANYON DRIVE, PALM SPRINGS, CA 92262

### **PROJECT TEAM**

PALM SPRINGS PLAZA THEATRE FOUNDATION 1775 E. PALM CANYON DR. SUITE 110-1028 PALM SPRINGS, CA 92264 O 760 218-6330

JR ROBERTS, PRESIDENT D 415 297-9309 JR66@MAC.COM

CITY OF PALM SPRINGS

LOS ANGELES, CA 90012

DEPARTMENT OF PROCUREMENT & CONTRACTING 3200 TAHQUITZ CANYON WAY PALM SPRINGS, CA 92262

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ARCHITECT ARCHITECTURAL RESOURCES GROUP, INC. 360 E. 2ND STREET, SUITE 225

PRINCIPAL IN CHARGE: KATIE HORAK D (626) 583-1401 X 103

K.HORAK@ARGCREATE.COM DESIGN PRINCIPAL: NAOMI MIROGLIO

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PROJECT MANAGER/SENIOR ARCHITECT: JASON CURRIE D (415) 421 1680 x 246 J.CURRIE@ARGCREATE.COM

ARCHITECTURAL CONSERVATOR: SARAH DEVAN D (626) 583-1401 x 123 S.DEVAN@ARGCREATE.COM

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NEW YORK, NY 10010

JIM NIESEL, PRINCIPAL IN CHARGE D (203) 528-0370 JNIESEL@THEATREPROJECTS.COM

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ACOUSTICAL CONSULTANT MCKAY CONANT HOOVER, INC. 346 EAST JACKSON AVENUE

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**TAYLOR BLAINE** D(657) 650-2050 TBLAINE@MCHINC.COM

ORANGE, CA 92867

<u>ARCHITECTURAL LIGHTING CONSULTANT</u> ANN KALE ASSOCIATES 1569 SAN LEANDRO LANE

SANTA BARBARA, CA 93108 ANN KALE, PRINCIPAL D (805) 969-7660 X 1#

AKALE@ANNKALE.COM **NATHANIEL BARTOS** 

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RUSSELL KEHL, SE, PRESIDENT, PRINCIPAL RKEHL@STRUCTURALFOCUS.COM

KEVIN ADAMSON, PE, DESIGN ENGINEER KADAMSON@STRUCTURALFOCUS.COM

MECHANICAL, ELECTRICAL, & PLUMBING ENGINEER **AMA GROUP** 2155 CAMPUS DRIVE, SUITE 220

CHRISTOPHER CARSON, PRINCIPAL D (310) 846-4659 CCARSON@AMAGROUPUSA.COM

EL SEGUNDO, CA 90245

### PROJECT SUMMARY

THIS PROJECT ENCOMPASSES THE REHABILITATION OF THE HISTORIC PALM SPRINGS PLAZA THEATRE ORIGINALLY

- EXPANDED CONDITIONED LOBBY AREA, BY ENCLOSING THE OUTER LOBBY WITH NEW GLAZED DOORS AND WINDOWS

- RENOVATED INNER LOBBY WITH NEW BAR/ CONCESSIONS AREA

- NEW THEATER SEATS, WITH A LEVELED FLOOR AREA FOR WHEELCHAIR ACCESSIBLE SEATING

- REPAIR OF THE HISTORICALLY SIGNIFICANT ATMOSPHERIC SIDEWALLS AND CEILING - HISTORIC FINISHES TREATMENTS FOR THE STENCILING AT THE LOBBY AND PROSCENIUM. AS WELL AS RESTORATION OF THE HISTORIC LIGHT FIXTURES

- RENOVATION OF THE RESTROOMS WITH NEW FIXTURES AND ACCESSORIES

- A RECONFIGURED STAGE, WITH REMOVABLE FORESTAGE, AND NEW STAGE FLOOR

- NEW THEATRICAL EQUIPMENT, INCLUDING THEATRICAL LIGHTING TRUSS, GRID, AND DRAPERY - NEW A/V AND SURROUND SOUND SYSTEMS

- MODERNIZED DRESSING ROOMS, WITH RESTROOMS AND SHOWERS, WITH A NEW ACCESSIBLE STAR DRESSING ROOM

- ADDITIONAL ACOUSTICAL FINISHES TREATMENTS AND SOUND CONTROL IMPROVEMENTS THROUGHOUT - COMPLETE NEW HVAC SYSTEMS. AND ELECTRICAL EQUIPMENT

### PROJECT DATA

FIRE SPRINKLERS:

128 S PALM CANYON DRIVE LOT/LOCATION: PALM SPRINGS, CA, 92262

APN: 513-144-010

**OCCUPANCY**: A-1 PERFORMING ARTS/ MOTION PICTURE THEATRE, WITH FIXED SEATS, &

B DRESSING ROOMS

CONSTRUCTION TYPE: III-B

BUILDING HEIGHT/STORIES: 55'-5 1/2" 2 STORIES

FULLY SPRINKLERED **BUILDING AREAS:** 

900 SF BASEMENT 11,130 SF FIRST FLOOR 3,080 SF SECOND FLOOR

15,110 SF TOTAL

SEE SHEETS G1.20 & G1.21 FOR ADDITIONAL CODE ANALYSIS

### APPLICABLE BUILDING CODES

THE SECRETARY OF THE INTERIOR'S STANDARDS AND ILLUSTRATED GUIDELINES FOR REHABILITATING HISTORIC BUILDINGS, REVISED 2017 \*36CFR 67), P.L 89-665.

CALIFORNIA CODE OF REGULATIONS TITLE 24, 2022 CALIFORNIA BUILDING CODE,

**INCLUDING:** 

PART 2 CALIFORNIA BUILDING CODE, VOLUMES 1 & 2 PART 3 CALIFORNIA ELECTRICAL CODE

PART 4 CALIFORNIA MECHANICAL CODE PART 5 CALIFORNIA PLUMBING CODE

PART 6 CALIFORNIA ENERGY CODE PART 7 CALIFORNIA ELEVATOR SAFETY CONSTRUCTION CODE

PART 8 CALIFORNIA HISTORICAL BUILDING CODE

PART 9 CALIFORNIA FIRE CODE PART 10 CALIFORNIA EXISTING BUILDING CODE

ACCESSIBILITY REQUIREMENTS ARE GOVERNED BY: CALIFORNIA BUILDING CODE, CHAPTER 11B

NATIONAL FIRE PROTECTION ASSOCIATION, "NFPA 13, AUTOMATIC SPRINKLER SYSTEMS HANDBOOK, 2022 EDITION."

### **SHEET INDEX**

**COVER SHEET** 

TITLE SHEET

SITE CONTEXT PHOTOS 1

SITE CONTEXT PHOTOS 2 BEFORE/AFTER - THEATER SIDE WALL

**BEFORE/AFTER - AUDITORIUM** 

**BEFORE/AFTER - OUTER LOBBY** 

HISTORIC FINISH ANALYSIS - EXTERIOR

PROPOSED EXTERIOR COLOR SCHEME HISTORIC FINISH ANALYSIS - INTERIOR AUDITORIUM

PROPOSED INTERIOR AUDITORIUM COLOR SCHEME

HISTORIC FINISH ANALYSIS - OUTER LOBBY AND INTERIOR LOBBY

HISTORIC FINISH ANALYSIS - PROSCENIUM

**OVERALL SITE PLAN BASEMENT PLAN** 

FIRST FLOOR PLAN

SECOND FLOOR PLAN

**ROOF PLAN** 

WEST EXTERIOR ELEVATION

**EAST EXTERIOR ELEVATION** SOUTH EXTERIOR ELEVATION

NORTH EXTERIOR ELEVATION

**BUILDING SECTION BUILDING SECTION** 

**BUILDING SECTION ENLARGED PLAN - LOBBY** 

**ENLARGED PLAN - LOBBY RCP INTERIOR ELEVATIONS** 

INTERIOR COMPARISON INTERIOR ELEVATIONS

INTERIOR COMPARISON **ENTRY PORTICO ELEVATIONS** 


A8.00 DOOR DETAILS

WINDOW DETAILS

### **PROJECT LOCATION**



### VICINITY MAP

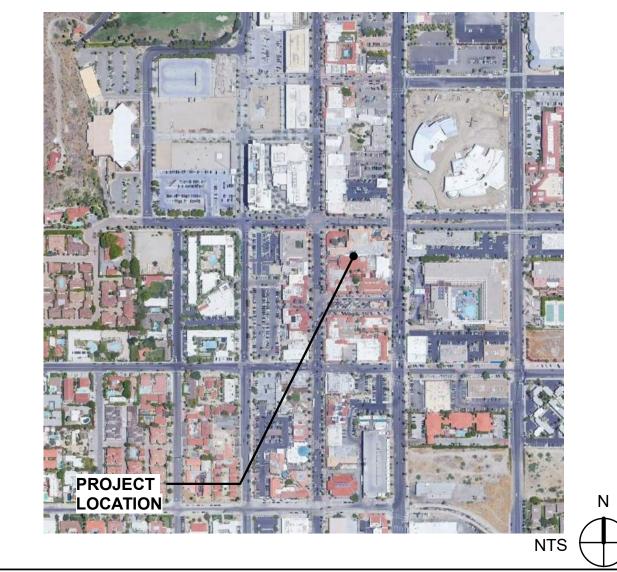



360 E. 2nd Street, Suite 225 Los Angeles, California 90012 626.583.1401

argcreate.com

**DESCRIPTION** 

**REVISIONS** 

DATE

**PLAZA** THEATRE

**REHABILITATION** 

128 S Palm Canyon Dr, Palm Springs, CA 92262

SHEET TITLE

TITLE SHEET

ISSUANCE

**HSPB SUBMITTAL** 

01/27/23

PROJ. NO. 220602


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JC/SD




EAST STREET ELEVATION



WEST STREET ELEVATION

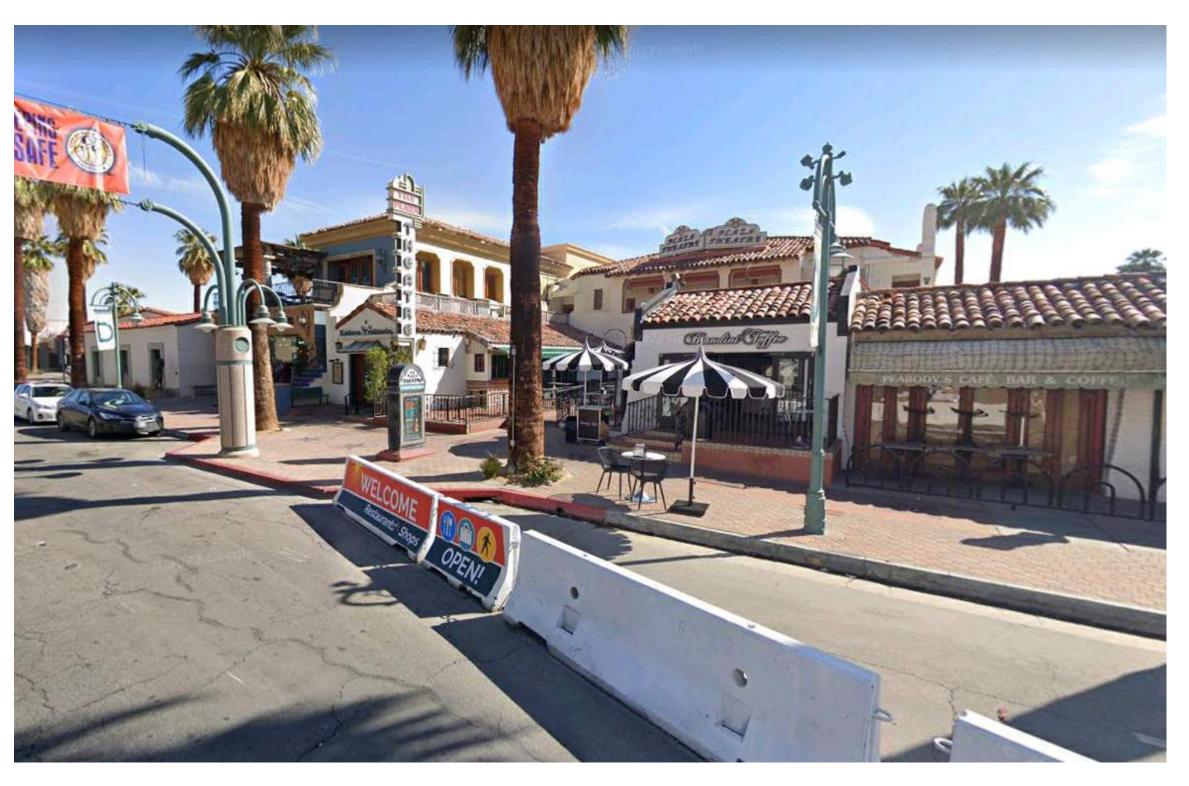

SOUTH STREET ELEVATION

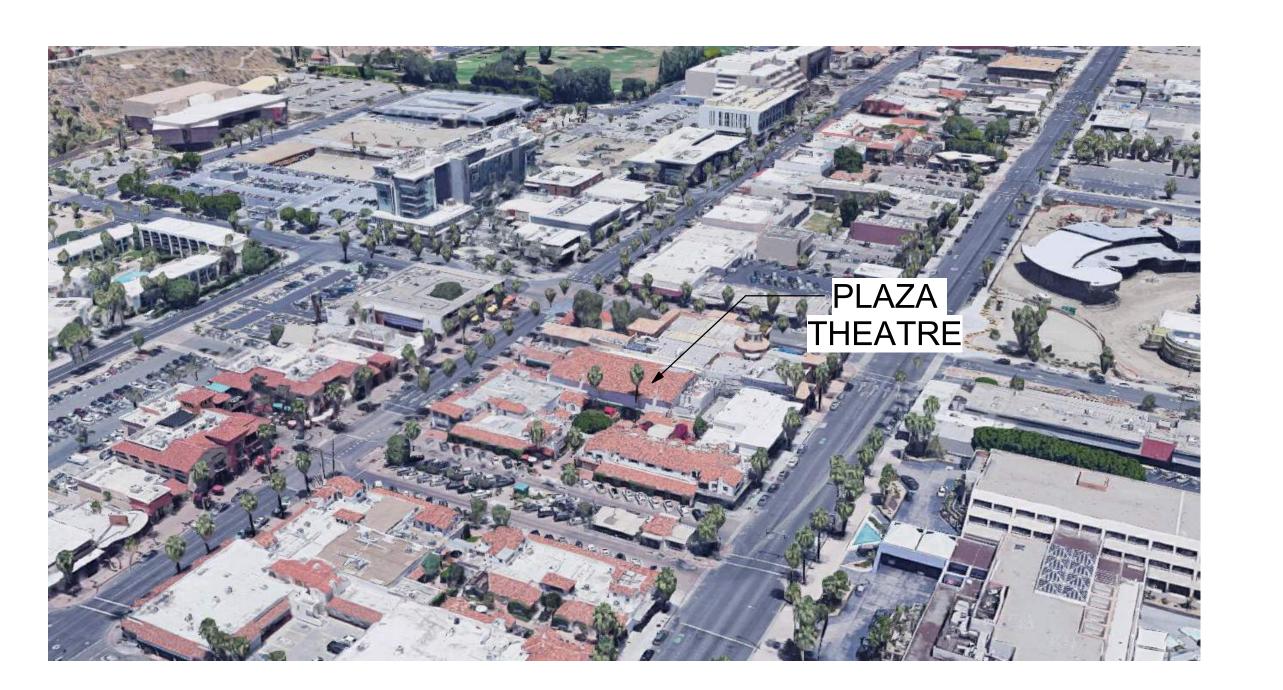

**AERIAL VIEW** 



360 E. 2nd Street, Suite 225 Los Angeles, California 90012 626.583.1401 argcreate.com

NO. DESCRIPTION

**REVISIONS** 

DATE

### PLAZA THEATRE

REHABILITATION

128 S Palm Canyon Dr, Palm Springs, CA 92262

SHEET TITLE

SITE CONTEXT PHOTOS 1

ISSUANCE

HSPB SUBMITTAL

01/27/23


PROJ. NO. 220602


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DRAWING NO.

G2.00





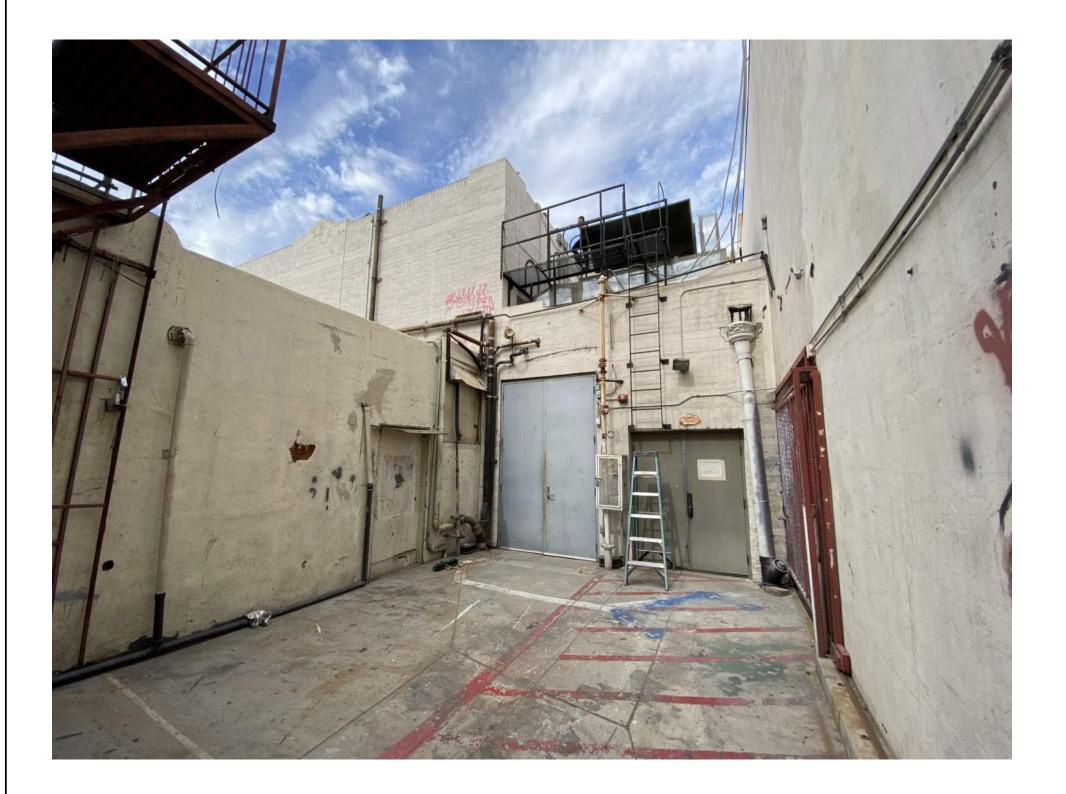

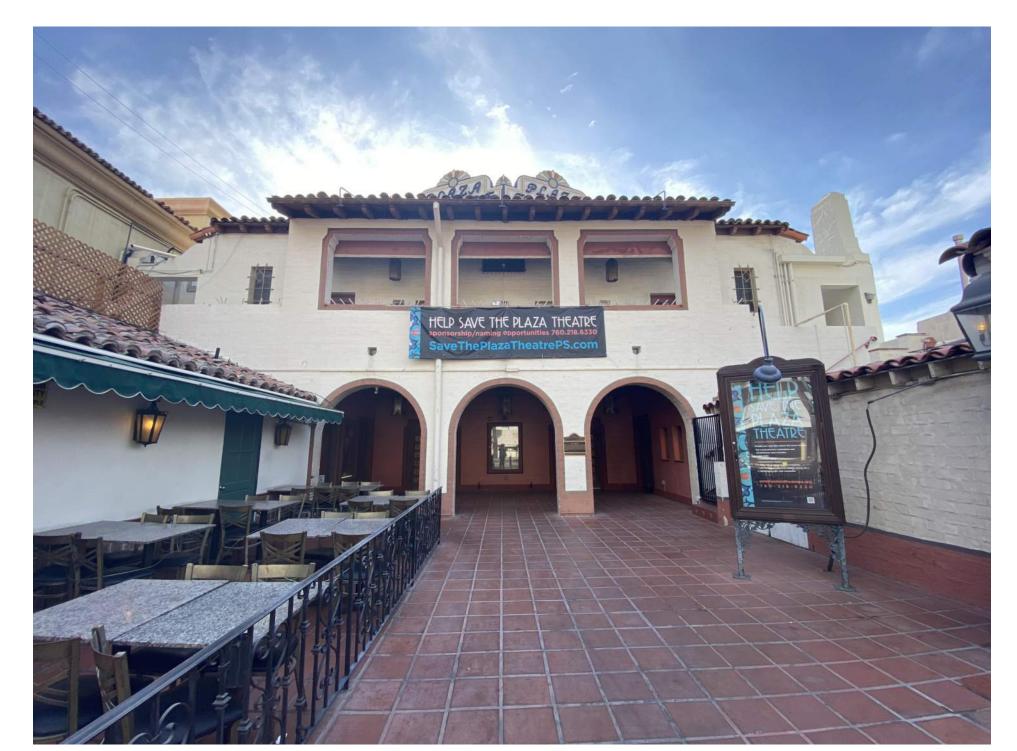**EAST ELEVATION** 





SOUTH ELEVATION



WEST ELEVATION - HISTORIC IMAGE



360 E. 2nd Street, Suite 225 Los Angeles, California 90012 626.583.1401 argcreate.com

DESCRIPTION

REVISIONS

DATE

### PLAZA THEATRE

REHABILITATION

128 S Palm Canyon Dr, Palm Springs, CA 92262

SHEET TITLE

SITE CONTEXT PHOTOS 2

ISSUANCE

HSPB SUBMITTAL

01/27/23

PROJ. NO. 220602

DRAWN

CHECKED

DRAWING NO.

G2.01







1 AUDITORIUM\_EXISTING



Architectural Resources Group

> 360 E. 2nd Street, Suite 225 Los Angeles, California 90012 626.583.1401 argcreate.com

DESCRIPTION REVISIONS

DATE

### PLAZA THEATRE

128 S Palm Canyon Dr, Palm Springs, CA 92262

SHEET TITLE

REHABILITATION

BEFORE/AFTER -AUDITORIUM

ISSUANCE HSPB SUBMITTAL

01/27/23


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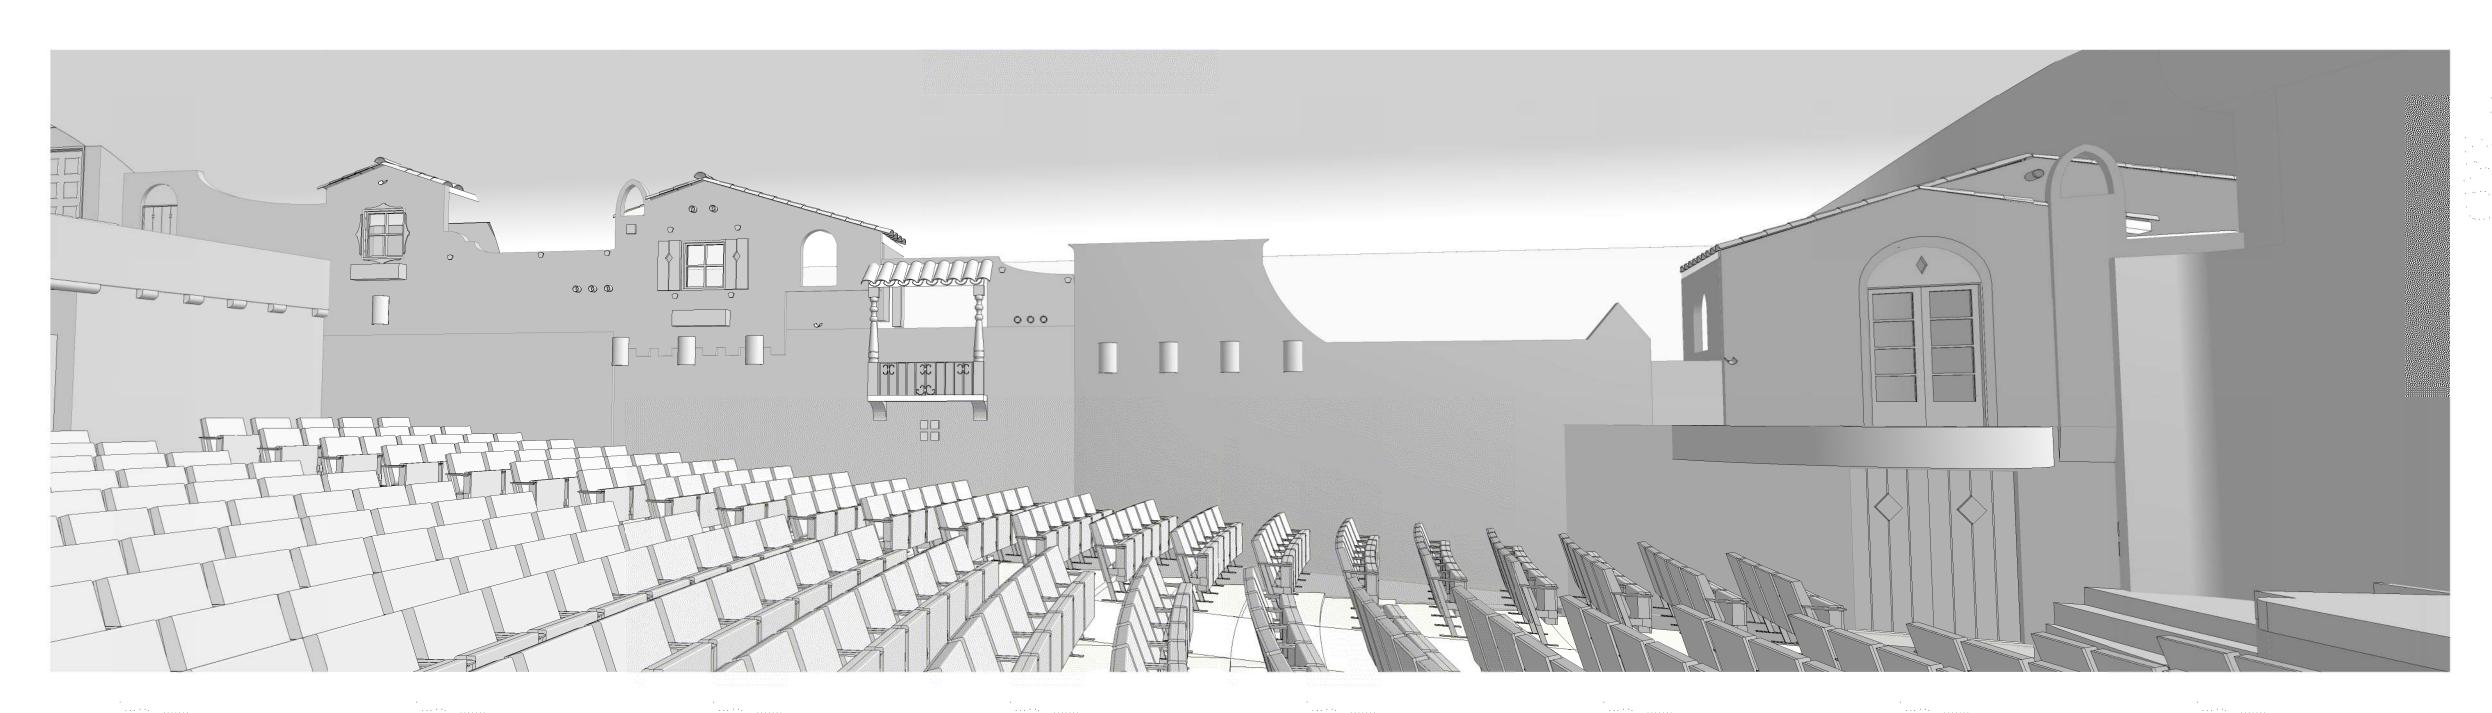
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DRAWING NO.

G3.00



2 NORTH THEATER WALL - PROPOSED REHABILITATION

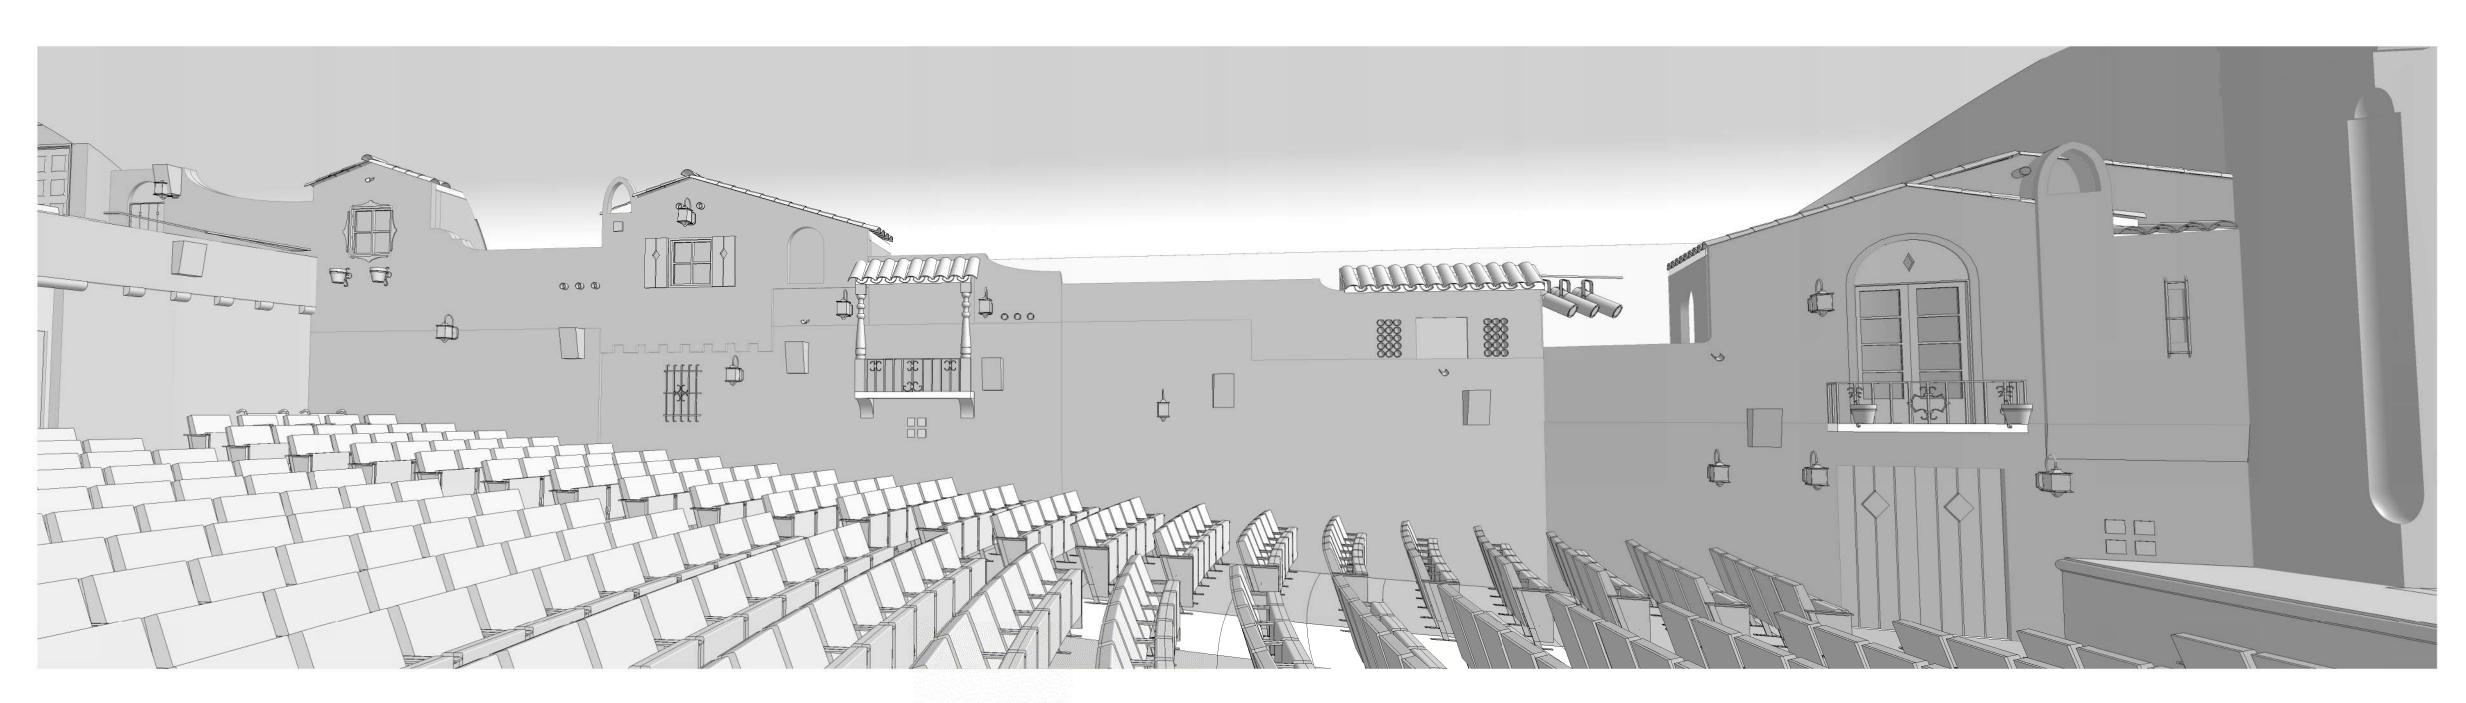

1 NORTH THEATER WALL - EXISTING



360 E. 2nd Street, Suite 225 Los Angeles, California 90012 626.583.1401

NO. DESCRIPTION DATE

REVISIONS

### PLAZA THEATRE

REHABILITATION

128 S Palm Canyon Dr, Palm Springs, CA 92262

SHEET TITLE

BEFORE/AFTER -THEATER SIDE WALL

HSPB SUBMITTAL

ISSUANCE

01/27/23


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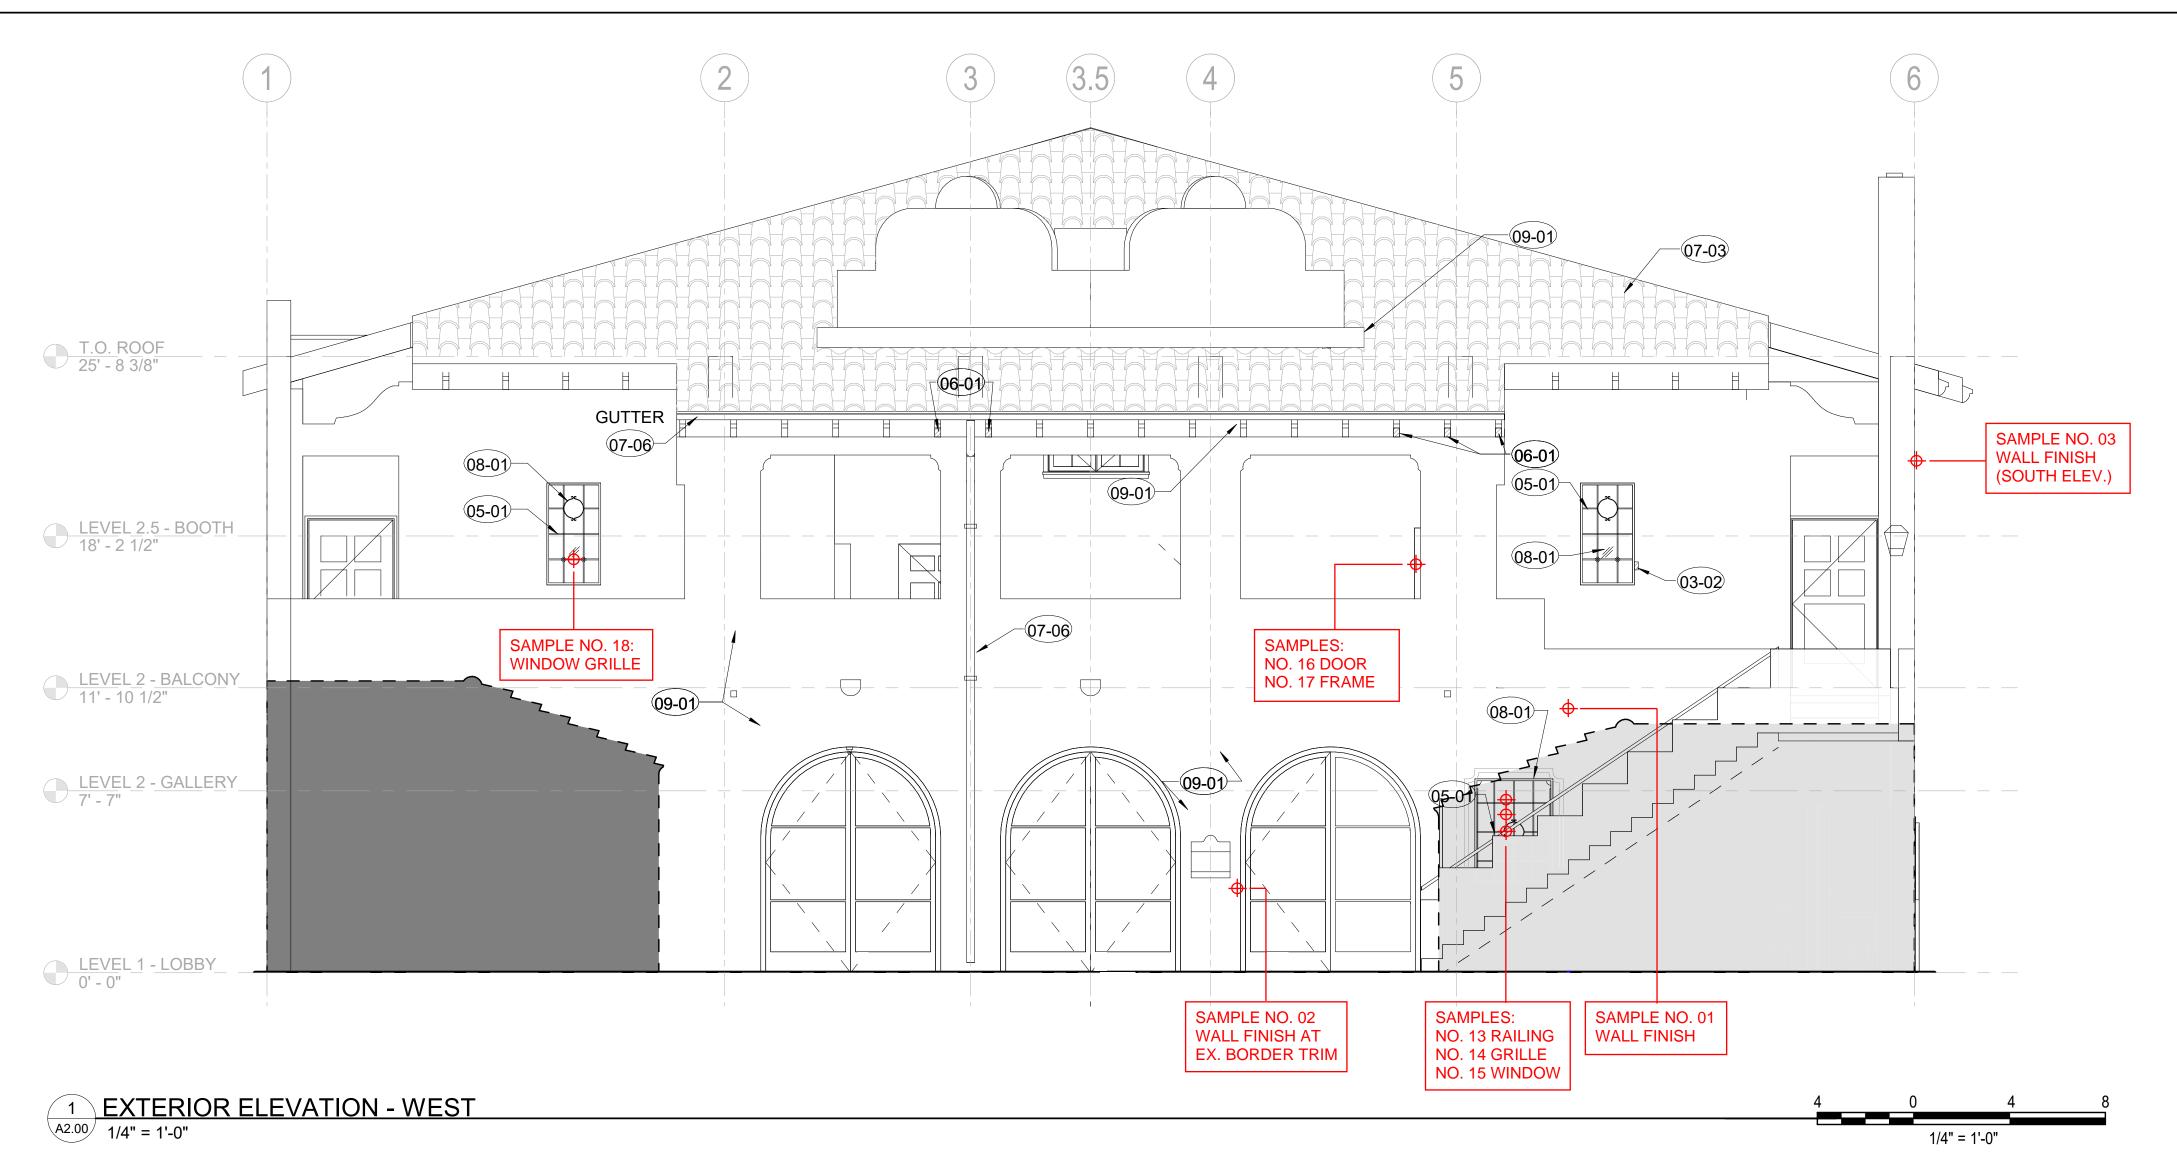
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DRAWING NO.

G3.01





### MICROGRAPHIC IMAGES OF SAMPLES:

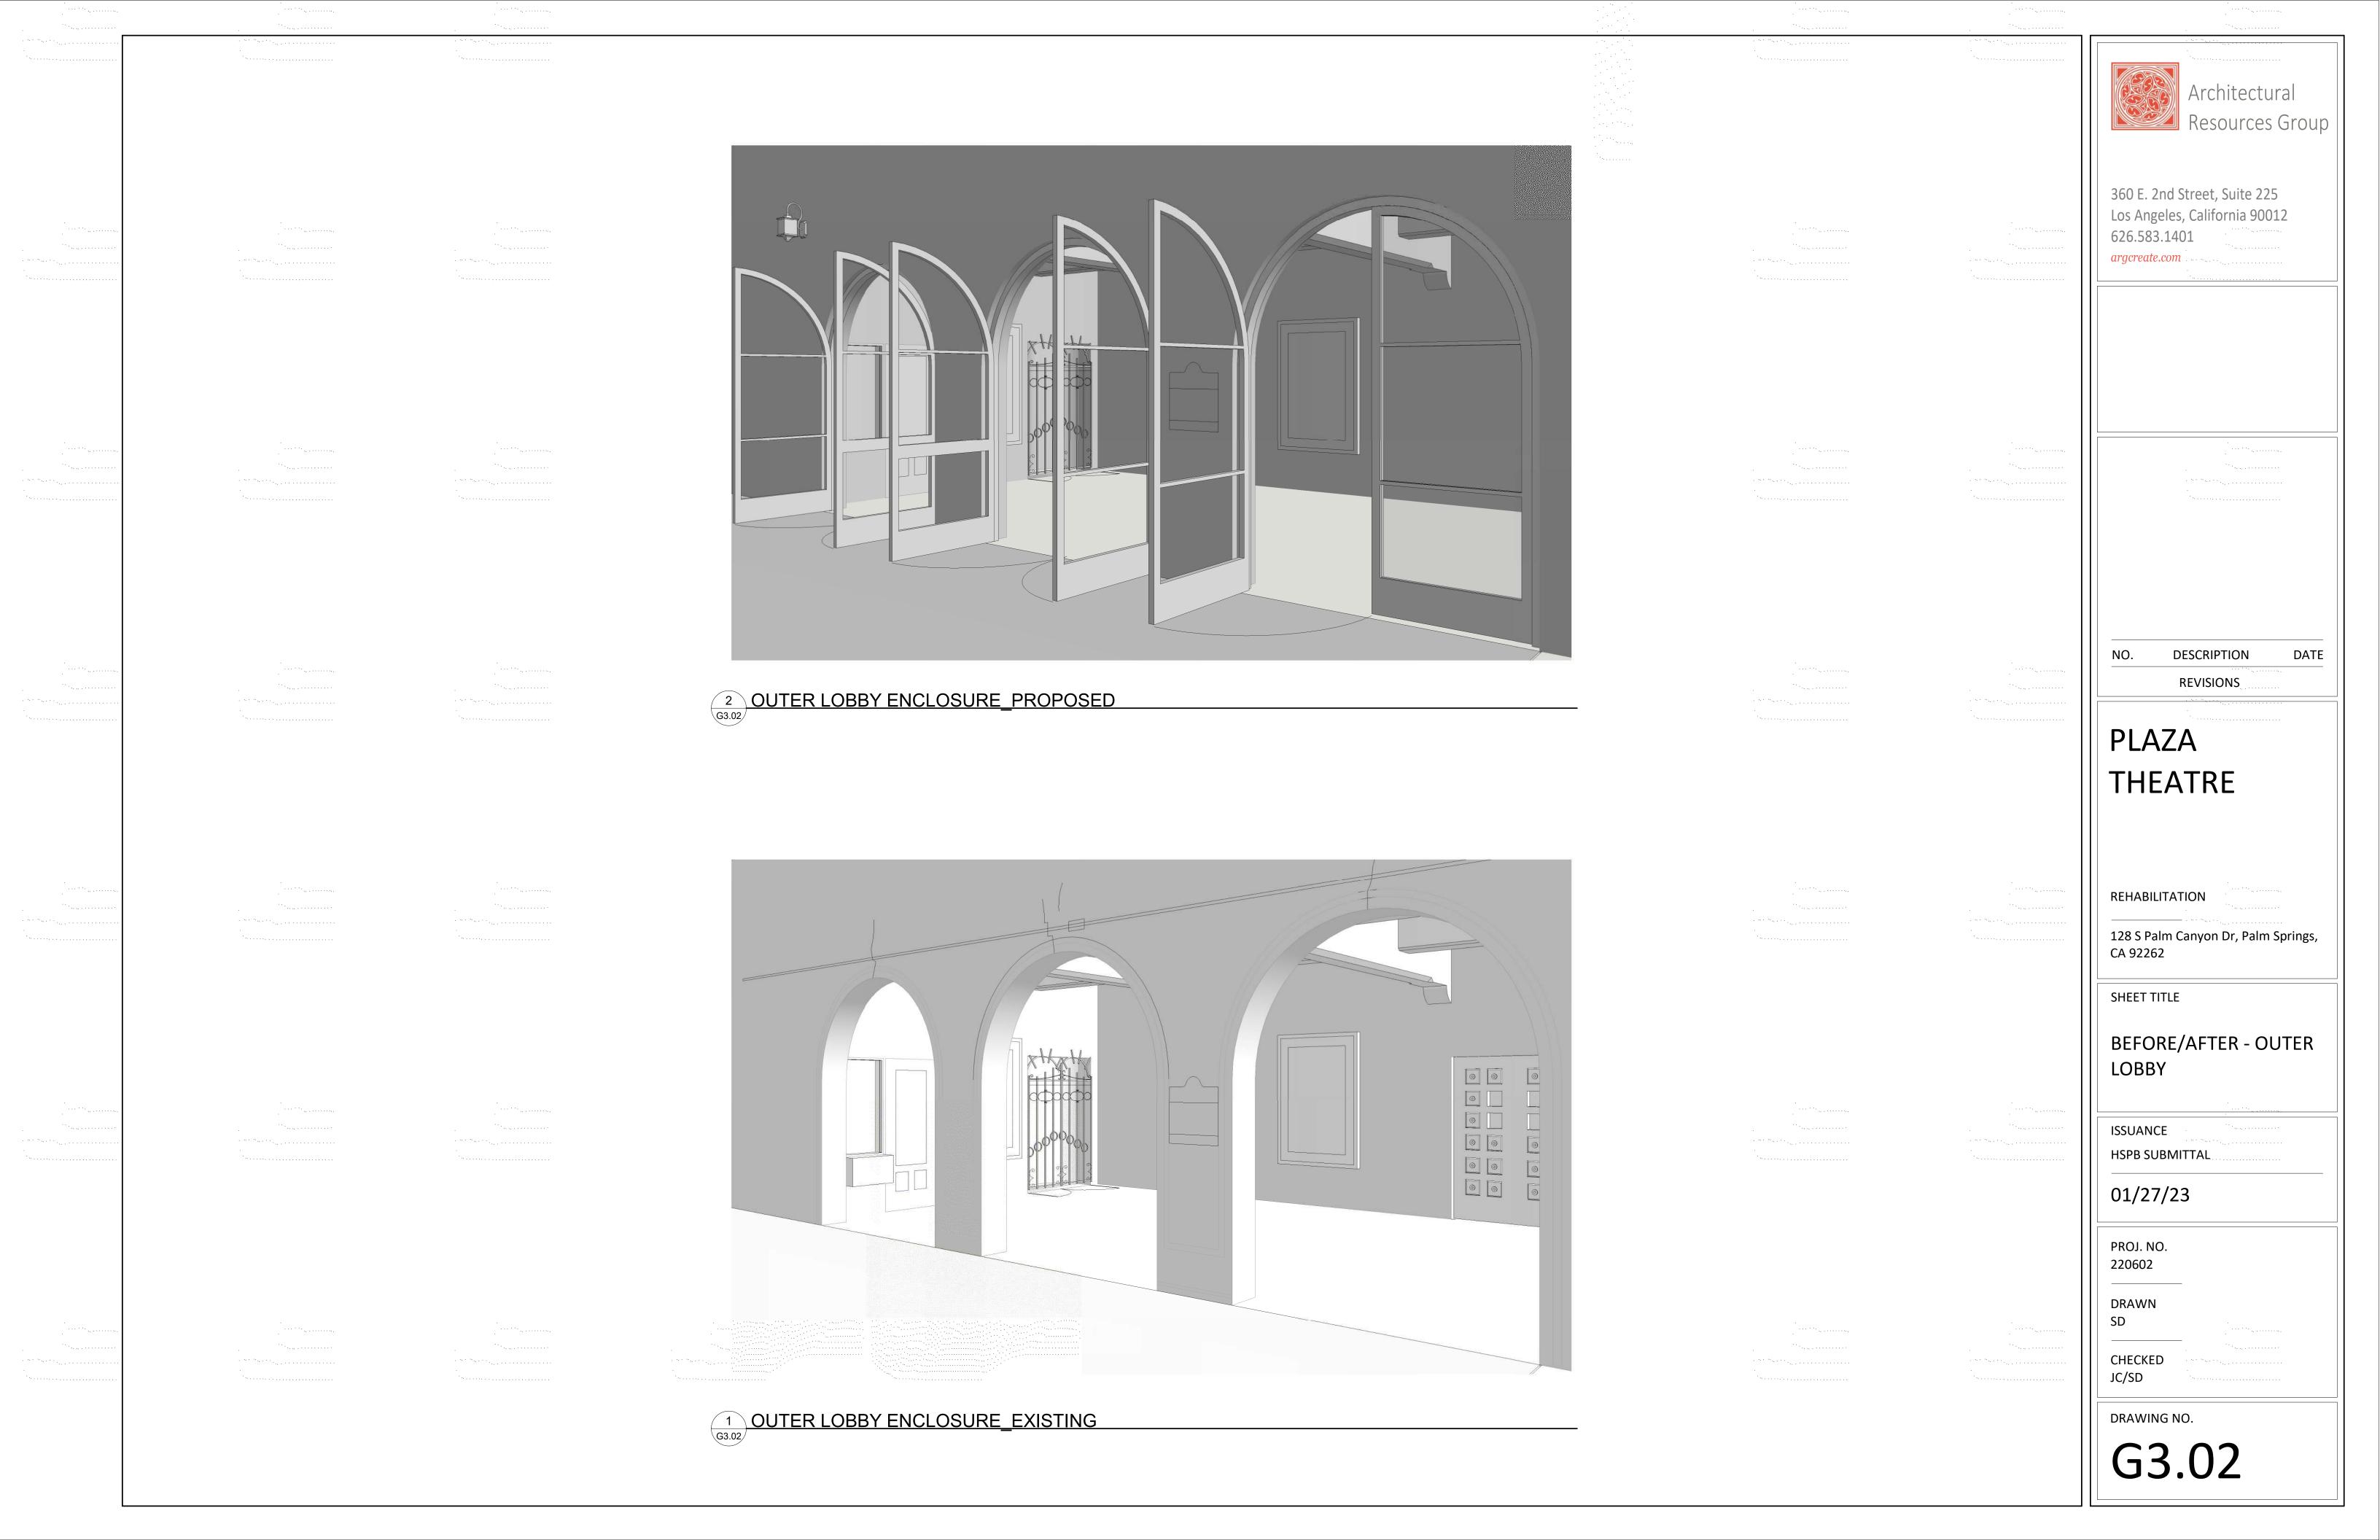

SAMPLE NO. 01 EXTERIOR CONCRETE WALL, WEST ELEVATION

4. (E) OFF-WHITE/CREAM 3. YELLOWISH-WHITE/CREAM 2. WHITE

1. YELLOWISH-WHITE/CREAM

EXTERIOR CONCRETE WALL,

7. DEEP VERMILLION/RED

5. DEEP VERMILLION/RED

3. DEEP VERMILLION/RED

1. YELLOWISH-WHITE/CREAM

WEST ELEV. ARCH BORDER TRIM

SAMPLE NO. 02

6. WHITE

4. WHITE

2. WHITE




SAMPLE NO. 13 METAL RAILING AT EXT. STAIR

7. (E) MODERATE VERMILLION 6. MÓDERATE VERMILLION 5. LIGHT VERMILLION 4. MODERATE VERMILLION

3. LIGHT BROWN 2. BLACK

1. REDDISH-ORANGE (PRIMER)

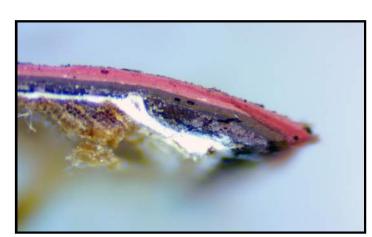

SAMPLE NO. 16 WOOD DOOR 215A

6. (E) MODERATE VERMILLION

5. DÁRK VERMILLION 4. MODERATE VERMILLION 3. MEDIUM BROWN

2. DARK BROWN

1. WHITE (PRIMER)



SAMPLE NO. 14 METAL GRILLE AT WIN. 103A

6. (E) MODERATE VERMILLION 5. MODERATE VERMILLION

4. BLACK 3. BLACK

2. BROWNISH-BLACK 1. REDDISH-ORANGE (PRIMER)



SAMPLE NO. 17 WOOD DOOR FRAME 215A

11. (E) MODERATE VERMILLION 10. MODERATE VERMILLION

9. WHITE 8. MODERATE VERMILLION

7. DARK BROWN 6. WHITE 5. DARK BROWN

4. BLACK

3. WHITE 2. DARK BROWN 1. WHITE (PRIMER)

SAMPLE NO. 18 METAL GRILLE AT WIN. 202

6. (E) MODERATE VERMILLION

5. DARK BROWN 4. WHITE

WHITE 2. BROWNISH-BLACK 1. REDDISH-ORANGE (PRIMER)

### HISTORIC PHOTOGRAPH



Source: Palm Springs Historical Society.

### **RECOMMENDED EXTERIOR PAINT COLORS:**



**DUNN-EDWARDS** DET660 NATURAL RADIANCE FOR EXTERIOR WALLS



SHERWIN-WILLIAMS SW2808 ROOKWOOD DARK BROWN FOR EXT WOOD DOORS, RAFTERS AND TRIM



TNEMEC 86BR DARK BRONZE FOR EXT. METAL WINDOWS, GRILLES AND RAILINGS



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### PLAZA **THEATRE**

**REHABILITATION** 

128 S Palm Canyon Dr, Palm Springs, CA 92262

SHEET TITLE

HISTORIC FINISH ANALYSIS - EXTERIOR

ISSUANCE

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SAMPLE NO. 03 EXTERIOR CONCRETE WALL, WEST ELEVATION

2. (E) OFF-WHITE/CREAM 1. YÉLLOWISH-WHITE/CREAM



SAMPLE NO. 15 STEEL SASH AT WIN. 103A

8. (E) OFF-WHITE/CREAM 7. OFF-WHITE/CREAM 6. WHITE

5. YELLOW 4. WHITE

3. YELLOWISH-WHITE/CREAM 2. BROWNISH-BLACK 1. REDDISH-ORANGE (PRIMER)





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SHEET TITLE

# PROPOSED EXTERIOR COLOR SCHEME

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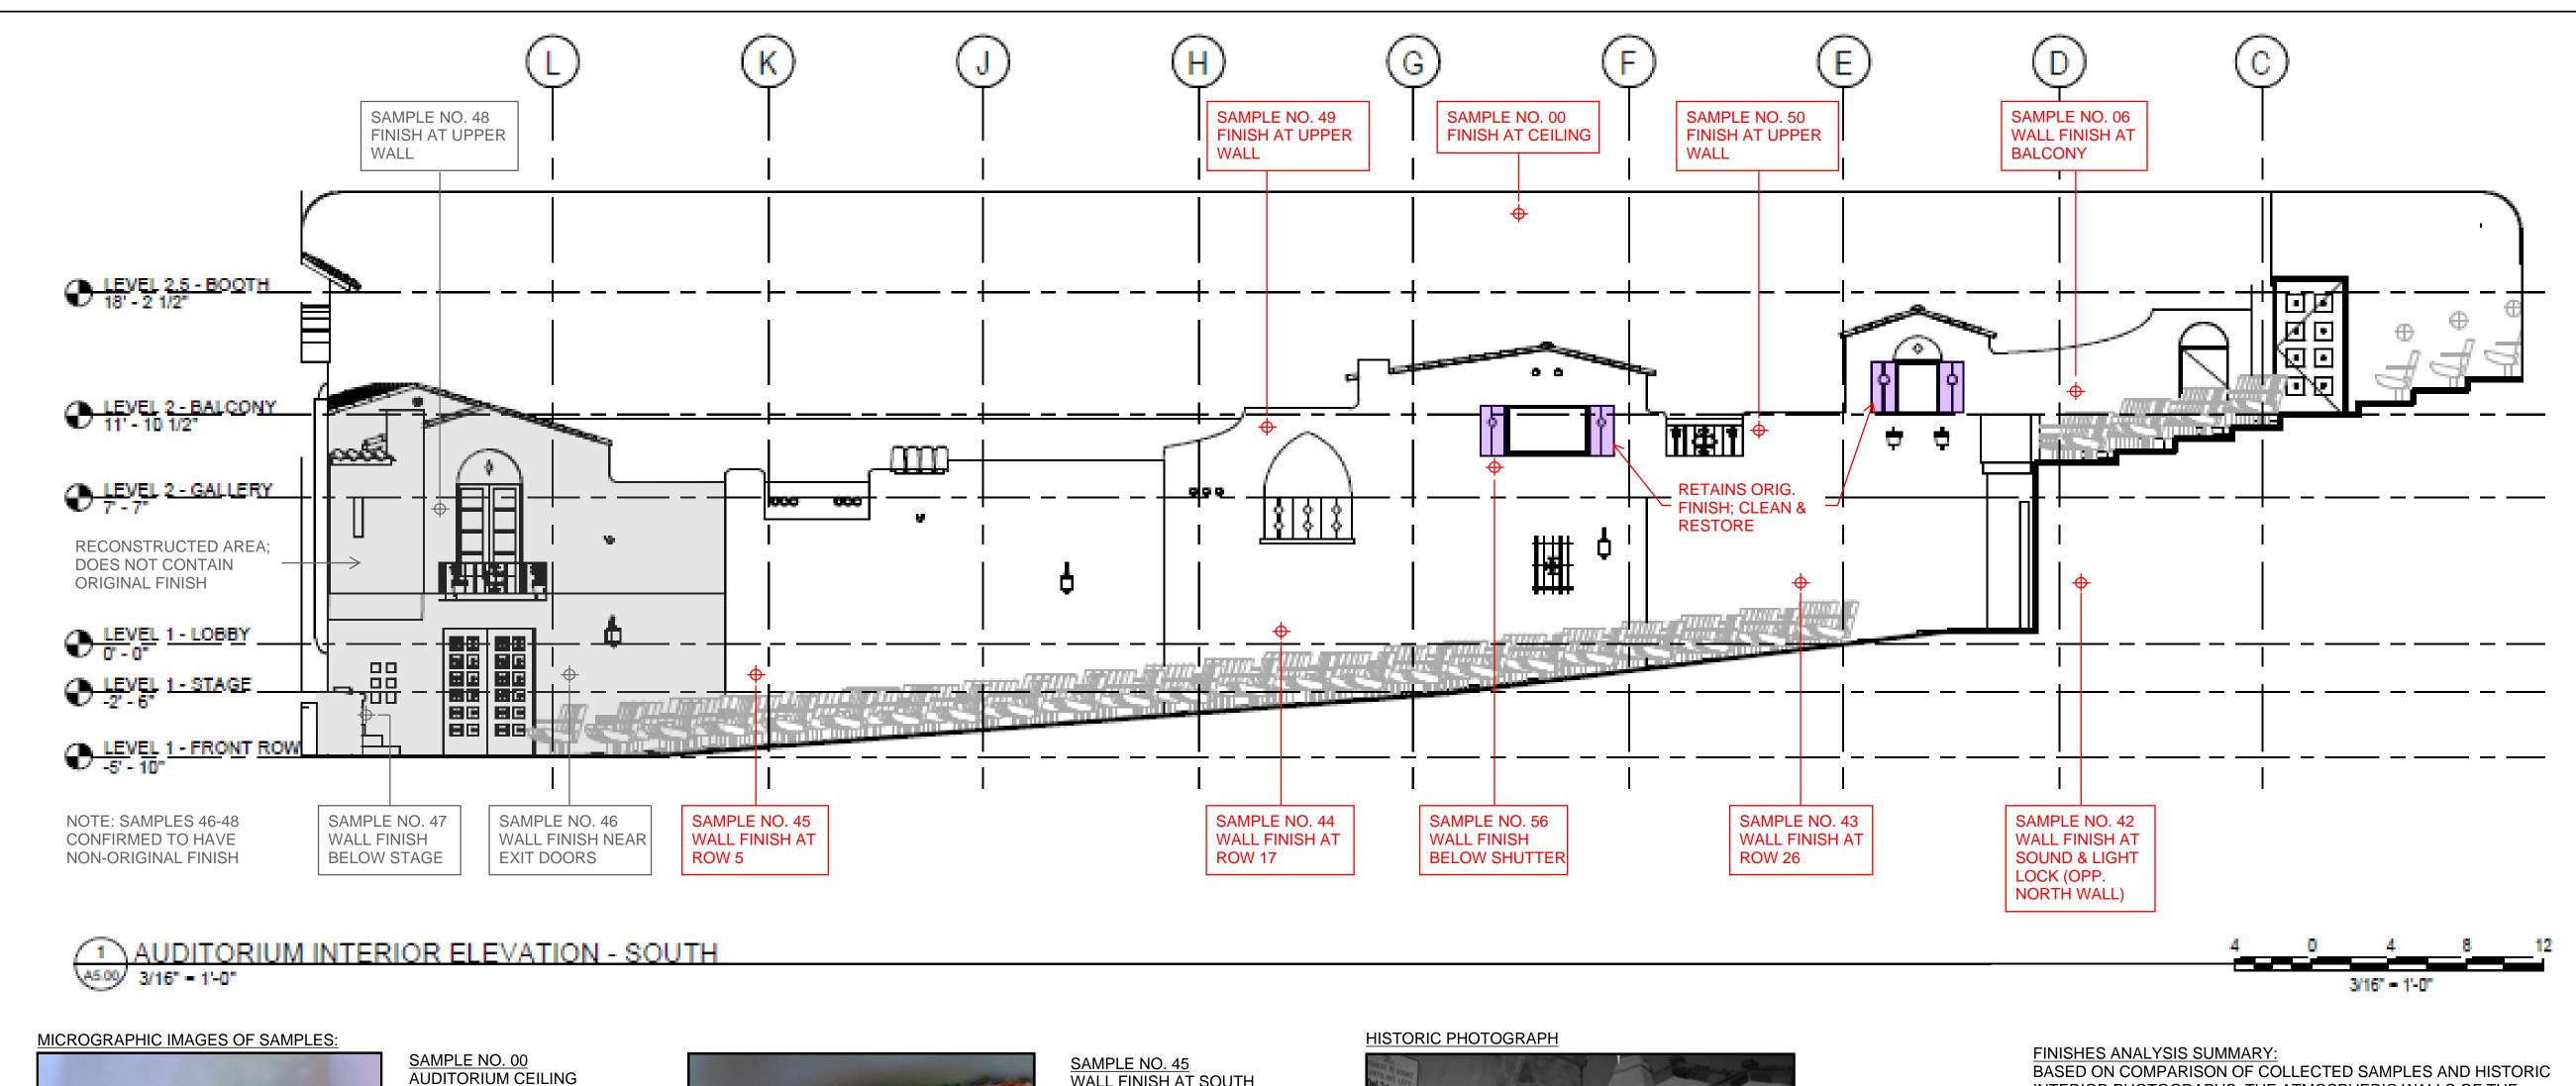
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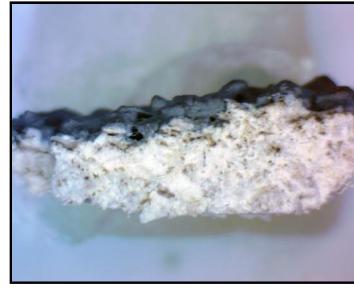
SD

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DRAWING NO.

G4.01





(COLLECTED FROM ATTIC)

1. BLUISH-GRAY (SOILED)

SAMPLE NO. 43

AT ROW 26

3. LIGHT PINK

WALL FINISH AT SOUTH

5. MODERATE VERMILLION

2. LIGHT YELLOW OCHRE

4. YELLOWISH-WHITE/CREAM

1. YELLOWISH-WHITE/CREAM

ATMOSPHERIC WALL



SAMPLE NO. 45 WALL FINISH AT SOUTH ATMOSPHERIC WALL, AT ROW 26

10. MODERATE VERMILLION

9. DARK YELLOW OCHRE 8. DARK PINK

7. LIGHT PINK

6. MEDIUM PINK 5. LIGHT PINK

4. DARK PINK

3. LIGHT PINK

2. MEDIUM PINK

1. YELLOWISH-WHITE/CREAM



SAMPLE NO. 49 WALL FINISH AT SOUTH ATMOSPHERIC WALL AT UPPER WALL NEAR CENTER


5. MODERATE VERMILLION 4. YELLOWISH-WHITE/CREAM

3. LIGHT YELLOW OCHRE

2. MEDIUM YELLOW OCHRE

1. YELLOWISH-WHITE/CREAM



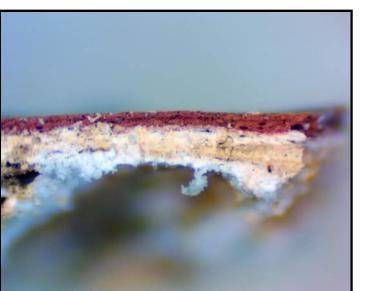


SAMPLE NO. 44 WALL FINISH AT SOUTH ATMOSPHERIC WALL AT ROW 17

9. MODERATE VERMILLION 8. YELLOWISH-WHITE/CREAM 7. LIGHT PINK

6. YELLOWISH-WHITE/CREAM 5. DARK YELLOW OCHRE 4. MEDIUM YELLOW OCHRE

3. DARK YELLOW OCHRE

2. MEDIUM YELLOW OCHRE 1. YELLOWISH-WHITE/CREAM

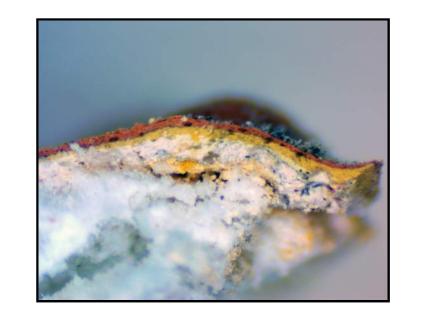


SAMPLE NO. 50 WALL FINISH AT SOUTH ATMOSPHERIC WALL AT UPPER WALL NEAR BALCONY

6. MODERATE VERMILLION 5. DARK YELLOW OCHRE

4. LIGHT YELLOW OCHRE 3. YELLOWISH-WHITE/CREAM

2. DARK YELLOW OCHRE 1. YELLOWISHOWHITE/CREAM

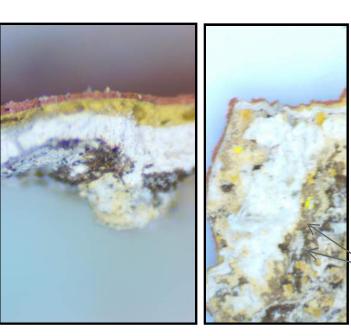

SAMPLE NO. 56 WALL FINISH AT SOUTH ATMOSPHERIC WALL **BELOW SHUTTER** 

NOTE SINGLE OVERALL BODY

NOTE ACCENT

COLOR TO

WEATHERED

**APPEARANCE** 

PROVIDE

COLOR

5. MODERATE VERMILLION 4. MEDIUM YELLOW OCHRE

3 YELLOWISH-WHITE/CREAM 2. MED. BROWN/ DK. BROWN 1. YELLOWISH-WHITE/CREAM

> SAMPLE VERSO; NOTE TWO BROWN ACCENT COLORS

INTERIOR PHOTOGRAPHS, THE ATMOSPHERIC WALLS OF THE AUDITORIUM WERE HISTORICALLY PAINTED AN OVERALL COLOR IN YELLOWISH-WHTE/CREAM. THERE WERE ALSO ACCENTS IN VARIOUS BROWN HUES TO PROVIDE SHADOWING AND AN AGED OR WEATHERED APPEARANCE.

AT SOME POINT, THE WALLS WERE REPAINTED IN A MULT-COLORED SCHEME USING A RANGE OF GOLDS, PINKS AND BLUE/GRAY COLORS. BASED ON PHOTOS FROM 2014, THE OVERALL EFFECT WAS HEAVY-HANDED. LATER, THE WALLS WERE AGAIN REPAINTED IN THE CURRENT PINK/VERMILLION COLOR.

SOME ELEMENTS, SUCH AS THE WOODEN SHUTTERS, RETAIN THEIR ORIGINAL FINISH. THE PLASTER CEILING ALSO RETAINS THE ORIGINAL FINISH. HOWEVER, IT IS HEAVILY SOILED AND ALTERED (LARGE CUT-OUTS FOR LIGHTING, ETC.)

**RECOMMENDATIONS:** 

ATMOSPHERIC WALLS SHOULD BE REPAIRED AND REPAINTED IN AN OVERALL YELLOWISH-WHITE/CREAM COLOR, WITH BROWN-TONED ACCENTS TO PROVIDE AN AGED/ WEATHERED APPEARANCE. CLEAN AND RESTORE THE ORIGINAL FINISH AT WOOD SHUTTERS, WOOD WINDOWS, AND OTHER ORIGINAL REMAINING DETAILS. REPAIR AND REPAINT THE EXISTING PLASTER CEILING IN A MATCHING SOLID GRAY COLOR. DEPENDING ON THE DESIRED EFFECT AND ARCHITECTURAL LIGHTING CONDITIONS, WE MAY ELECT TO IMITATE MORE CLOSELY THE NIGHT SKY, INCLUDING MORE DARK BLUE TONES OVERHEAD AND ROSY/ SUNSET TONES OVER THE ATMOSPHERIC WALLS.

RECOMMENDED PAINT COLORS FOR AUDITORIUM NOTE: SEE HISTORIC PHOTOS FOR DECORATIVE TREATMENT



WALL BODY COLOR: SHERWIN-WILLIAMS **SW7537 IRISH CREAM** 

WALL ACCENT COLOR: SW6102 PORTOBELLO

WALL ACCENT COLOR: SW6103 TEA CHEST

**CEILING COLOR: DUNN-EDWARDS** DE6369 LEGENDARY GRAY



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### **PLAZA THEATRE**

**REHABILITATION** 

128 S Palm Canyon Dr. Palm Springs. CA 92262

SHEET TITLE

HISTORIC FINISH ANALYSIS - INTERIOR **AUDITORIUM** 

**ISSUANCE** 

**HSPB SUBMITTAL** 

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AUDITORIUM INTERIOR - PROPOSED REHABILITATION



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### PLAZA THEATRE

REHABILITATION

128 S Palm Canyon Dr, Palm Springs, CA 92262

SHEET TITLE

PROPOSED INTERIOR AUDITORIUM COLOR SCHEME

ISSUANCE

HSPB SUBMITTAL

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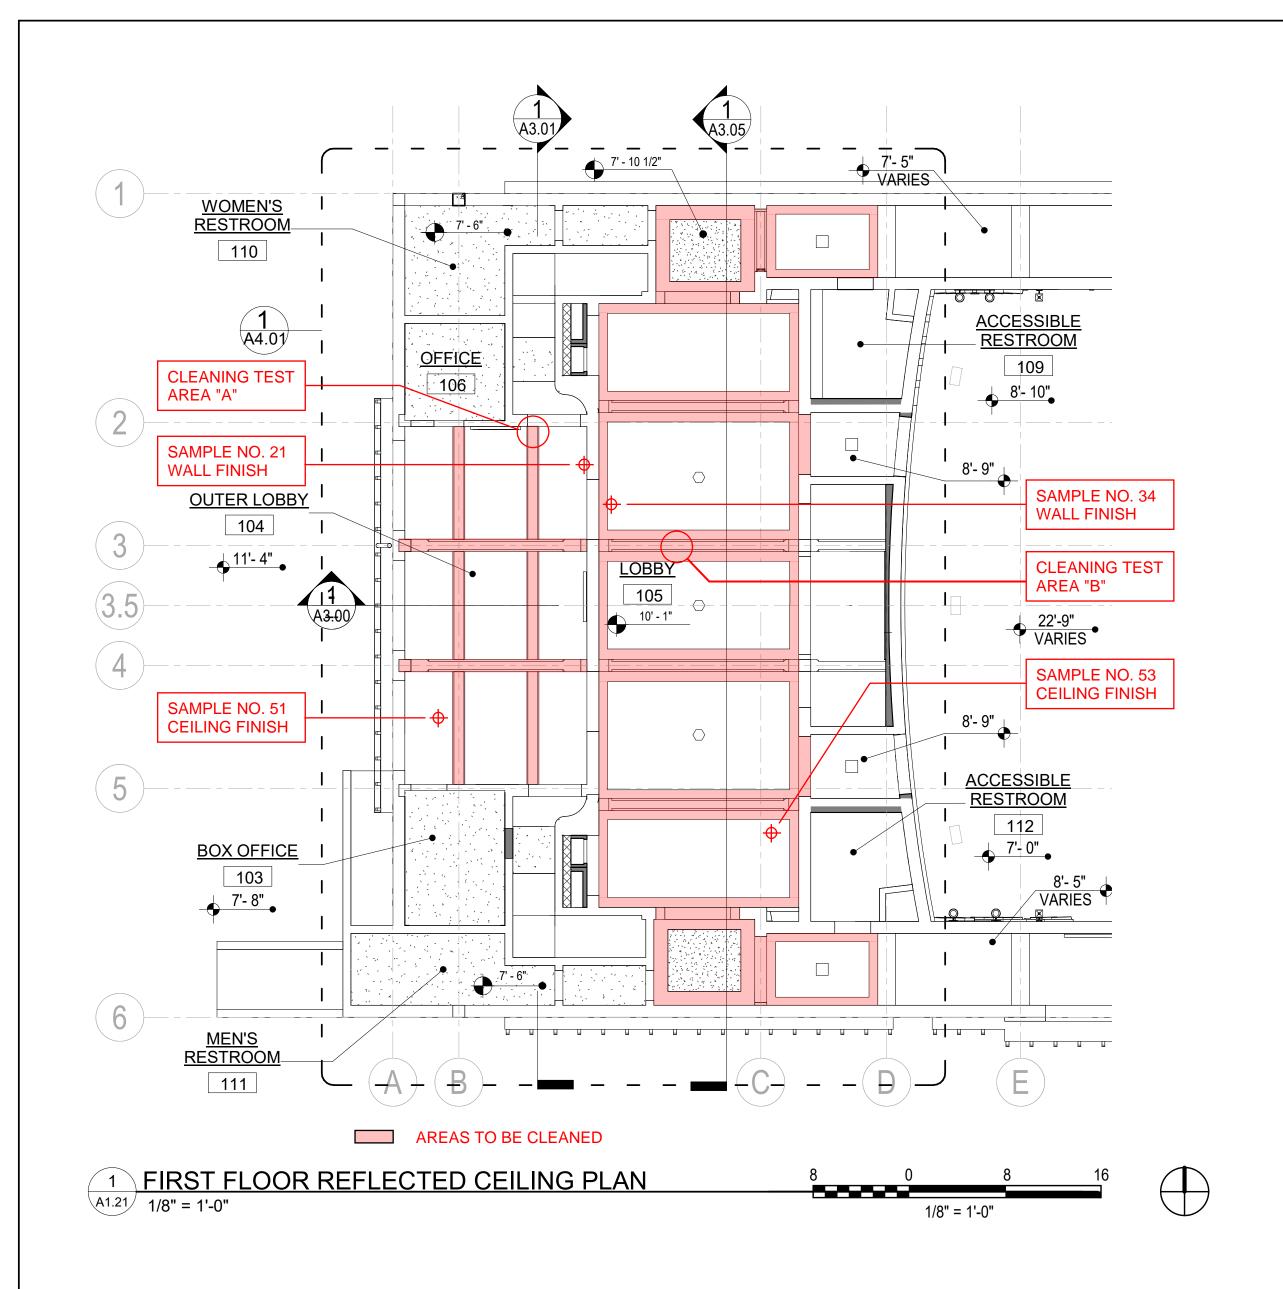
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G4.03



#### CLEANING TEST AREA "A" AT OUTER LOBBY

#### **BEFORE CLEANING**





**CLEANING TEST SUMMARY:** EXTERIOR BEAMS AND CORBELS AT OUTER LOBBY ARE CAST-IN-PLACE REINFORCED CONCRETE WITH BOARD FORM FINISH. SURFACES ARE DECORATIVELY PAINTED TO IMITATE WOOD, AND INCLUDE MULTI-COLORED STENCIL-LIKE DESIGNS. CURRENTLY, SURFACES ARE SOILED AND STAINED, AND PAINT

BASED ON SOLVENT SOLUBILITY TESTING, PAINTS ARE SOLUBLE IN WATER AND INORGANIC SOLVENTS. THE MOST SUCCESSFUL CLEANING METHOD WAS PERFORMED WITH DILUTE SOLUTION OF VULPEX LIQUID SOAP IN MINERAL SPIRITS (1:6 v/v). THE SOLUTION CLEANED THE SURFACES AND RE-SATURATED SOME OF THE PAINT COLORS. SOME LOCALIZED IN-PAINTING WILL ALSO BE REQUIRED.

COLORS ARE FADED.

#### CLEANING TEST AREA "B" AT INTERIOR LOBBY





**CLEANING TEST SUMMARY:** INTERIOR BEAMS AT LOBBY ARE CAST-IN-PLACE REINFORCED CONCRETE WITH BOARD FORM FINISH. SURFACES ARE DECORATIVELY PAINTED TO IMITATE WOOD, AND INCLUDE MULTI-COLORED STENCIL-LIKE DESIGNS. CURRENTLY, SURFACES ARE SOILED AND STAINED, AND PAINT COLORS ARE FADED.

BASED ON SOLVENT SOLUBILITY TESTING, PAINTS ARE NOT SOLUBLE IN WATER OR A RANGE OR INORGANIC AND ORGANIC SOLVENTS. MANY OF THE DETERGENTS AND SOLVENTS TESTED CLEANED THE SURFACE BUT DID NOT RESATURATE COLORS. THE MOST SUCCESSFUL CLEANING METHOD USED A PROPRIETARY CLEANER, "KOTTON KLENSER" CLEANER AND OIL PAINTING RESTORING OIL. SOME LOCALIZED IN-PAINTING WILL ALSO BE NECESSARY TO MINIMIZE STAINS.

#### MICROGRAPHIC IMAGES OF SAMPLES:



SAMPLE NO. 21 **OUTER LOBBY WALLS -**BORDER TRIM AT OPGS (WALL SAMPLE SIM.)


- 6. DARK RED 5. DARK PURPLE
- 4. MODERATE VERMILLION 3. YELLOWISH-WHITE/CREAM 2. WHITE (PRIMER)
- 1. YELLOWISH-WHITE/CREAM

**BORDER TRIM AT OPENINGS** IS NOT ORIGINAL. WALLS WERE HISTORICALLY PAINTED ALL ONE COLOR



SAMPLE NO. 51 **OUTER LOBBY CEILING -BORDER TRIM** (CLG. FIELD SAMPLE SIM.)

- 5. DARK PURPLE 4. MODERATE VERMILLION 3. YELLOWISH-WHITE/CREAM 2. WHITE (PRIMER) 1. YELLOWISH-WHITE/CREAM
- BORDER TRIM AT CEILING IS NOT ORIGINAL. CEILINGS BETWEEN BEAMS WERE HISTORICALLY PAINTED ALL ONE COLOR

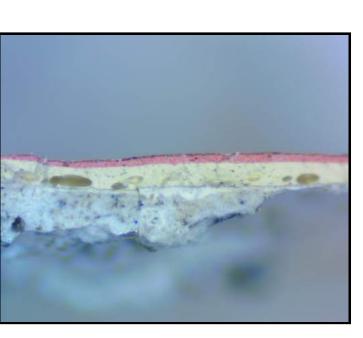

SAMPLE NO. 34 **INTERIOR LOBBY WALLS -**


- 4. LIGHT VERMILLION (PINK) 3. YELLOWISH CREAM
- 2. WHITE (PRIMER) 1. YELLOWISH-WHITE/CREAM

SAMPLE NO. 53 **INTERIOR LOBBY CEILING -**LOWERED PLASTER CLG. (MAIN CLG. SAMPLE SIM.)

### 1. LIGHT BLUE

CEILING FIELD COLOR IS ORIGINAL. HOWEVER DUE TO BUILDING SYSTEMS RENOVATIONS, CEILINGS MUST BE REPAINTED.

### **RECOMMENDED PAINT COLORS:**

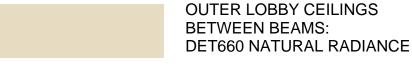

INTERIOR LOBBY WALLS: SW7537 IRISH CREAM



INTERIOR LOBBY CEILINGS **BETWEEN BEAMS:** DE5801 SILVER SKATE

### RECOMMENDED CLEANING REGIMEN:

OUTER LOBBY CEILING BEAMS AND CORBELS WILL BE CLEANED WITH A DILUTE SOLUTION OF VULPEX LIQUID SOAP IN MINERAL SPIRITS (1:6 v/v). AREAS OF PAINT LOSS AND STAINS THAT REMAIN AFTER CLEANING WILL BE VISUALLY INTEGRATED WITH LOCALIZED IN-PAINTING TO MATCH SURROUNDING SURFACES.

INTERIOR LOBBY CEILING BEAMS WILL BE CLEANED WITH "KOTTON KLENSER" CLEANER AND OIL PAINTING RESTORING OIL. AGAIN, AREAS OF PAINT LOSS AND STAINS THAT REMAIN WILL BE IN-PAINTED.



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### **PLAZA THEATRE**

### **REHABILITATION**

128 S Palm Canyon Dr, Palm Springs, CA 92262

### SHEET TITLE

HISTORIC FINISH ANALYSIS - OUTER LOBBY AND INTERIOR LOBBY

ISSUANCE


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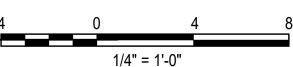
PROJ. NO. 220602

DRAWN

CHECKED JC/SD



1 AUDITORIUM TRANSVERSE SECTION A3.03 / 1/4" = 1'-0"

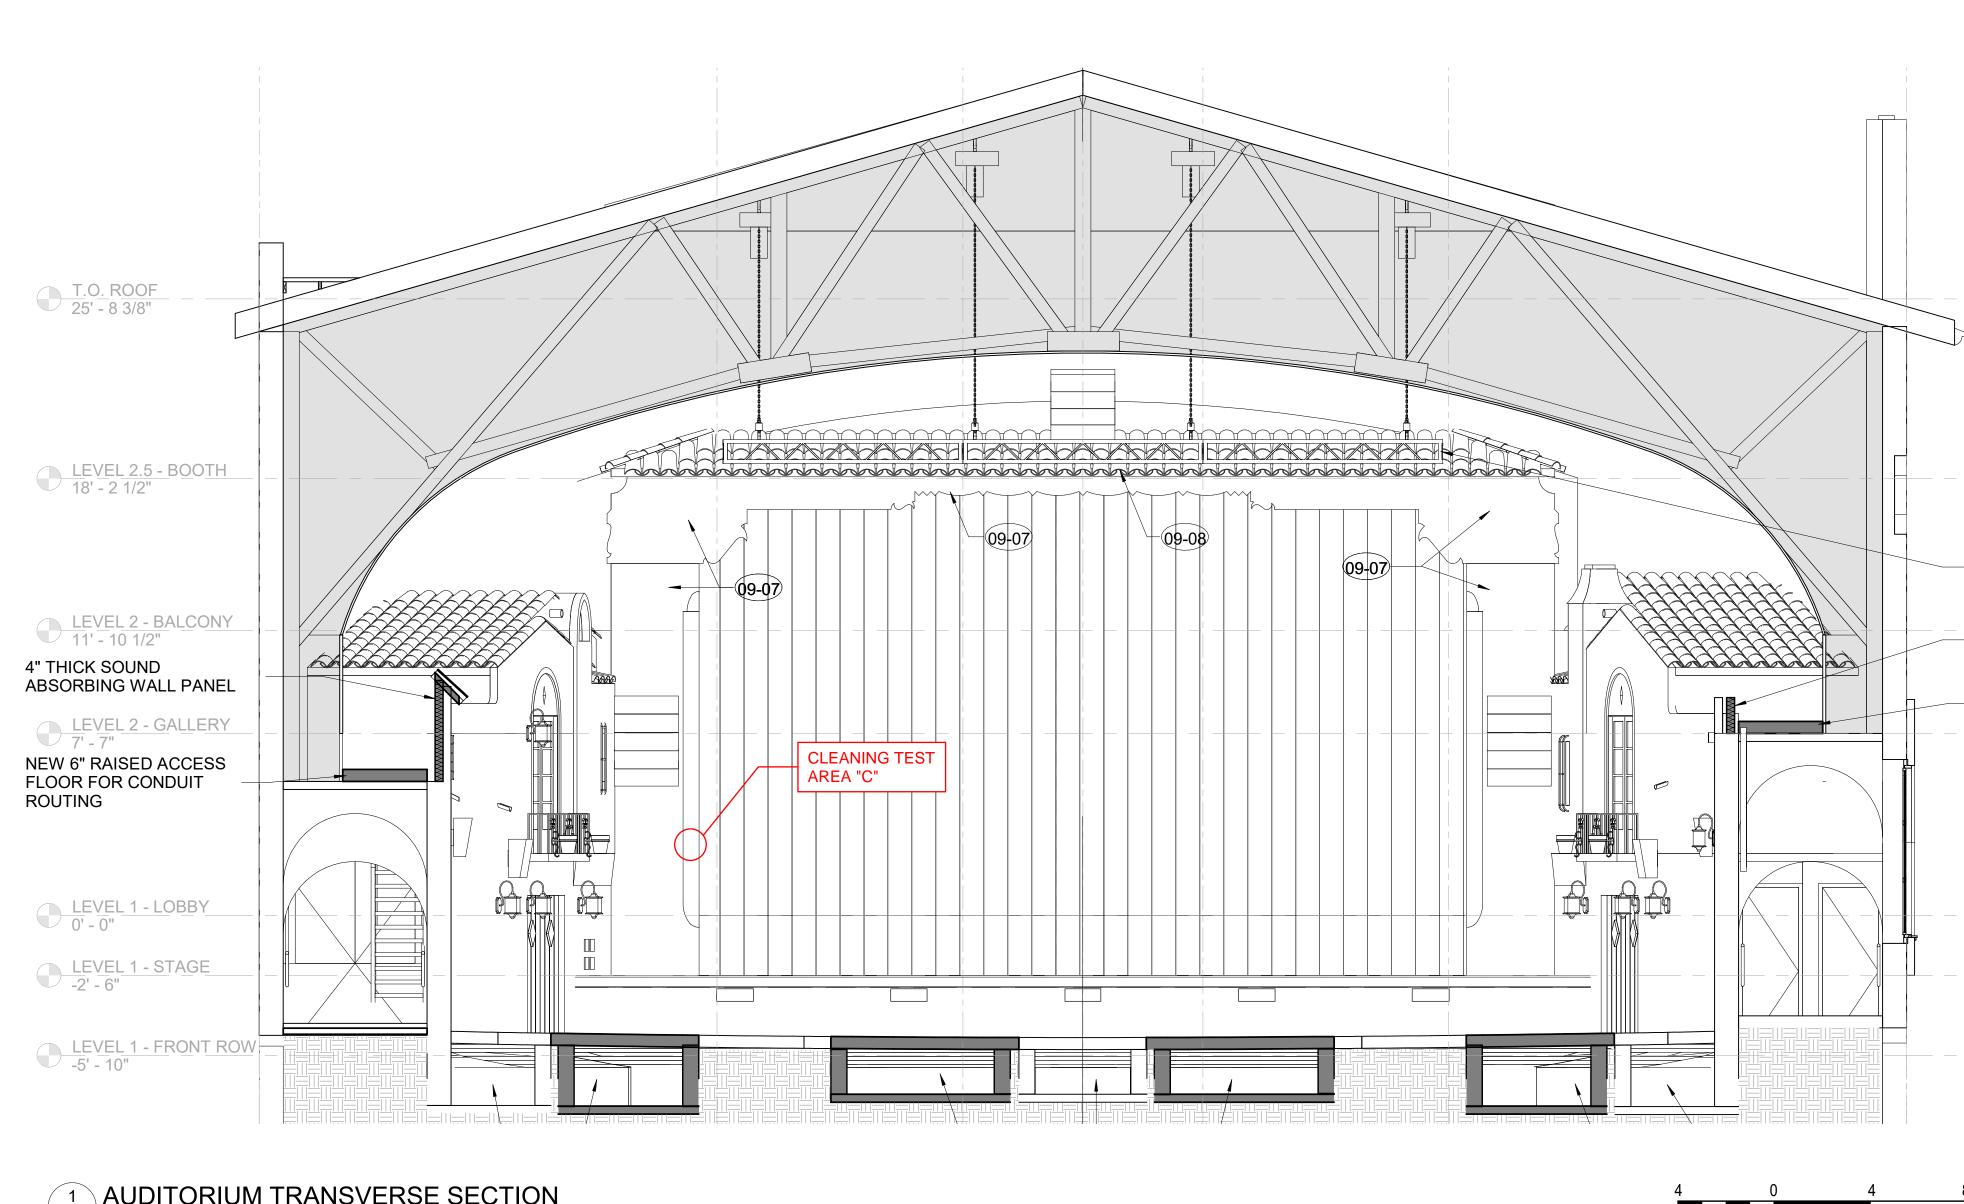

### **HISTORIC PHOTOGRAPH**



Source: Palm Springs Historical Society.

### CLEANING TEST AREA "C" AT PROSCENIUM



BEFORE CLEANING



AFTER CLEANING

**CLEANING TEST SUMMARY:** THE STAGE PROSCENIUM IS COMPRISED OF CAST-IN-PLACE REINFORCED CONCRETE WITH A BOARD-FORMED FINISH. SURFACES ARE DECORATIVELY PAINTED AND INCLUDE MULTI-COLORED STENCIL-LIKE DESIGNS. CURRENTLY, SURFACES ARE SOILED AND STAINED, AND PAINT COLORS ARE FADED. THE PROSCENIUM WAS ENCLOSED WITH OTHER MATERIALS AND THERE ARE LOCALIZED AREAS OF DAMAGE OR PAINT LOSS.

BASED ON SOLVENT SOLUBILITY TESTING, PAINTS ARE NOT SOLUBLE IN WATER OR A RANGE OR INORGANIC AND ORGANIC SOLVENTS. MANY OF THE DETERGENTS AND SOLVENTS TESTED CLEANED THE SURFACE BUT DID NOT RESATURATE COLORS. THE MOST SUCCESSFUL CLEANING METHOD USED A PROPRIETARY CLEANER, "KOTTON KLENSER" CLEANER AND OIL PAINTING RESTORING OIL. LOCALIZED IN-PAINTING WILL ALSO BE NECESSARY TO RESTORE AREAS OF DAMAGE.

RECOMMENDED CLEANING REGIMEN FOR PROSCENIUM: PROSCENIUM CONCRETE SURFACES WILL BE CLEANED WITH "KOTTON KLENSER" CLEANER AND OIL PAINTING RESTORING OIL. AREAS OF PAINT LOSS AND STAINS THAT REMAIN AFTER CLEANING WILL BE VISUALLY INTEGRATED WITH LOCALIZED IN-PAINTING TO MATCH SURROUNDING SURFACES.



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### PLAZA **THEATRE**

### **REHABILITATION**

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SHEET TITLE

HISTORIC FINISH ANALYSIS -**PROSCENIUM** 

ISSUANCE


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### SITE PLAN GENERAL NOTES



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### OVERALL SITE PLAN

ISSUANCE

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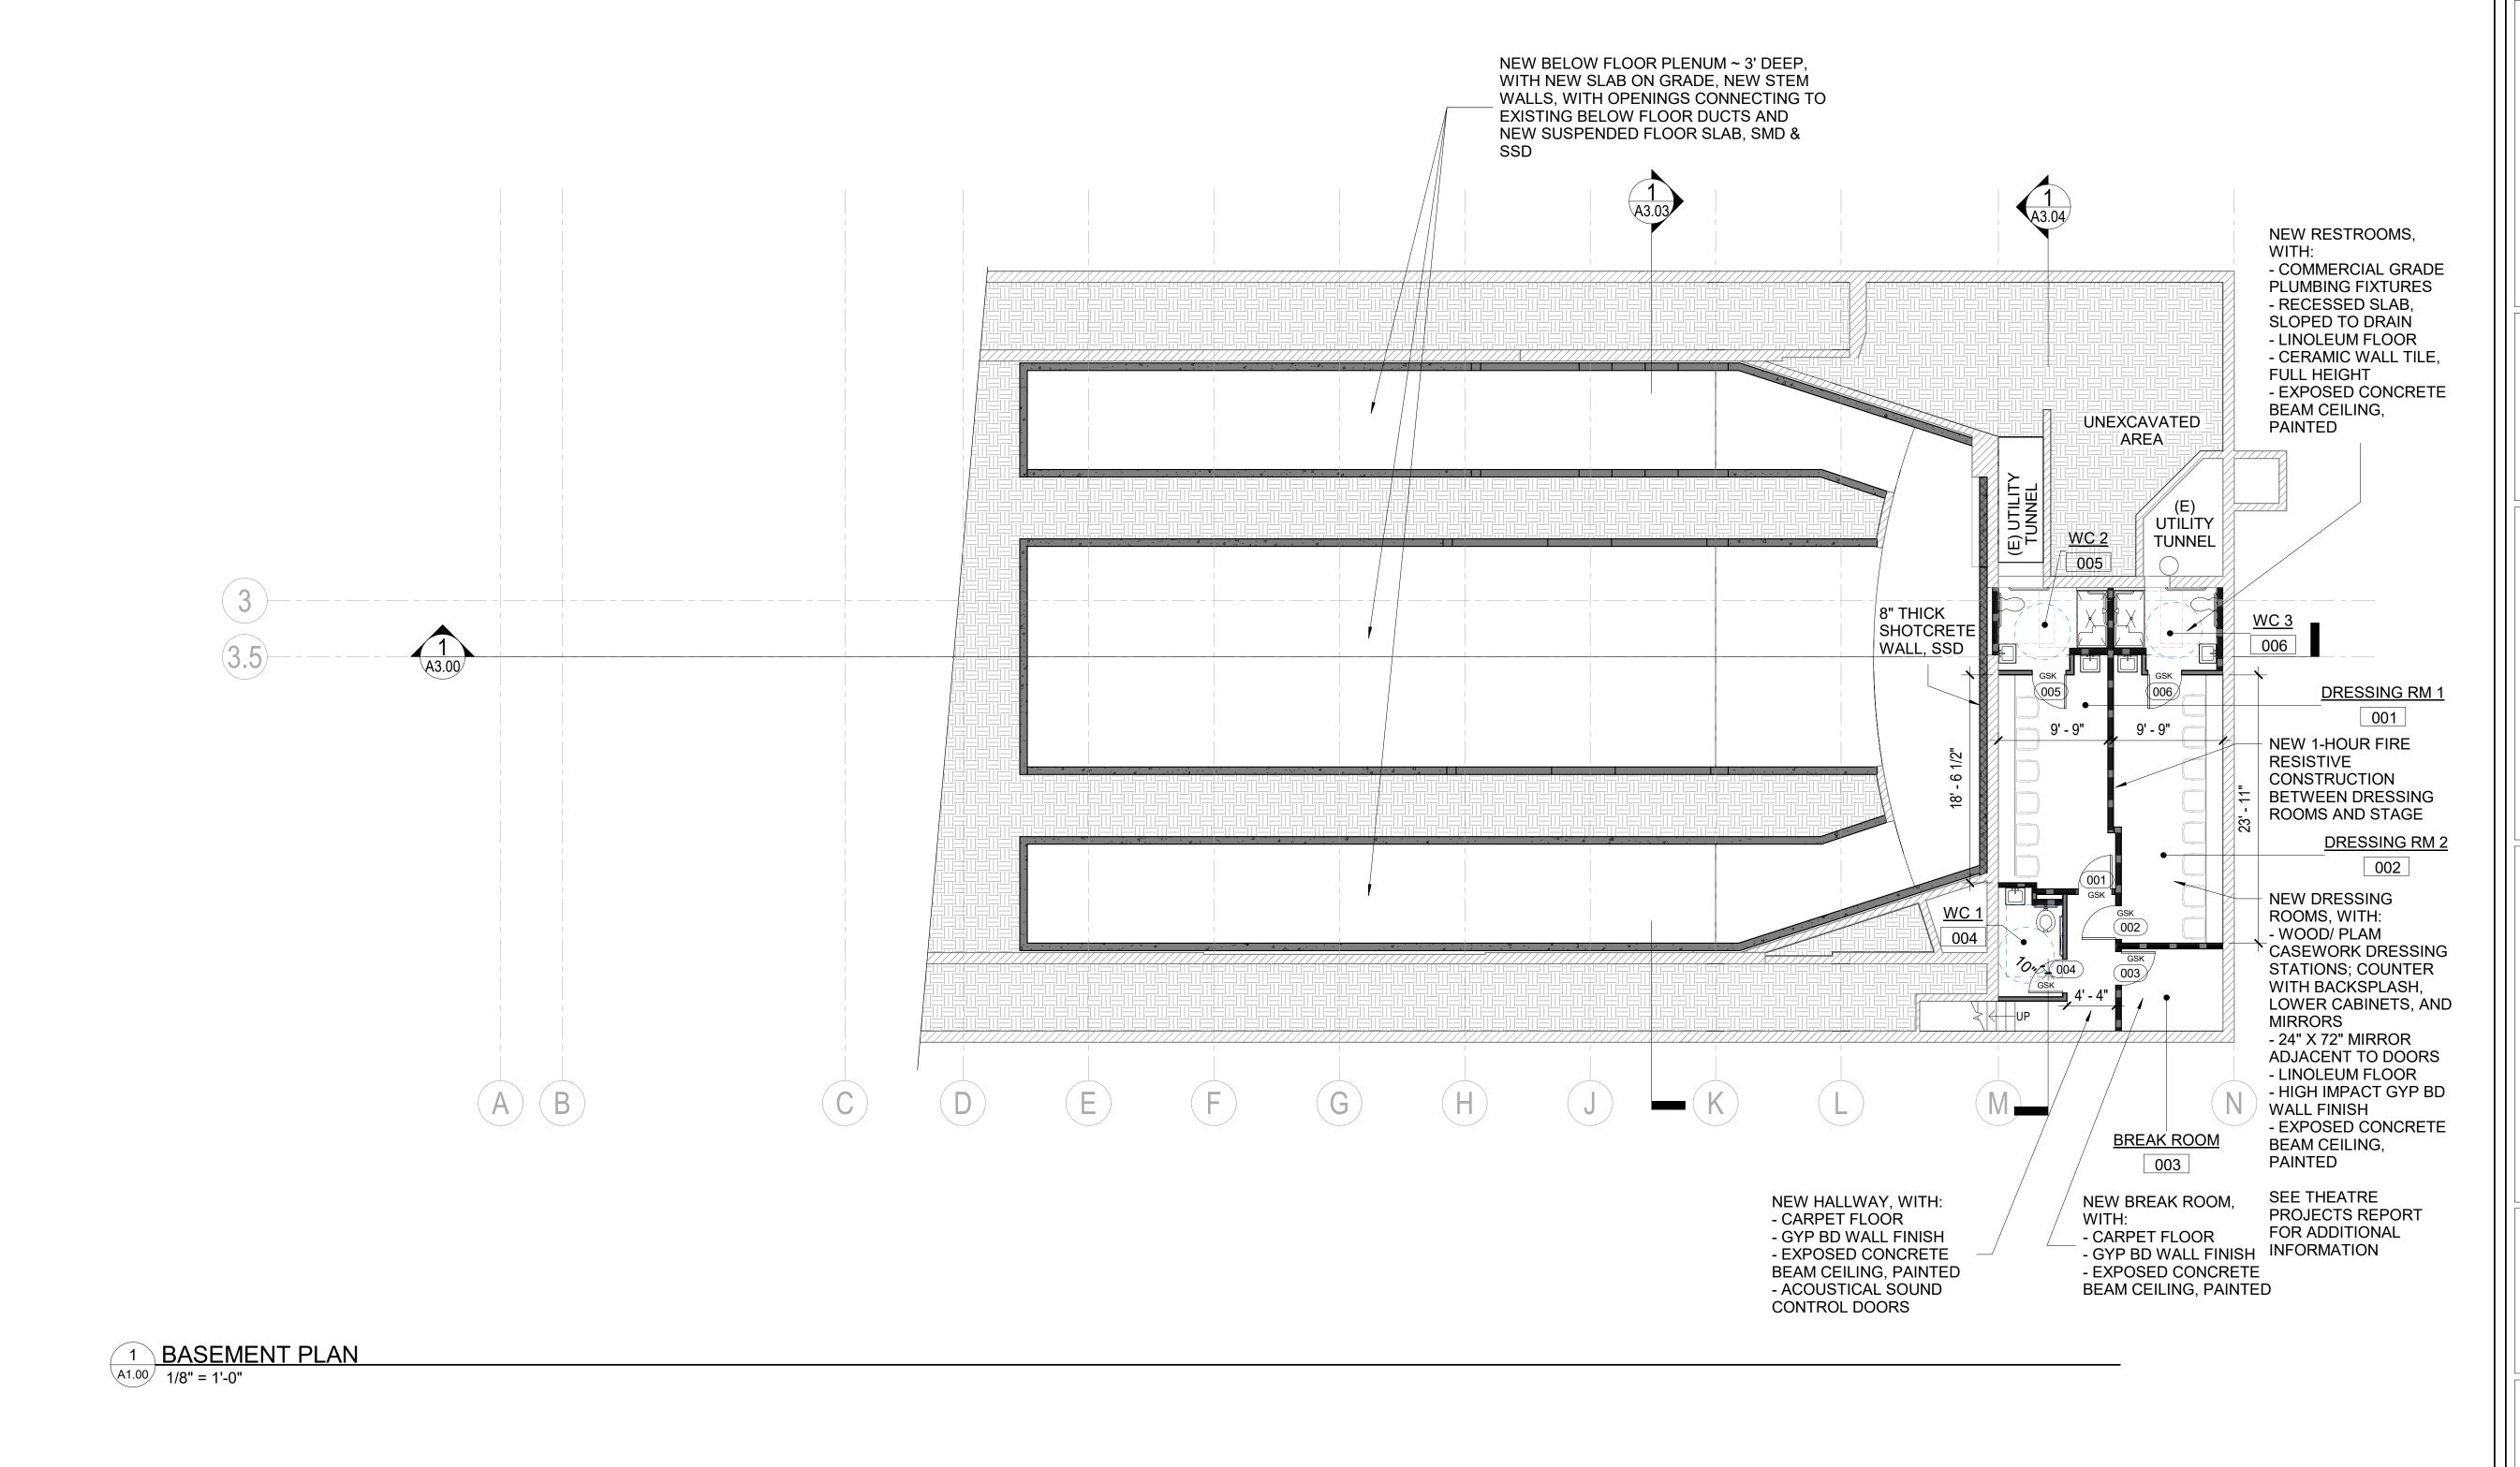
PROJ. NO. 220602
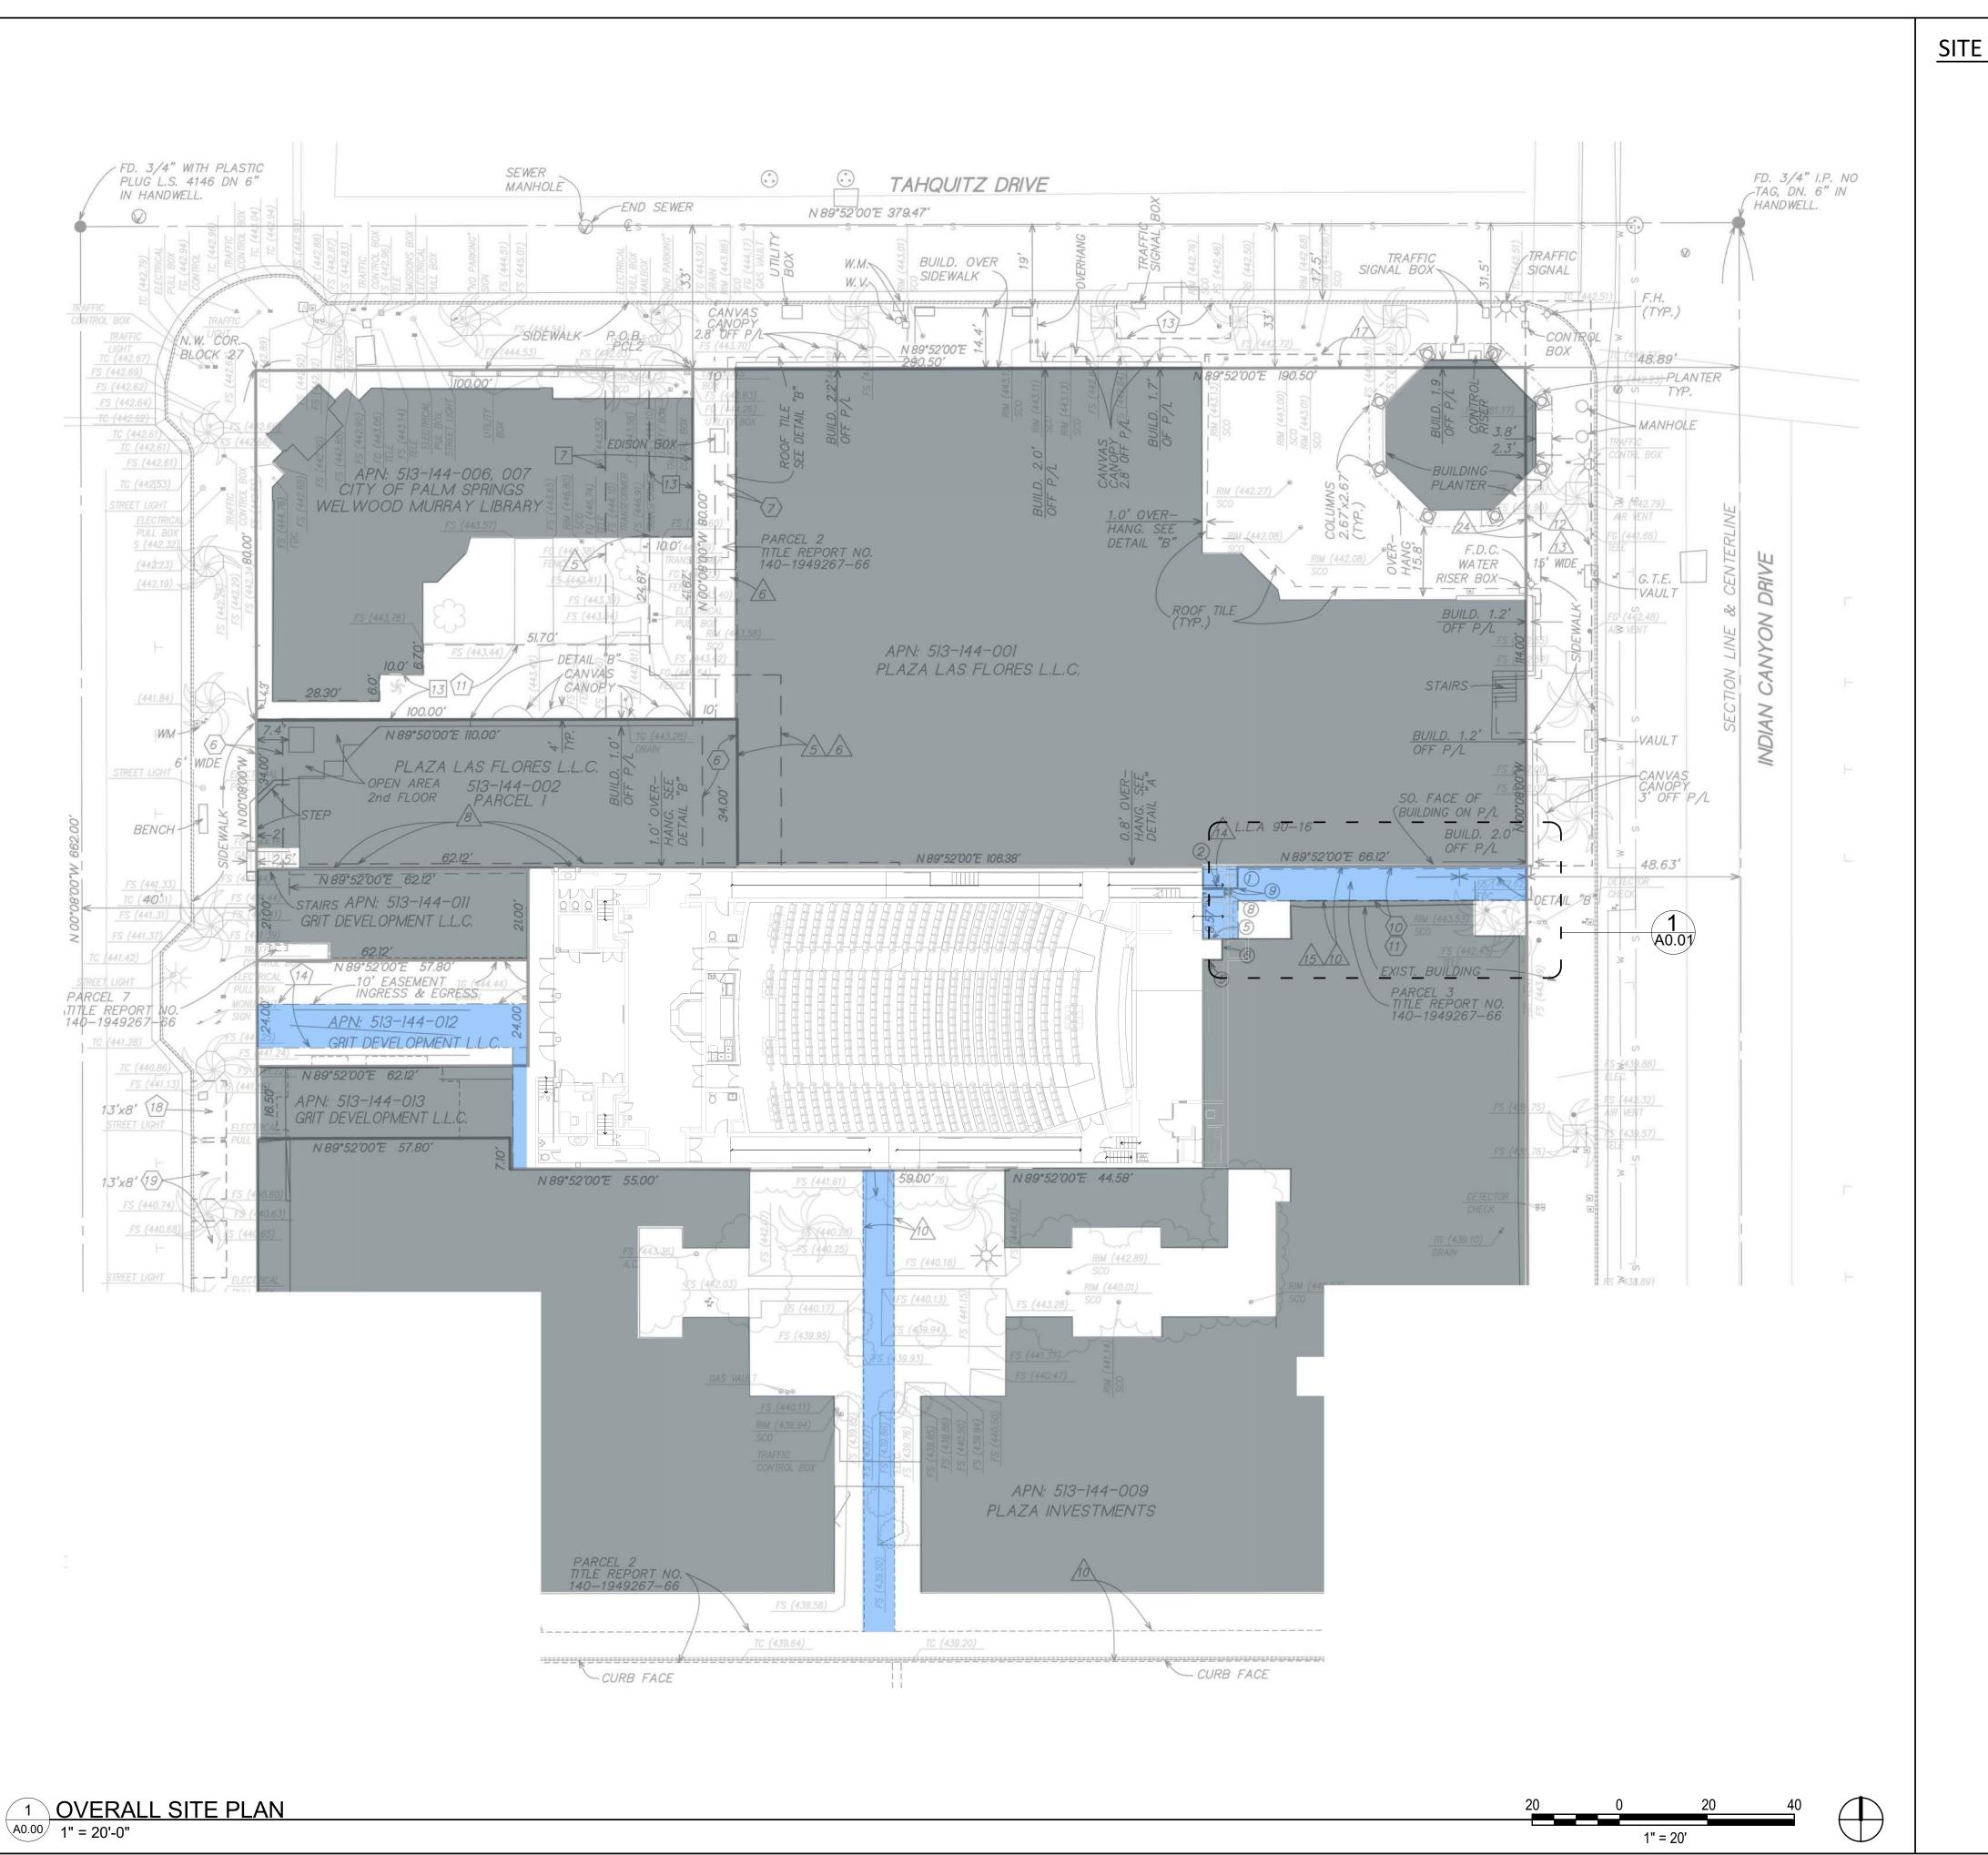
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CHECKED JC/SD/NOM

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A0.00



### FLOOR PLAN GENERAL NOTES

- SEE GENERAL PROJECT NOTES ON T1.10.
   PATCH WALL AND CEILING SURFACES OPENED FOR INSTALLATION OF STRUCTURAL, MECHANICAL, PLUMBING, OR ELECTRICAL WORK. REPAIR AND REINSTALL WOOD BASE AND TRIM REMOVED FOR CONSTRUCTION.
- 3. PATCH FLOORS AND WALL AND CEILING SURAFCES AND INFILL WOOD TRIM WHERE WALLS REMOVED OR MODIFIED TO PROVIDE CONTINUOUS SURFACE.
- NEW OPENINGS TO BE CASED IN TRIM TO MATCH ADJACENT.

### FLOOR PLAN LEGEND



NEW CONSTRUCTION


NEW CONSTRUCTION 1-HR WALL

NEW SHOTCRETE WALL, SSD

NEW POURED CONCRETE STEM WALL, SSD

EXISTING CONSTRUCTION TO BE REMOVED

EXISTING MASONRY CONSTRUCTION TO REMAIN

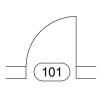

DOOR NUMBER

DOORS TO RECEIVE ACOUSTICAL GASKETING

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SHEET TITLE

**BASEMENT PLAN** 

ISSUANCE

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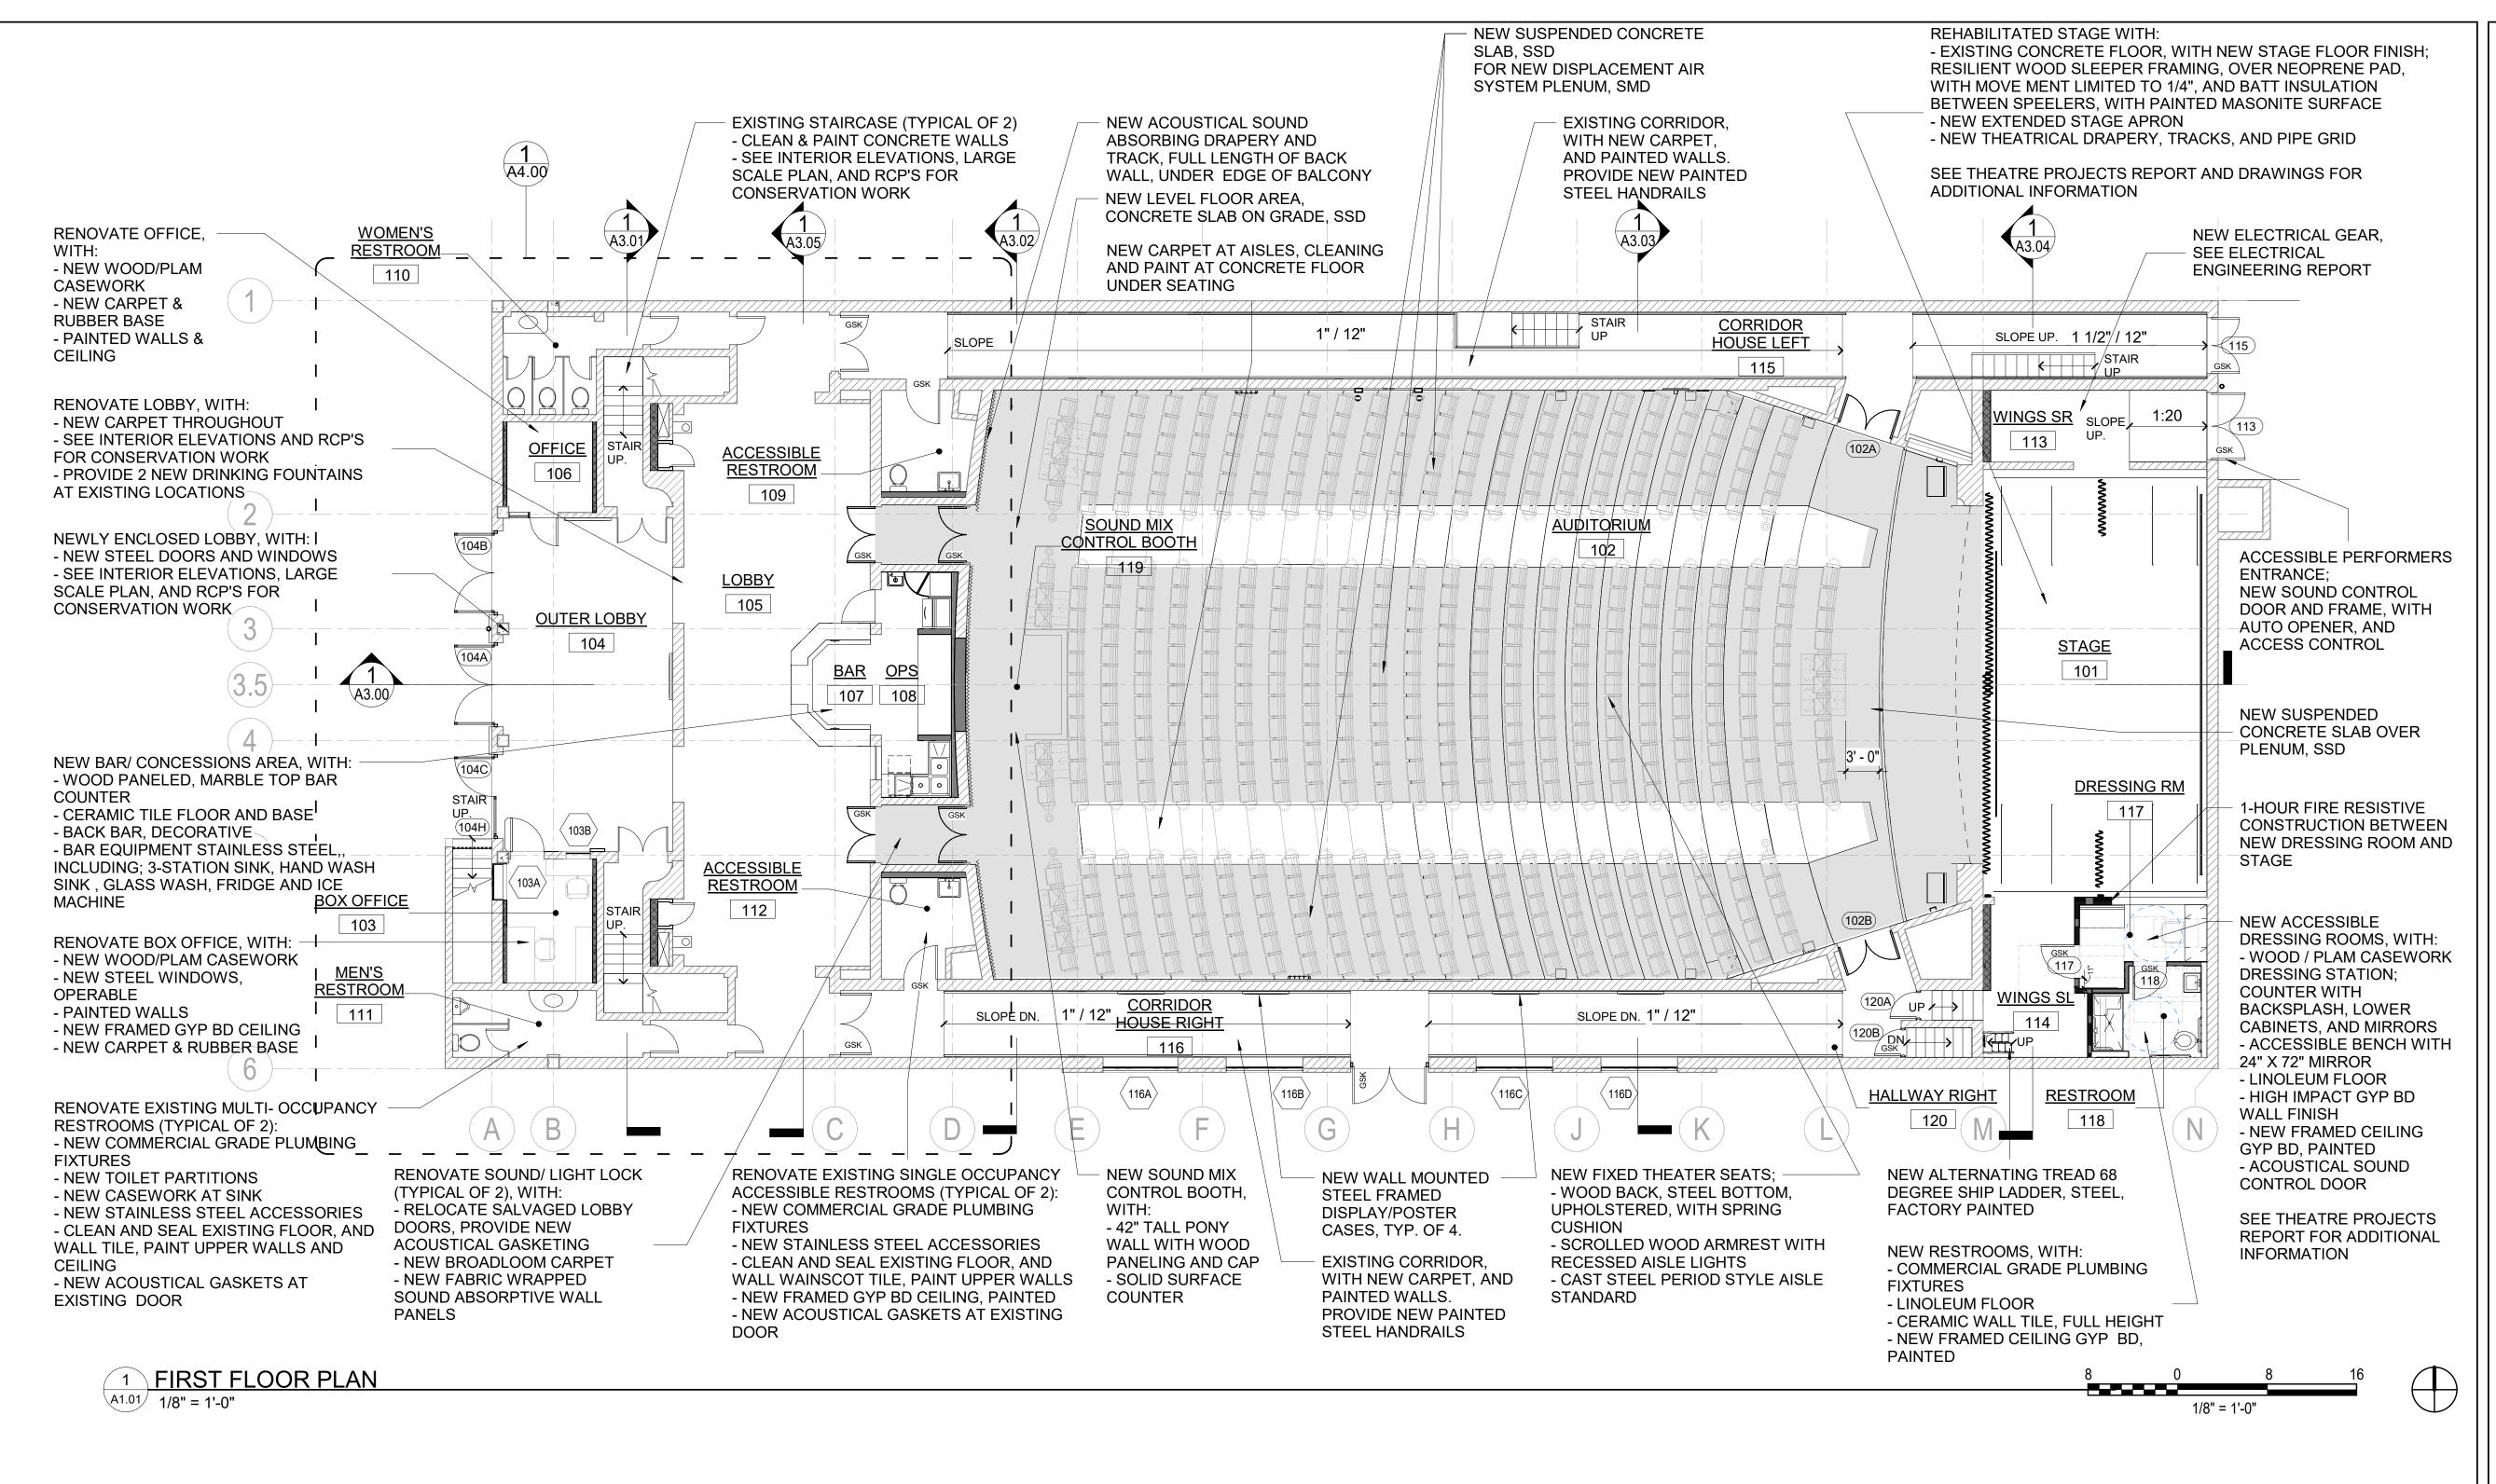
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BT/MGB

CHECKED JC/SD/NOM

DRAWING NO.

A1.00



### FLOOR PLAN GENERAL NOTES

1. SEE GENERAL PROJECT NOTES ON T1.10. 2. PATCH WALL AND CEILING SURFACES OPENED FOR INSTALLATION OF STRUCTURAL, MECHANICAL, PLUMBING, OR ELECTRICAL WORK. REPAIR AND REINSTALL WOOD

BASE AND TRIM REMOVED FOR CONSTRUCTION.

- 3. PATCH FLOORS AND WALL AND CEILING SURAFCES AND INFILL WOOD TRIM WHERE WALLS REMOVED OR MODIFIED TO PROVIDE CONTINUOUS SURFACE.
- 4. NEW OPENINGS TO BE CASED IN TRIM TO MATCH ADJACENT.

### **SEATING COUNT**

528 MAIN LEVEL WHEELCHAIR 8\* SEMI-AUBULANT 8\*\* REMOVABLE (TBD) BALCONY LEVEL 164 TOTAL


(685 WHEN ALL WHEELCHAIR SEATS ARE IN USE)

\*PER11B-221.2.1.1 FOR 704 TOTAL SEATS PROVIDED, 8 WHEELCHAIR SPACES REQUIRED

\*\*PER 11B-221.6 FOR 704 TOTAL SEATS PROVIDED, 8 SEMI-AMBULANT SEATS ARE REQUIRED

NOTE: ALL WHEELCHAIR SPACES ARE PROVIDED WITH COMPANION SEATS, PER 11B-221.3

### FLOOR PLAN LEGEND

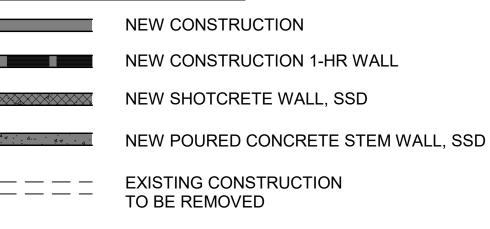

**EXISTING MASONRY** CONSTRUCTION TO REMAIN

**101** 

DOOR NUMBER

**GSK** DOORS TO RECEIVE ACOUSTICAL GASKETING Architectural Resources Group

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### **PLAZA** THEATRE

**REHABILITATION** 

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SHEET TITLE

FIRST FLOOR PLAN

**ISSUANCE** 


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PROJ. NO. 220602

> DRAWN BT/MGB

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- 1. SEE GENERAL PROJECT NOTES ON T1.10. 2. PATCH WALL AND CEILING SURFACES OPENED FOR INSTALLATION OF STRUCTURAL, MECHANICAL, PLUMBING, OR ELECTRICAL WORK. REPAIR AND REINSTALL WOOD BASE AND TRIM REMOVED FOR CONSTRUCTION.
- 3. PATCH FLOORS AND WALL AND CEILING SURAFCES AND INFILL WOOD TRIM WHERE WALLS REMOVED OR MODIFIED TO PROVIDE CONTINUOUS SURFACE.
- 4. NEW OPENINGS TO BE CASED IN TRIM TO MATCH ADJACENT.

WHEELCHAIR 8\* SEMI-AUBULANT REMOVABLE (TBD) BALCONY LEVEL 164 TOTAL

\*PER11B-221.2.1.1 FOR 704 TOTAL SEATS PROVIDED, 8 WHEELCHAIR

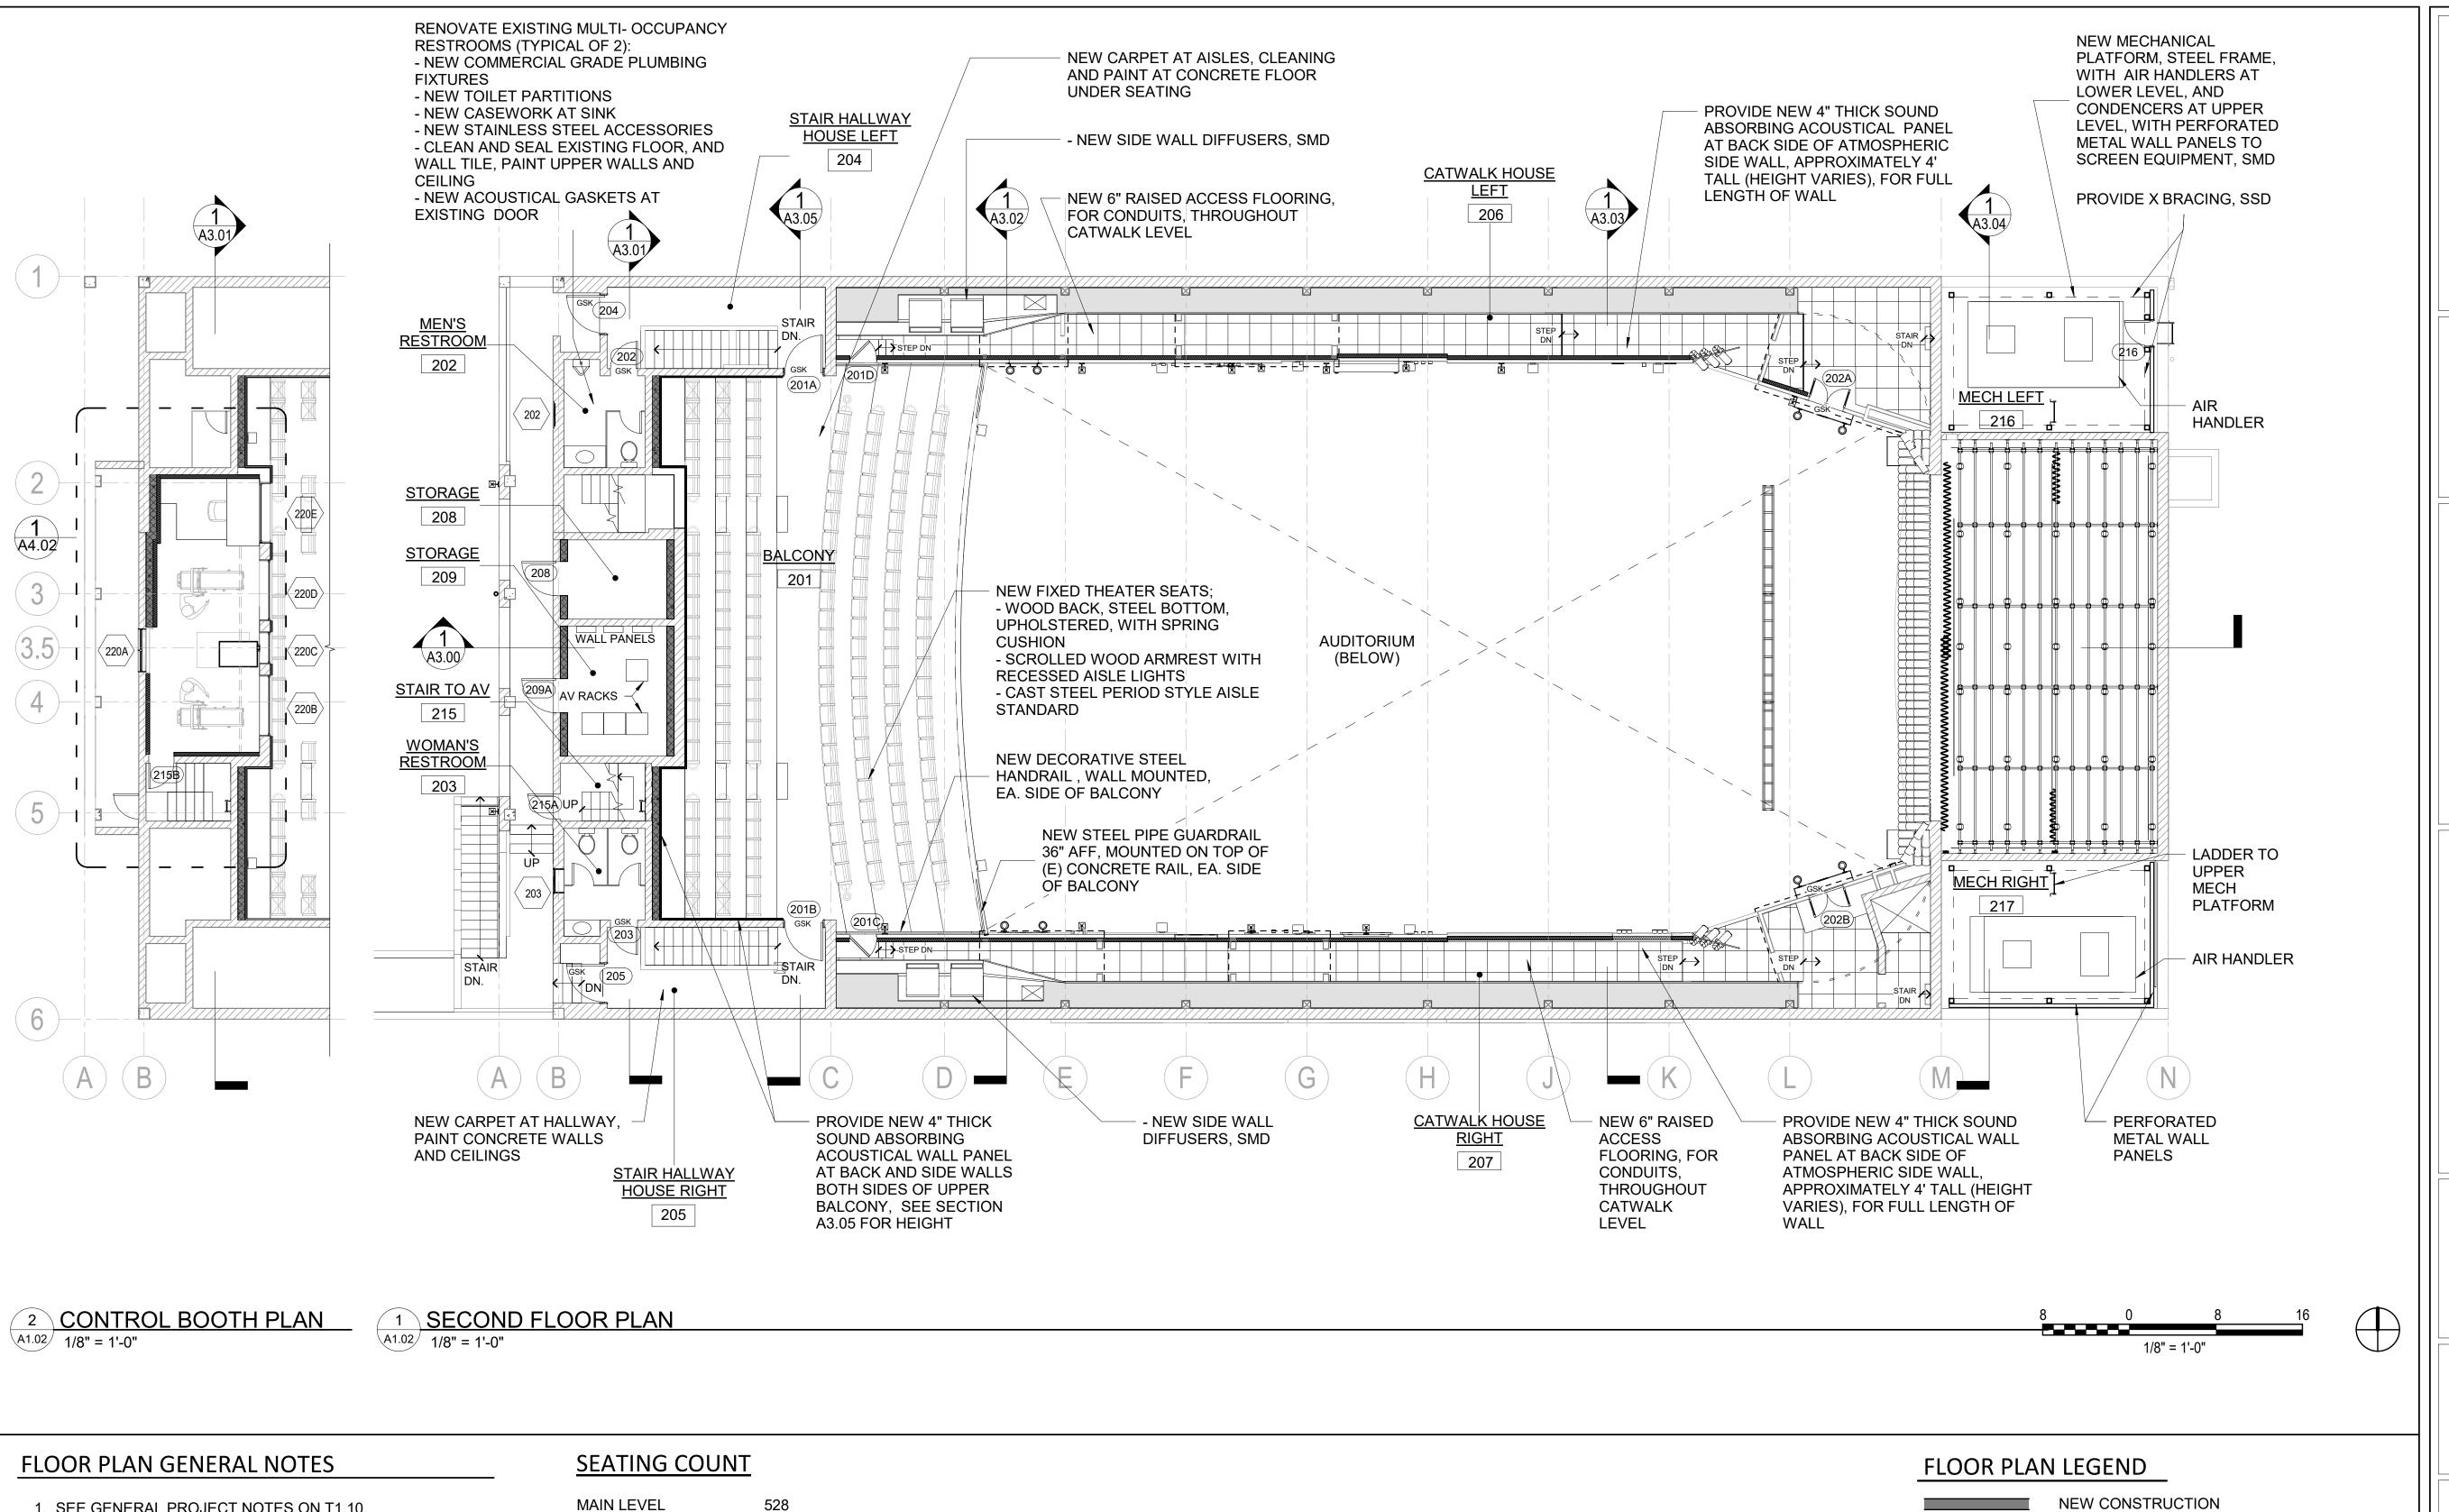(685 WHEN ALL WHEELCHAIR SEATS ARE IN USE)

SPACES REQUIRED

\*\*PER 11B-221.6 FOR 704 TOTAL SEATS PROVIDED, 8 SEMI-AMBULANT SEATS ARE REQUIRED

NOTE: ALL WHEELCHAIR SPACES ARE PROVIDED WITH COMPANION SEATS, PER 11B-221.3

NEW CONSTRUCTION 1-HR WALL

NEW SHOTCRETE WALL, SSD

NEW POURED CONCRETE STEM WALL, SSD

EXISTING CONSTRUCTION TO BE REMOVED

**EXISTING MASONRY** CONSTRUCTION TO REMAIN

101

**DOOR NUMBER** 

DOORS TO RECEIVE ACOUSTICAL GASKETING

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### SECOND FLOOR PLAN


**ISSUANCE HSPB SUBMITTAL** 


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03-02 CONCRETE PATCH REPAIR

05-01 REPAIR AND REPAINT (E) METALWORK (GRILLE, RAILING, ETC.)

06-01 WOOD EPOXY PATCH REPAIR

07-03 REPAIR (E) CLAY TILE ROOF, SEE NOTES ON ROOF PLAN

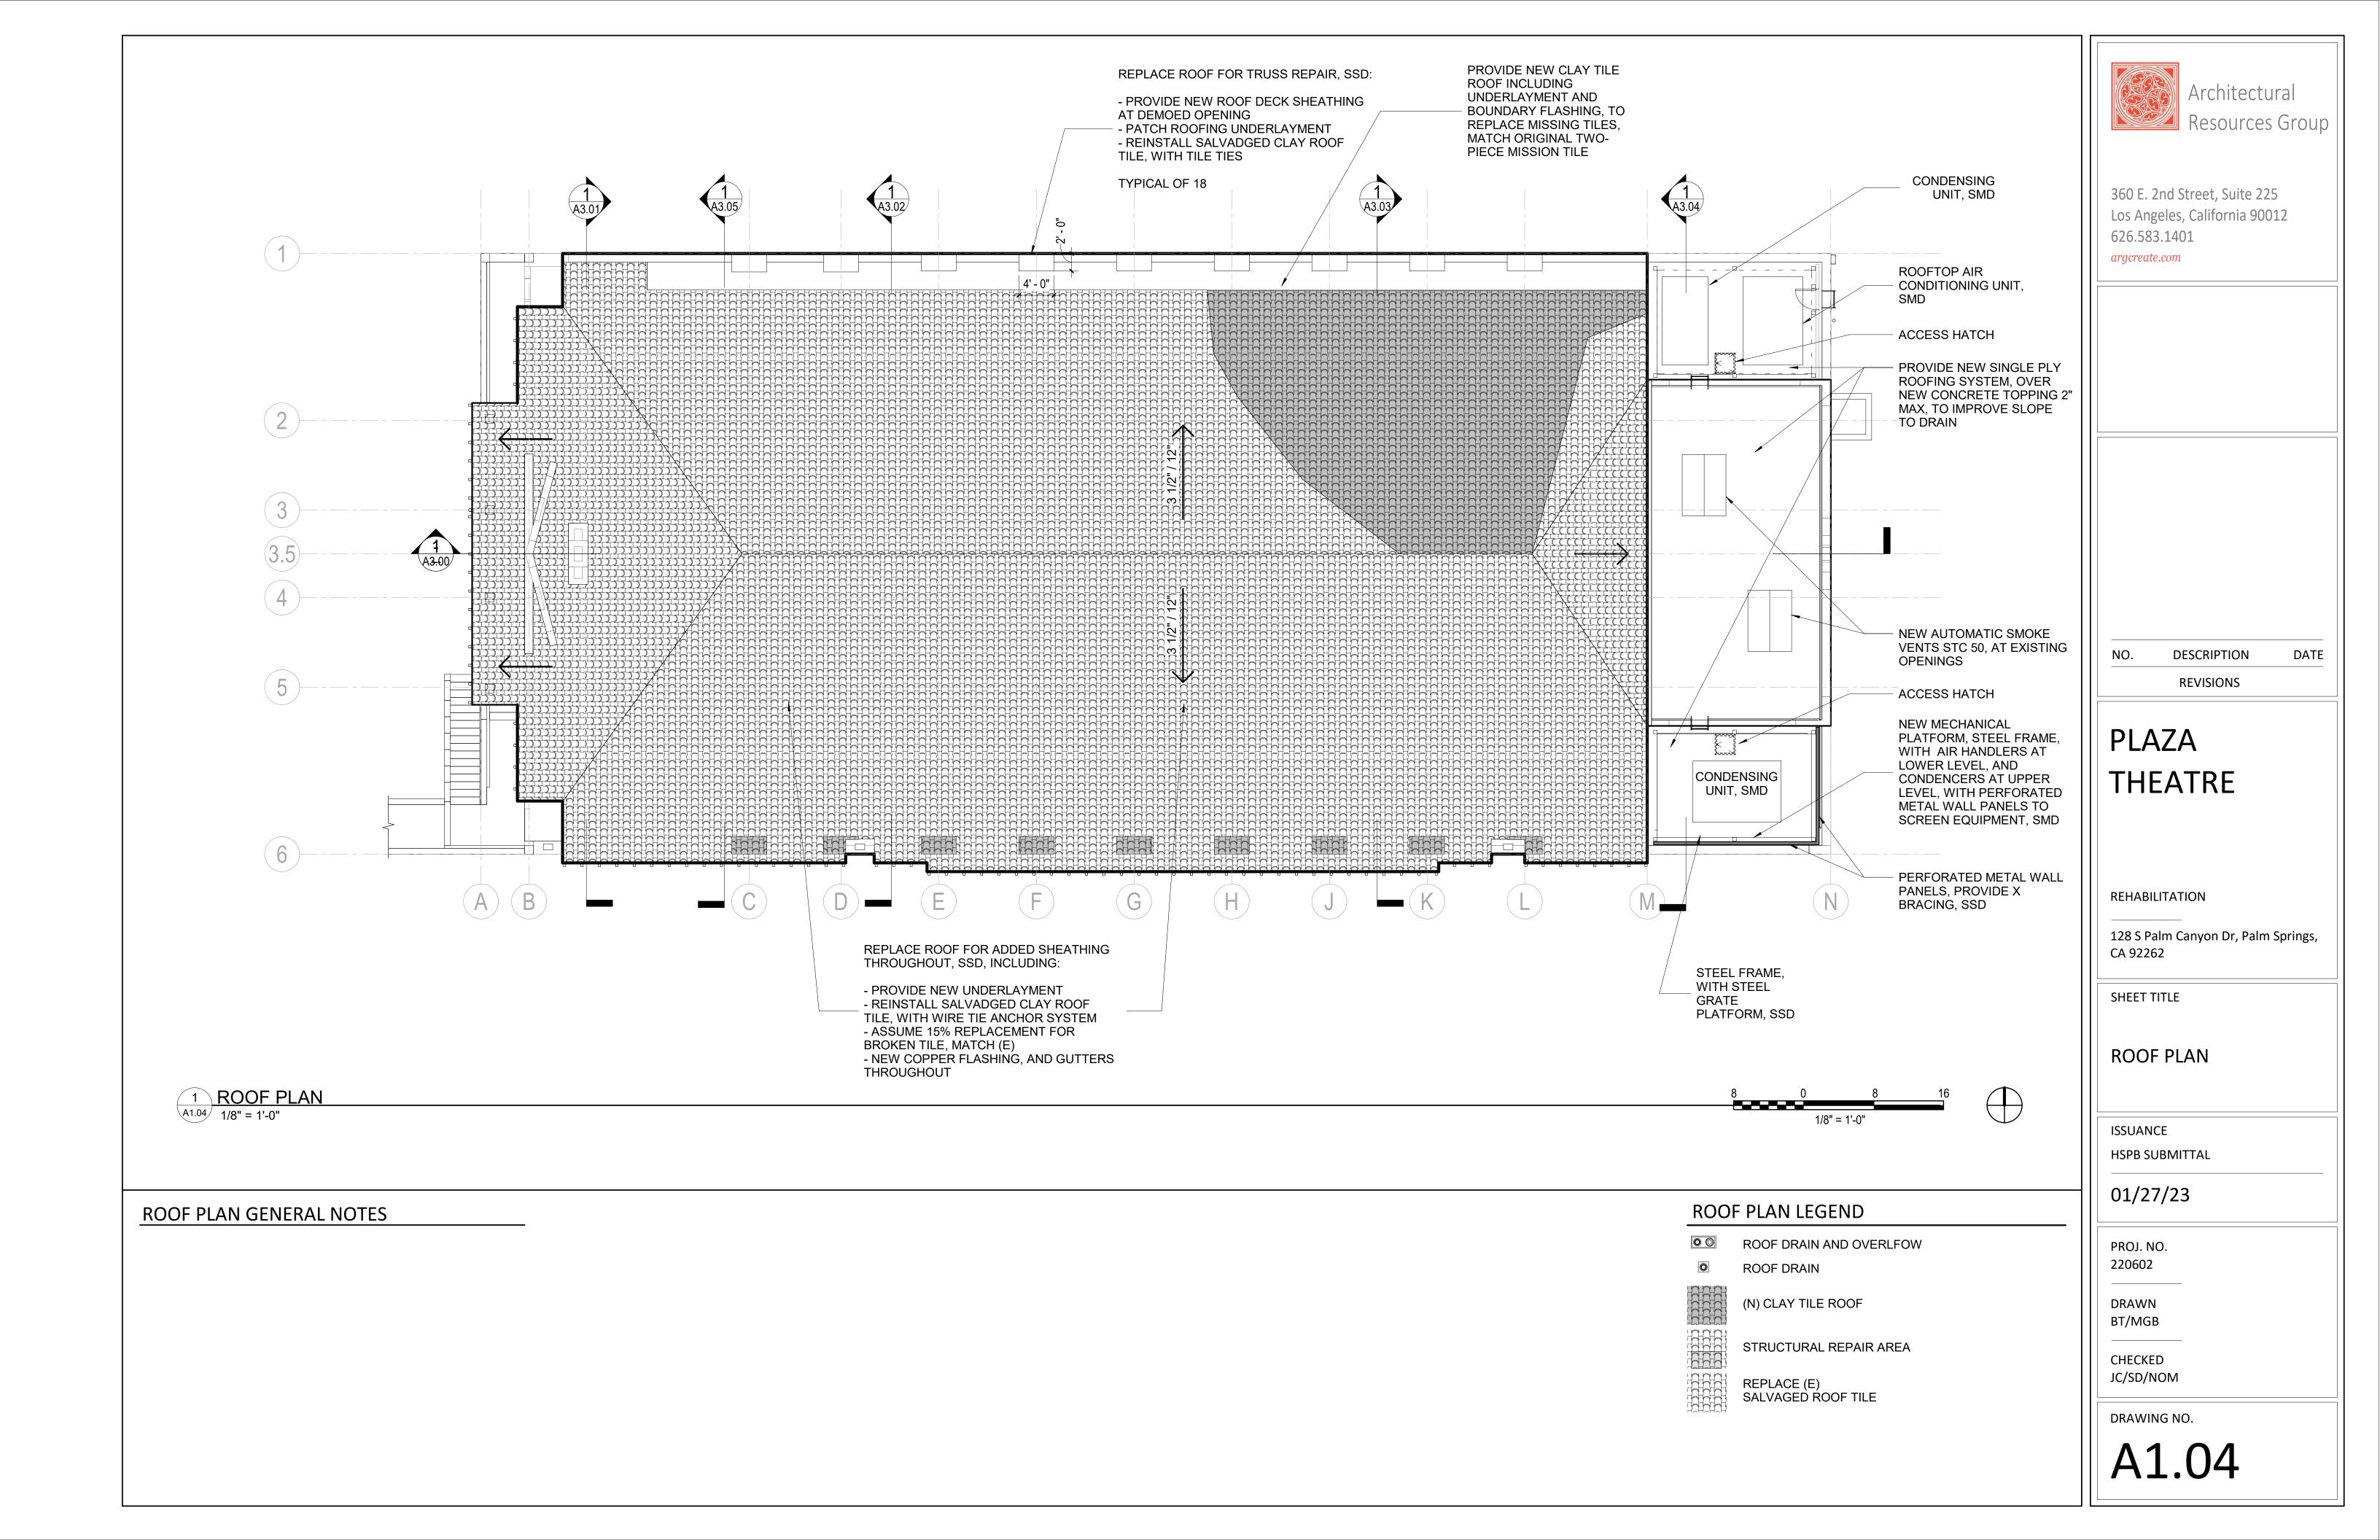07-06 REPAIR AND REPAINT (E) DRAINAGE SYSTEM

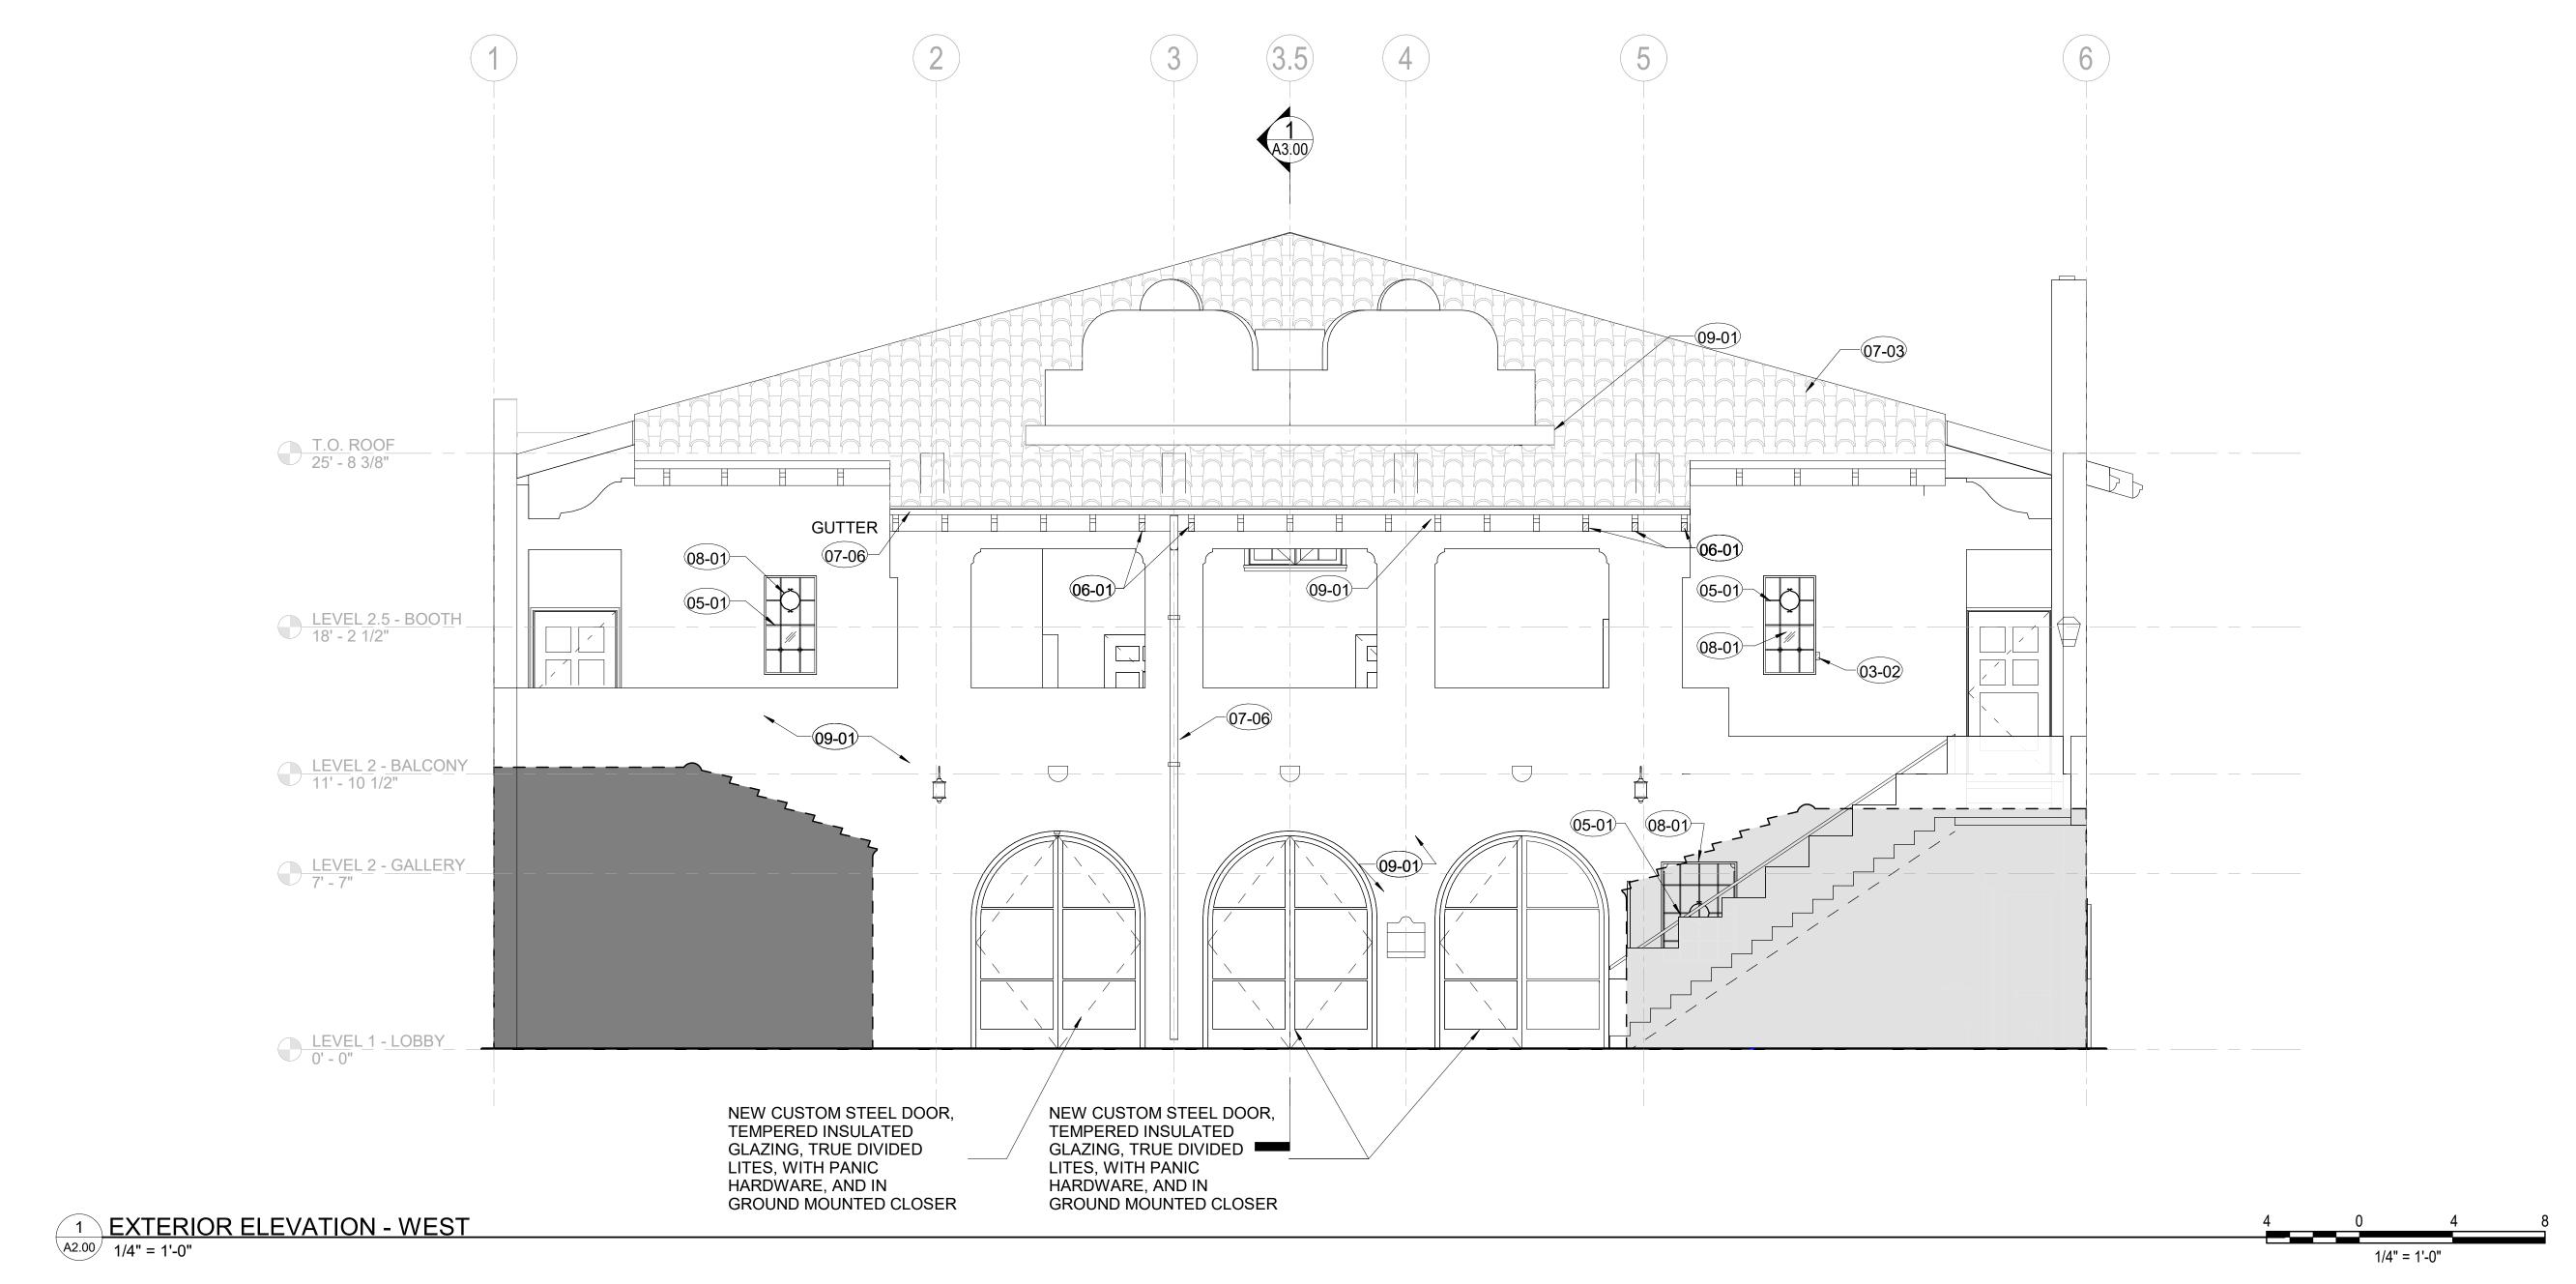CLEAN, PREPARE AND REPAINT SURFACES

REPAIR STEEL WINDOW

### EXTERIOR ELEVATION GENERAL NOTES

1. SUBMIT REPAIR SCHEDULE FOR ARCHITECT'S REVIEW INDICATING REPAIR LOCATIONS AND QUANTITIES PRIOR TO START OF WORK.

(COORDINATE WITH ALLOWANCES AND UNIT PRICES)

### EXTERIOR CONCRETE AND CMU MASONRY:

- REMOVE VEGETATION WHERE NOTED.
   CLEAN AND PREPARE CONCRETE AND CMU SURFACES FOR REPAINTING.
- 3. REMOVE OBSOLETE OR ABANDONED FASTENERS, WIRING, NAILS, ETC. AND PATCH HOLES
- 4. ROUT OUT AND FILL CRACKS IN CONCRETE OR CMU UNITS WITH COMPATIBLE CEMENTITIOUS MORTAR AND FINISH TO MATCH SURROUNDING SURFACES.
- 5. SAWCUT AND REPOINT MORTAR JOINTS WHERE
- DETERIORATED OR MISSING.
- 6. REPAINT CMU MASONRY SURFACES AS SPECIFIED.

### 1. CLEAN AND PREPARE WOOD SURFACES FOR REPAINTING.

- REMOVE AREAS OF WOOD DECAY TO SOUND SUBSTRATE, AND TREAT SURFACES WITH A WOOD CONSOLIDANT.
- 3. FILL VOIDS, HOLES, CRACKS, CHECKS OR GAPS WITH AN EPOXY PASTE AND FINISH TO MATCH SURROUNDING SURFACES.
- 4. REMOVE AREAS OF HEAVY WOOD DECAY OR LOSS, AND REPLACE PORTION OF MEMBER WITH WOOD DUTCHMEN TO MATCH.
- 5. REPLACE WOOD MEMBERS WHERE SHOWN ON DRAWINGS WITH NEW TO MATCH.
- 6. REPAINT EXTERIOR SURFACES AS SPECIFIED.

### EXTERIOR METALWORK: (RAILINGS, GRILLES, ETC.)

- CLEAN AND PREPARE SURFACES FOR REPAINTING.
   TREAT AREAS OF CORROSION WITH A CORROSION INHIBITOR, AND PRIME.
- 3. INSPECT HARDWARE AND CONNECTIONS. TIGHTEN WHERE LOOSE. REPLACE WHERE DAMAGED OR MISSING.
- 4. REPAINT STEEL SURFACES AS SPECIFIED.

### EXTERIOR STEEL WINDOWS:

- EXISTING WINDOW SIZES SHOWN ARE NOMINAL. FIELD VERIFY ACTUAL SIZE.
- 2. CONTRACTOR TO ENSURE PROPER WORKING ORDER AND WEATHERTIGHTNESS.
- CLEAN AND PREPARE SURFACES FOR REPAINTING.
   TREAT AREAS OF CORROSION WITH A CORROSION INHIBITOR, AND PRIME.
- 5. REPLACE BROKEN OR DAMAGED GLASS WHERE NOTED.6. REMOVE CRACKED, LOOSE OR DE-BONDED GLAZING PUTTY
- AND INFILL WITH NEW PUTTY; MATCH EXISTING PROFILE.

  7. REPAINT STEEL SURFACES AS SPECIFIED.
- CLEAN AND LUBRICATE (E) HARDWARE.
   INSTALL (N) PERIMETER SEALANT AT JOINT BETWEEN FRAME AND BUILDING WALLS.
- 10. INSTALL (N) WEATHERSTRIPPING.

# Architectural Resources Group

360 E. 2nd Street, Suite 225 Los Angeles, California 90012 626.583.1401

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IO. DESCRIPTION

**REVISIONS** 

DATE

### PLAZA THEATRE

### 

128 S Palm Canyon Dr, Palm Springs, CA 92262

SHEET TITLE

# WEST EXTERIOR ELEVATION

ISSUANCE

HSPB SUBMITTAL

01/27/23

PROJ. NO. 220602

**EXTERIOR ELEVATION LEGEND** 

ADJACENT BUILDING,

NOT IN SCOPE


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BT/MGB

JC/SD/NOM

DRAWING NO.

A2.00

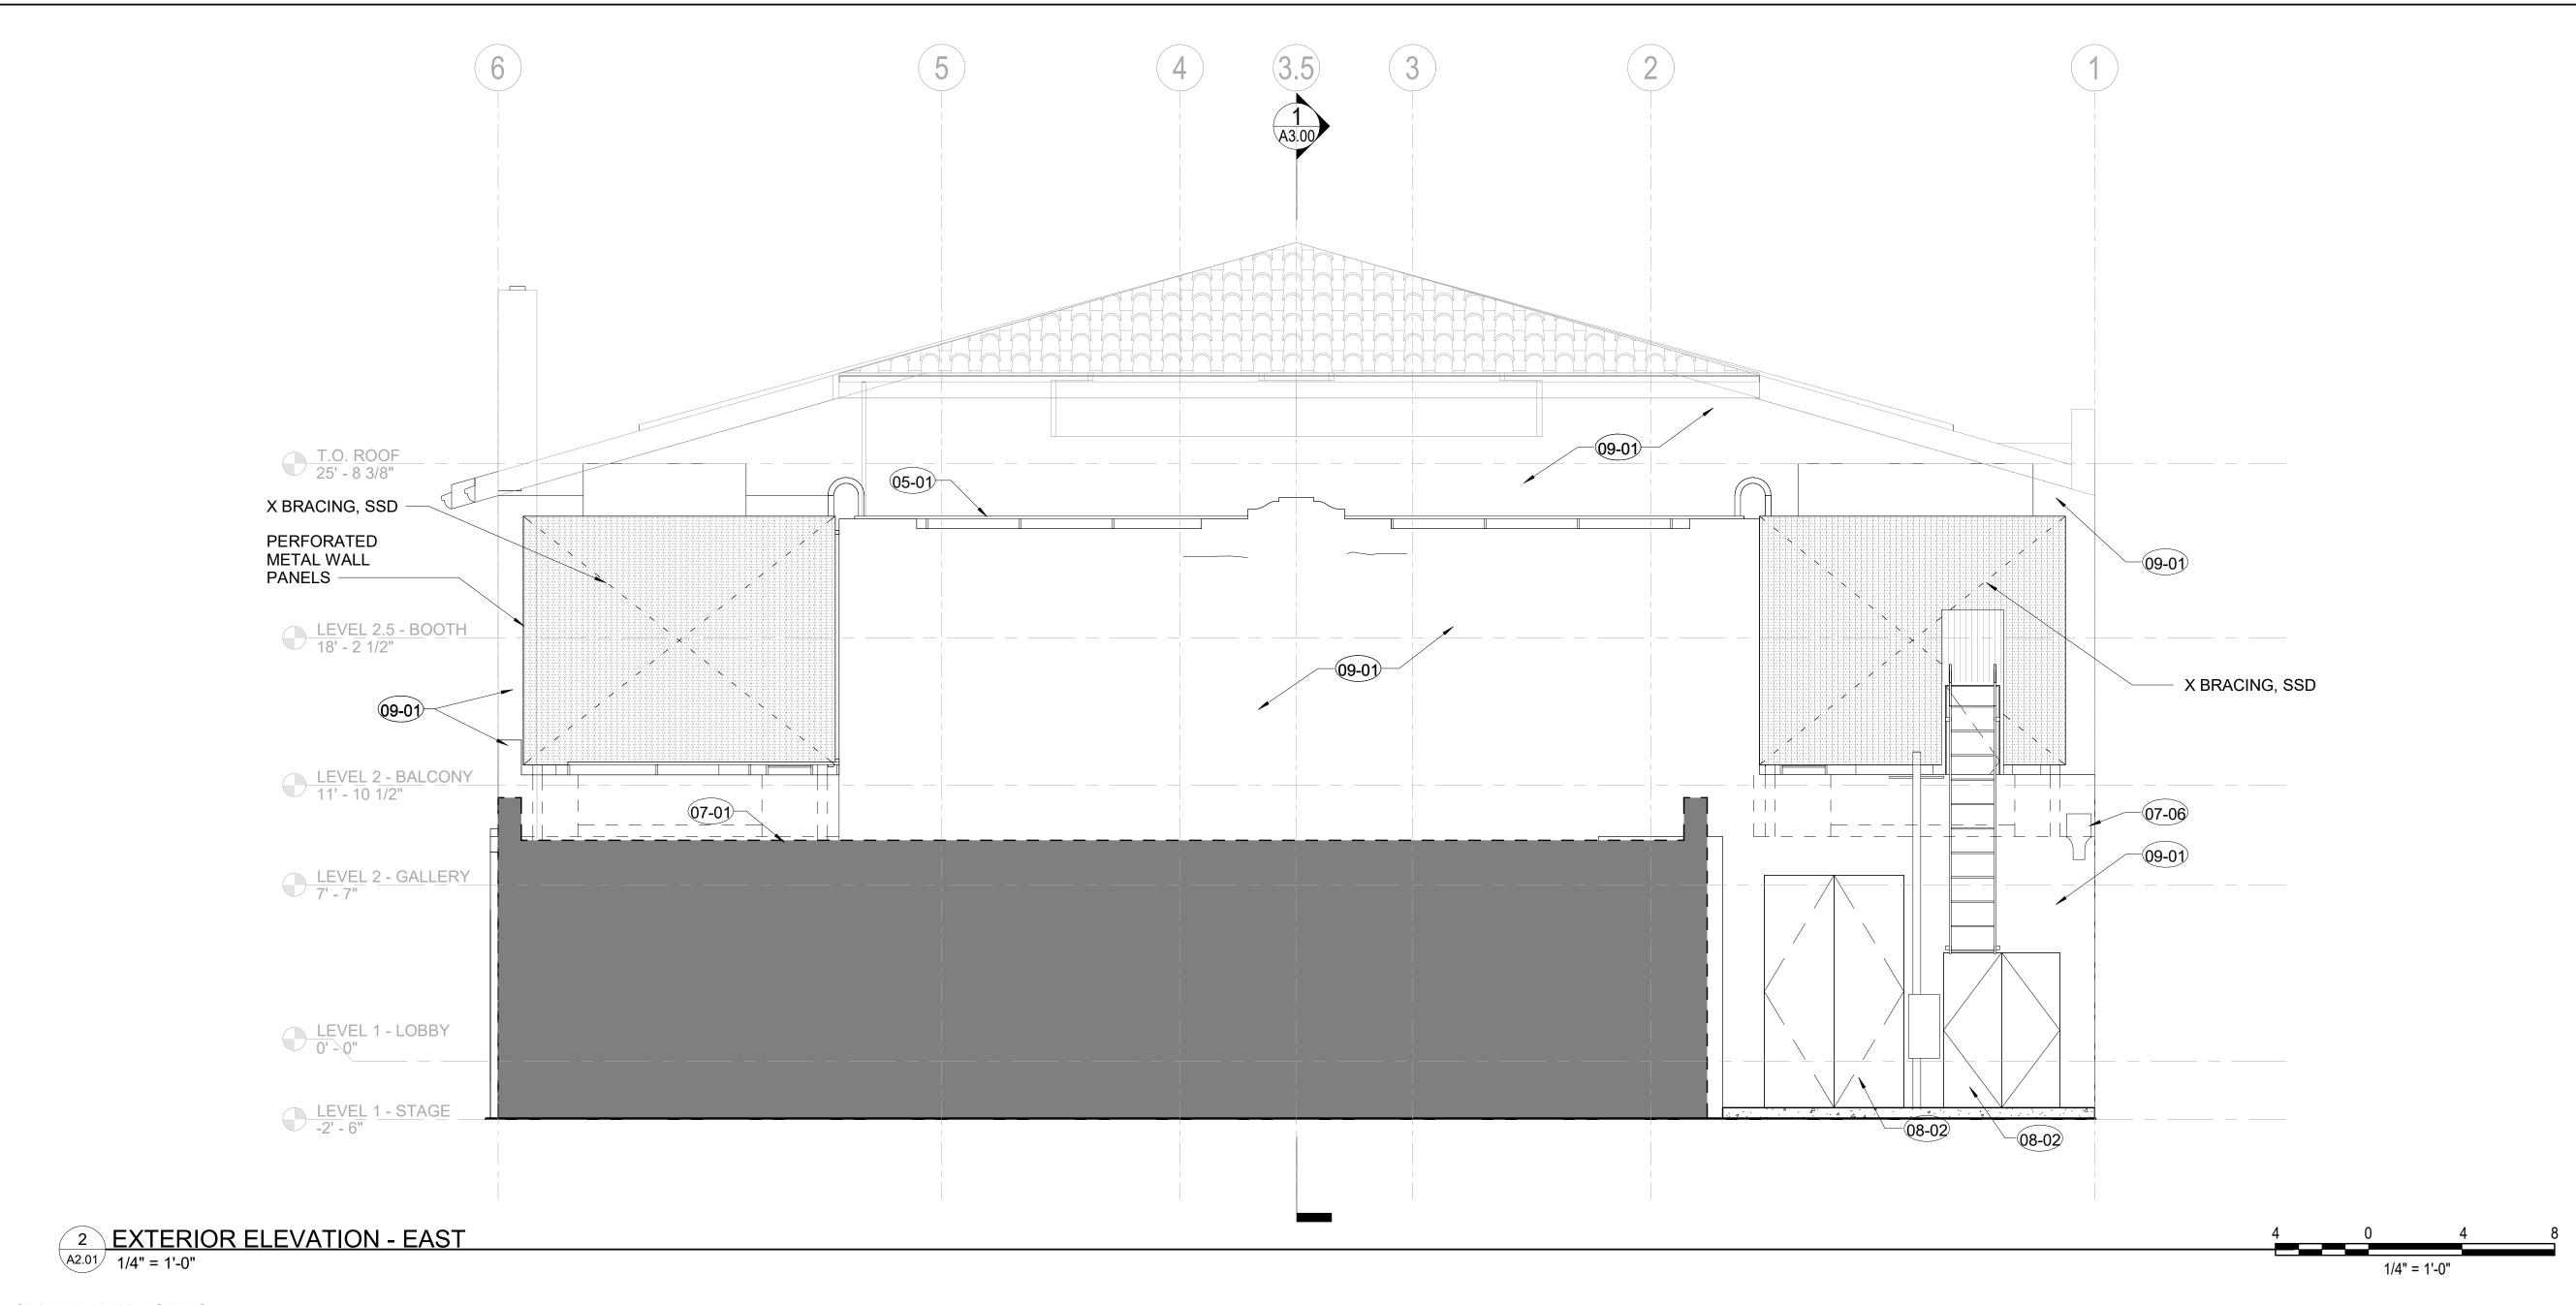

05-01 REPAIR AND REPAINT (E) METALWORK (GRILLE, RAILING, ETC.)

**NEW MEMBRANE ROOF** 07-01

07-06 REPAIR AND REPAINT (E) DRAINAGE SYSTEM

REPAIR HOLLOW METAL DOOR 08-02

CLEAN, PREPARE AND REPAINT SURFACES 09-01

### EXTERIOR ELEVATION GENERAL NOTES

1. SUBMIT REPAIR SCHEDULE FOR ARCHITECT'S REVIEW INDICATING REPAIR LOCATIONS AND QUANTITIES PRIOR TO START OF WORK.

(COORDINATE WITH ALLOWANCES AND UNIT PRICES)

#### **EXTERIOR CONCRETE AND CMU MASONRY:** 1. REMOVE VEGETATION WHERE NOTED.

- 2. CLEAN AND PREPARE CONCRETE AND CMU SURFACES FOR REPAINTING.
- 3. REMOVE OBSOLETE OR ABANDONED FASTENERS, WIRING, NAILS, ETC. AND PATCH HOLES
- 4. ROUT OUT AND FILL CRACKS IN CONCRETE OR CMU UNITS WITH COMPATIBLE CEMENTITIOUS MORTAR AND FINISH TO MATCH SURROUNDING SURFACES.
- 5. SAWCUT AND REPOINT MORTAR JOINTS WHERE
- DETERIORATED OR MISSING.
- 6. REPAINT CMU MASONRY SURFACES AS SPECIFIED.

#### EXTERIOR WOOD: (RAFTER TAILS, EXPOSED DECKING AND TRIM) CLEAN AND PREPARE WOOD SURFACES FOR REPAINTING.

- 2. REMOVE AREAS OF WOOD DECAY TO SOUND SUBSTRATE, AND TREAT SURFACES WITH A WOOD CONSOLIDANT.
- 3. FILL VOIDS, HOLES, CRACKS, CHECKS OR GAPS WITH AN EPOXY PASTE AND FINISH TO MATCH SURROUNDING SURFACES.
- 4. REMOVE AREAS OF HEAVY WOOD DECAY OR LOSS, AND REPLACE PORTION OF MEMBER WITH WOOD DUTCHMEN TO MATCH.
- 5. REPLACE WOOD MEMBERS WHERE SHOWN ON DRAWINGS WITH NEW TO MATCH.
- 6. REPAINT EXTERIOR SURFACES AS SPECIFIED.

### **EXTERIOR METALWORK: (RAILINGS, GRILLES, ETC.)**

- 1. CLEAN AND PREPARE SURFACES FOR REPAINTING. 2. TREAT AREAS OF CORROSION WITH A CORROSION INHIBITOR, AND PRIME.
- 3. INSPECT HARDWARE AND CONNECTIONS. TIGHTEN WHERE LOOSE. REPLACE WHERE DAMAGED OR MISSING.
- 4. REPAINT STEEL SURFACES AS SPECIFIED.

### **EXTERIOR STEEL WINDOWS:**

INHIBITOR, AND PRIME.

- 1. EXISTING WINDOW SIZES SHOWN ARE NOMINAL. FIELD VERIFY ACTUAL SIZE.
- 2. CONTRACTOR TO ENSURE PROPER WORKING ORDER AND WEATHERTIGHTNESS.
- 3. CLEAN AND PREPARE SURFACES FOR REPAINTING. 4. TREAT AREAS OF CORROSION WITH A CORROSION
- 5. REPLACE BROKEN OR DAMAGED GLASS WHERE NOTED. 6. REMOVE CRACKED, LOOSE OR DE-BONDED GLAZING PUTTY
- AND INFILL WITH NEW PUTTY; MATCH EXISTING PROFILE. 7. REPAINT STEEL SURFACES AS SPECIFIED.
- 8. CLEAN AND LUBRICATE (E) HARDWARE.
- 9. INSTALL (N) PERIMETER SEALANT AT JOINT BETWEEN FRAME AND BUILDING WALLS.
- 10. INSTALL (N) WEATHERSTRIPPING.

## Architectural Resources Group

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### EAST EXTERIOR **ELEVATION**

**ISSUANCE** 

**HSPB SUBMITTAL** 

01/27/23

PROJ. NO. 220602

**EXTERIOR ELEVATION LEGEND** 


ADJACENT BUILDING,

NOT IN SCOPE

DRAWN BT/MGB

CHECKED

JC/SD/NOM

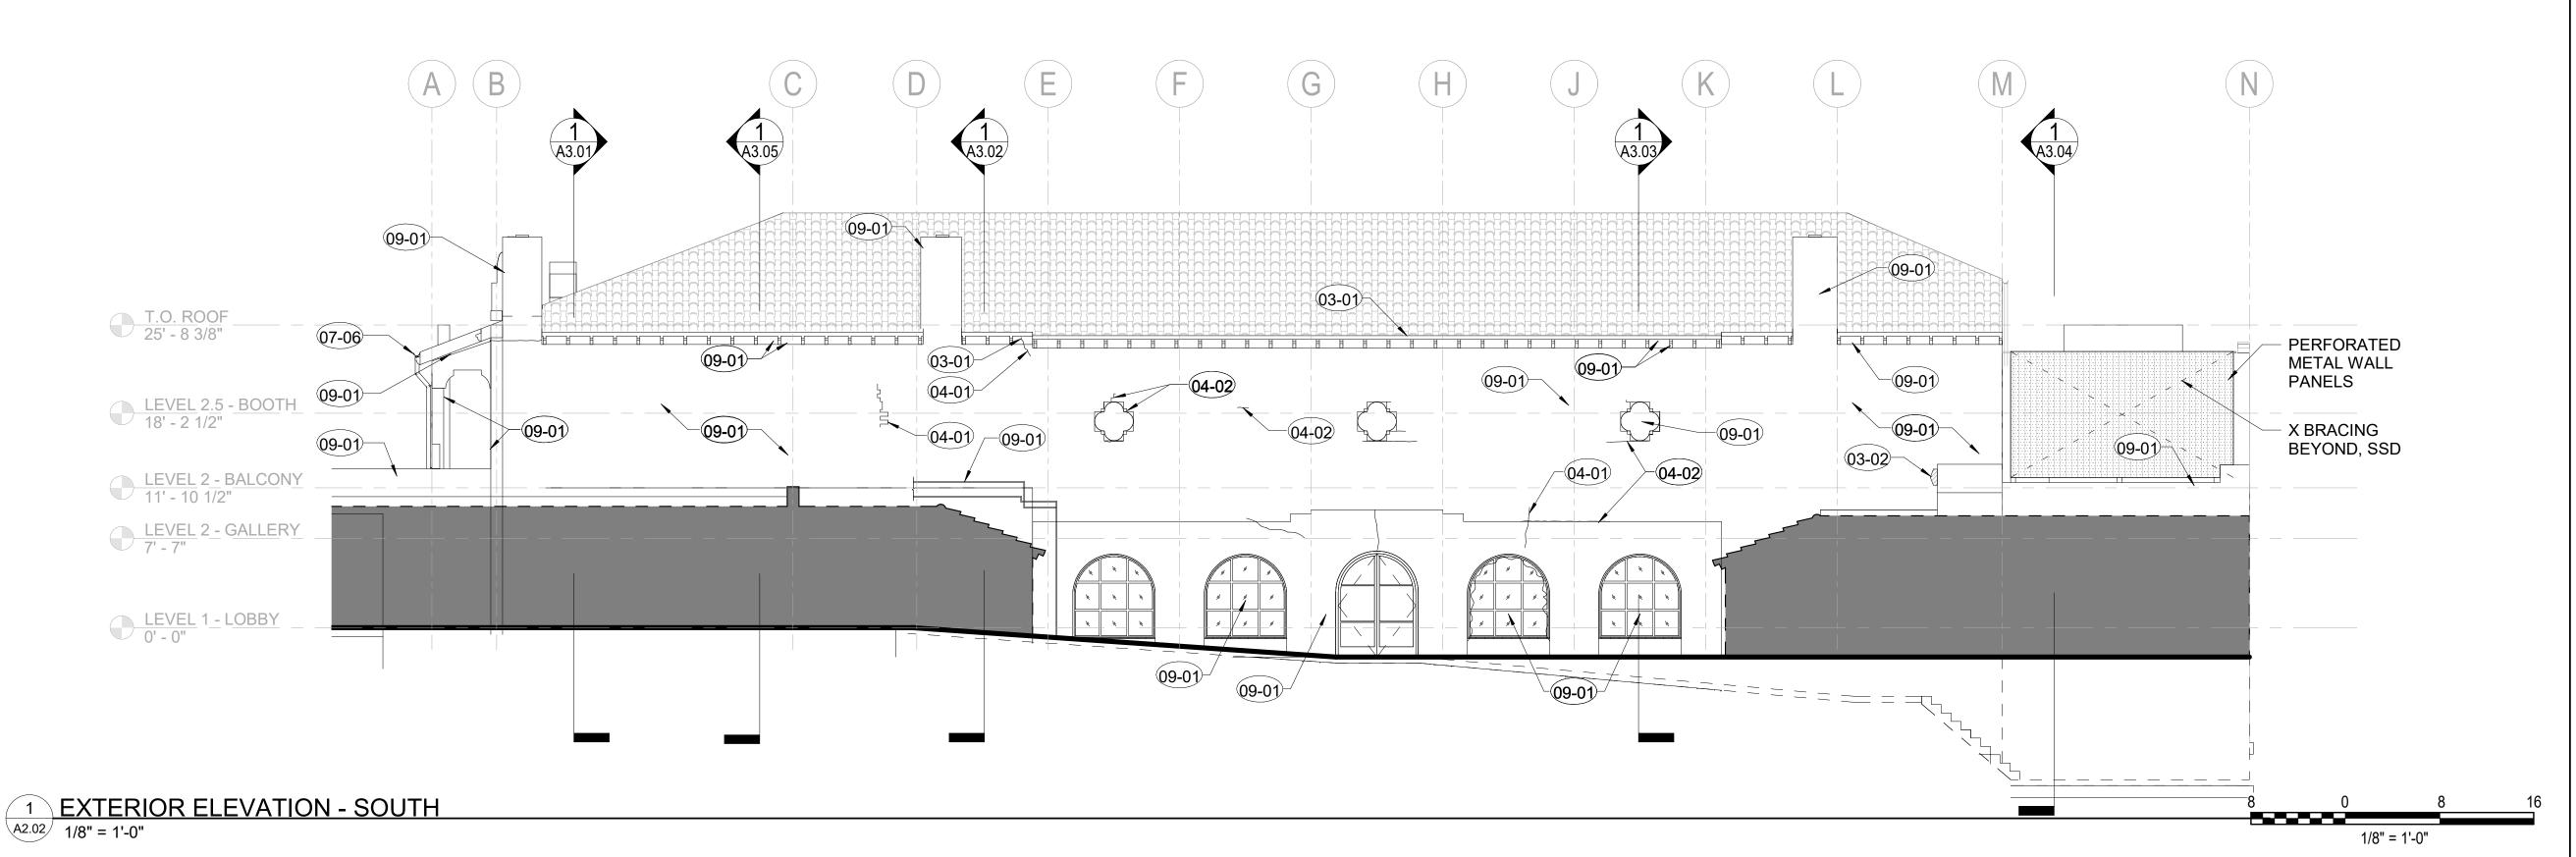

03-01 CONCRETE CRACK REPAIR

03-02 CONCRETE PATCH REPAIR

04-01 UNIT MASONRY CRACK REPAIR

04-02 UNIT MASONRY JOINT REPOINTING

REPAIR AND REPAINT (E) DRAINAGE SYSTEM 07-06

CLEAN, PREPARE AND REPAINT SURFACES

### EXTERIOR ELEVATION GENERAL NOTES

1. SUBMIT REPAIR SCHEDULE FOR ARCHITECT'S REVIEW INDICATING REPAIR LOCATIONS AND QUANTITIES PRIOR TO START OF WORK.

(COORDINATE WITH ALLOWANCES AND UNIT PRICES)

#### **EXTERIOR CONCRETE AND CMU MASONRY:** 1. REMOVE VEGETATION WHERE NOTED.

- 2. CLEAN AND PREPARE CONCRETE AND CMU SURFACES FOR REPAINTING.
- 3. REMOVE OBSOLETE OR ABANDONED FASTENERS, WIRING, NAILS, ETC. AND PATCH HOLES
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- 5. SAWCUT AND REPOINT MORTAR JOINTS WHERE
- DETERIORATED OR MISSING.
- 6. REPAINT CMU MASONRY SURFACES AS SPECIFIED.

### EXTERIOR WOOD: (RAFTER TAILS, EXPOSED DECKING AND TRIM)

- I. CLEAN AND PREPARE WOOD SURFACES FOR REPAINTING. 2. REMOVE AREAS OF WOOD DECAY TO SOUND SUBSTRATE, AND TREAT SURFACES WITH A WOOD CONSOLIDANT.
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- 5. REPLACE WOOD MEMBERS WHERE SHOWN ON DRAWINGS WITH NEW TO MATCH.
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### **EXTERIOR METALWORK: (RAILINGS, GRILLES, ETC.)**

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- 8. CLEAN AND LUBRICATE (E) HARDWARE. 9. INSTALL (N) PERIMETER SEALANT AT JOINT BETWEEN FRAME AND BUILDING WALLS.
- 10. INSTALL (N) WEATHERSTRIPPING.

### **EXTERIOR ELEVATION LEGEND**



ADJACENT BUILDING, NOT IN SCOPE

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SOUTH EXTERIOR **ELEVATION** 

**ISSUANCE** 

**HSPB SUBMITTAL** 


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07-01 NEW MEMBRANE ROOF

07-03 REPAIR (E) CLAY TILE ROOF, SEE NOTES ON ROOF PLAN

07-06 REPAIR AND REPAINT (E) DRAINAGE SYSTEM CLEAN, PREPARE AND REPAINT SURFACES 09-01

### EXTERIOR ELEVATION GENERAL NOTES

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(COORDINATE WITH ALLOWANCES AND UNIT PRICES)
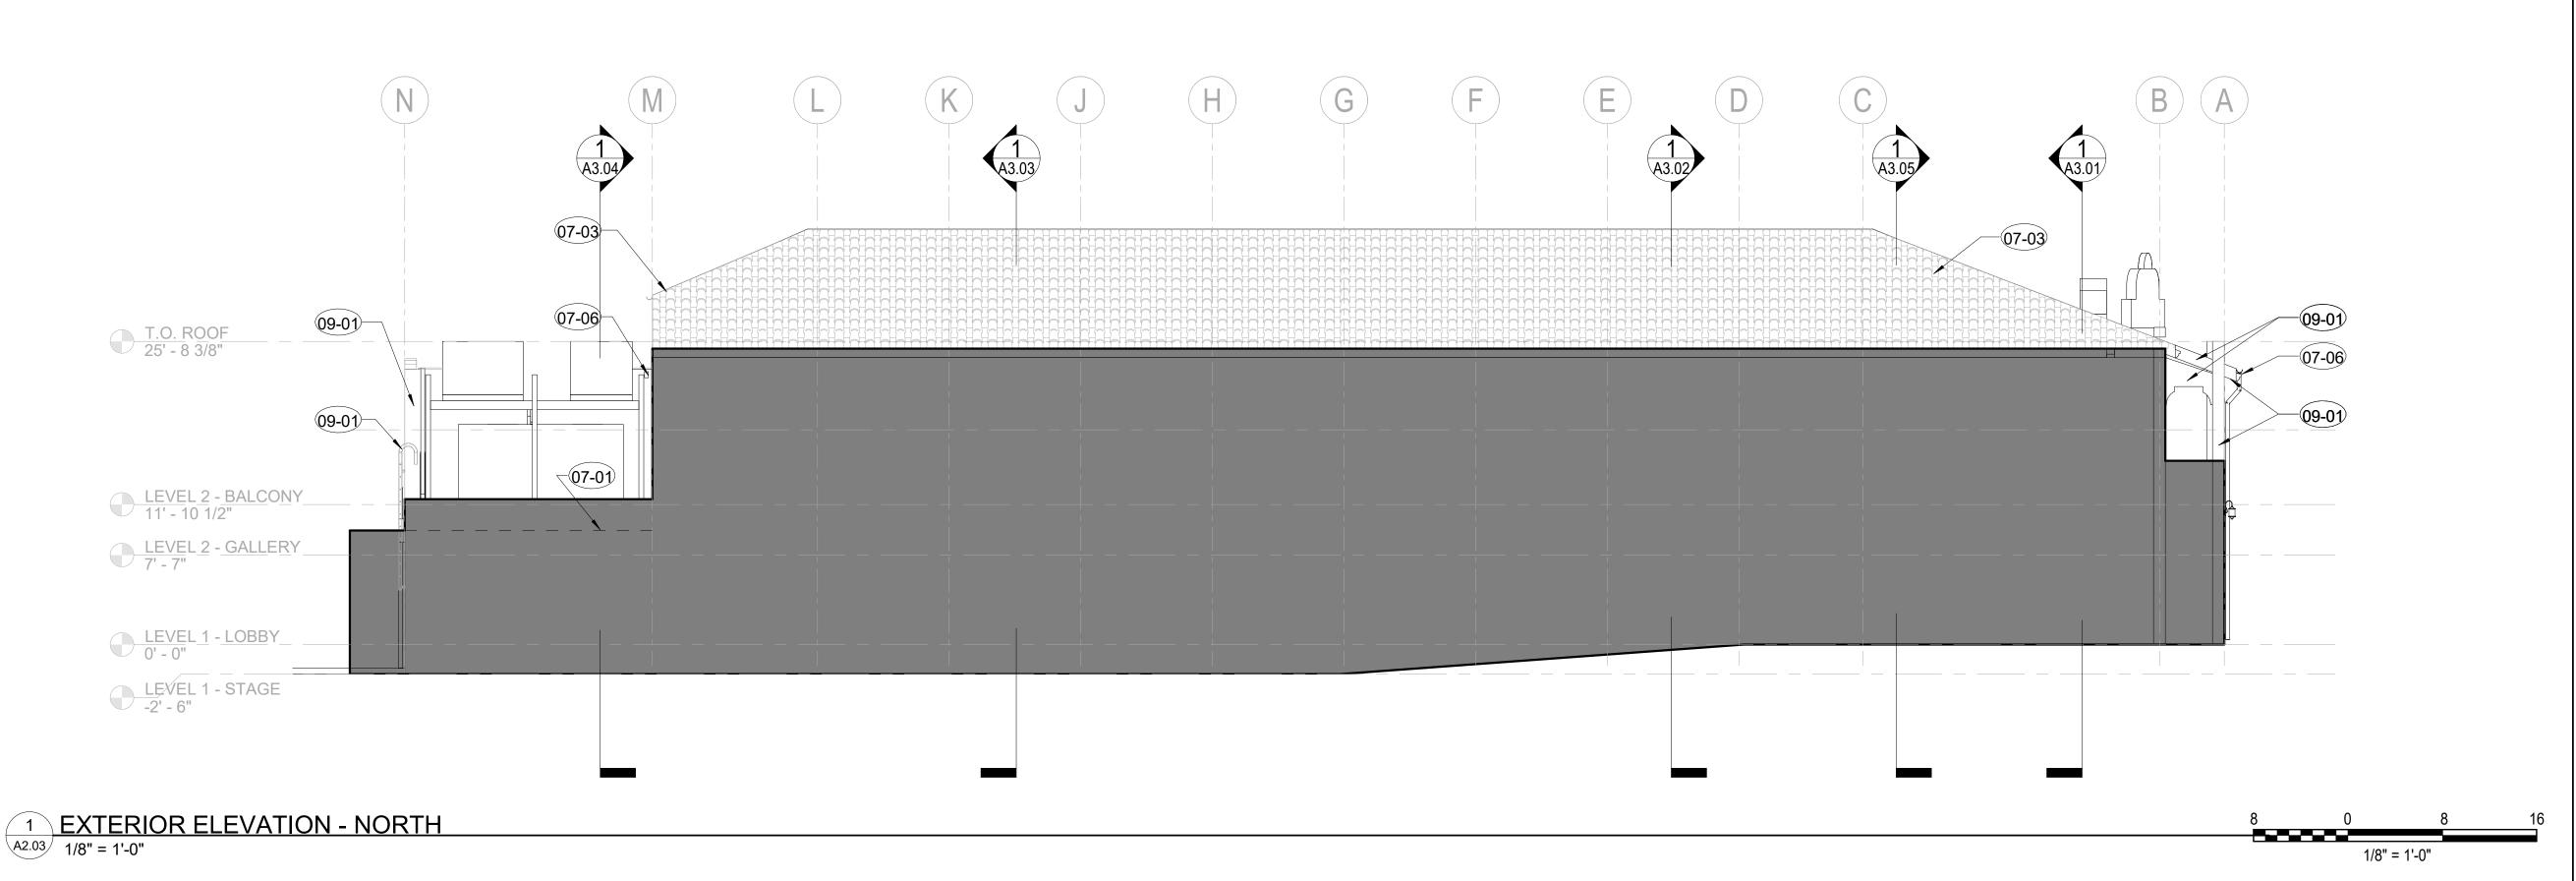
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### NORTH EXTERIOR **ELEVATION**

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PROJ. NO. 220602

**EXTERIOR ELEVATION LEGEND** 


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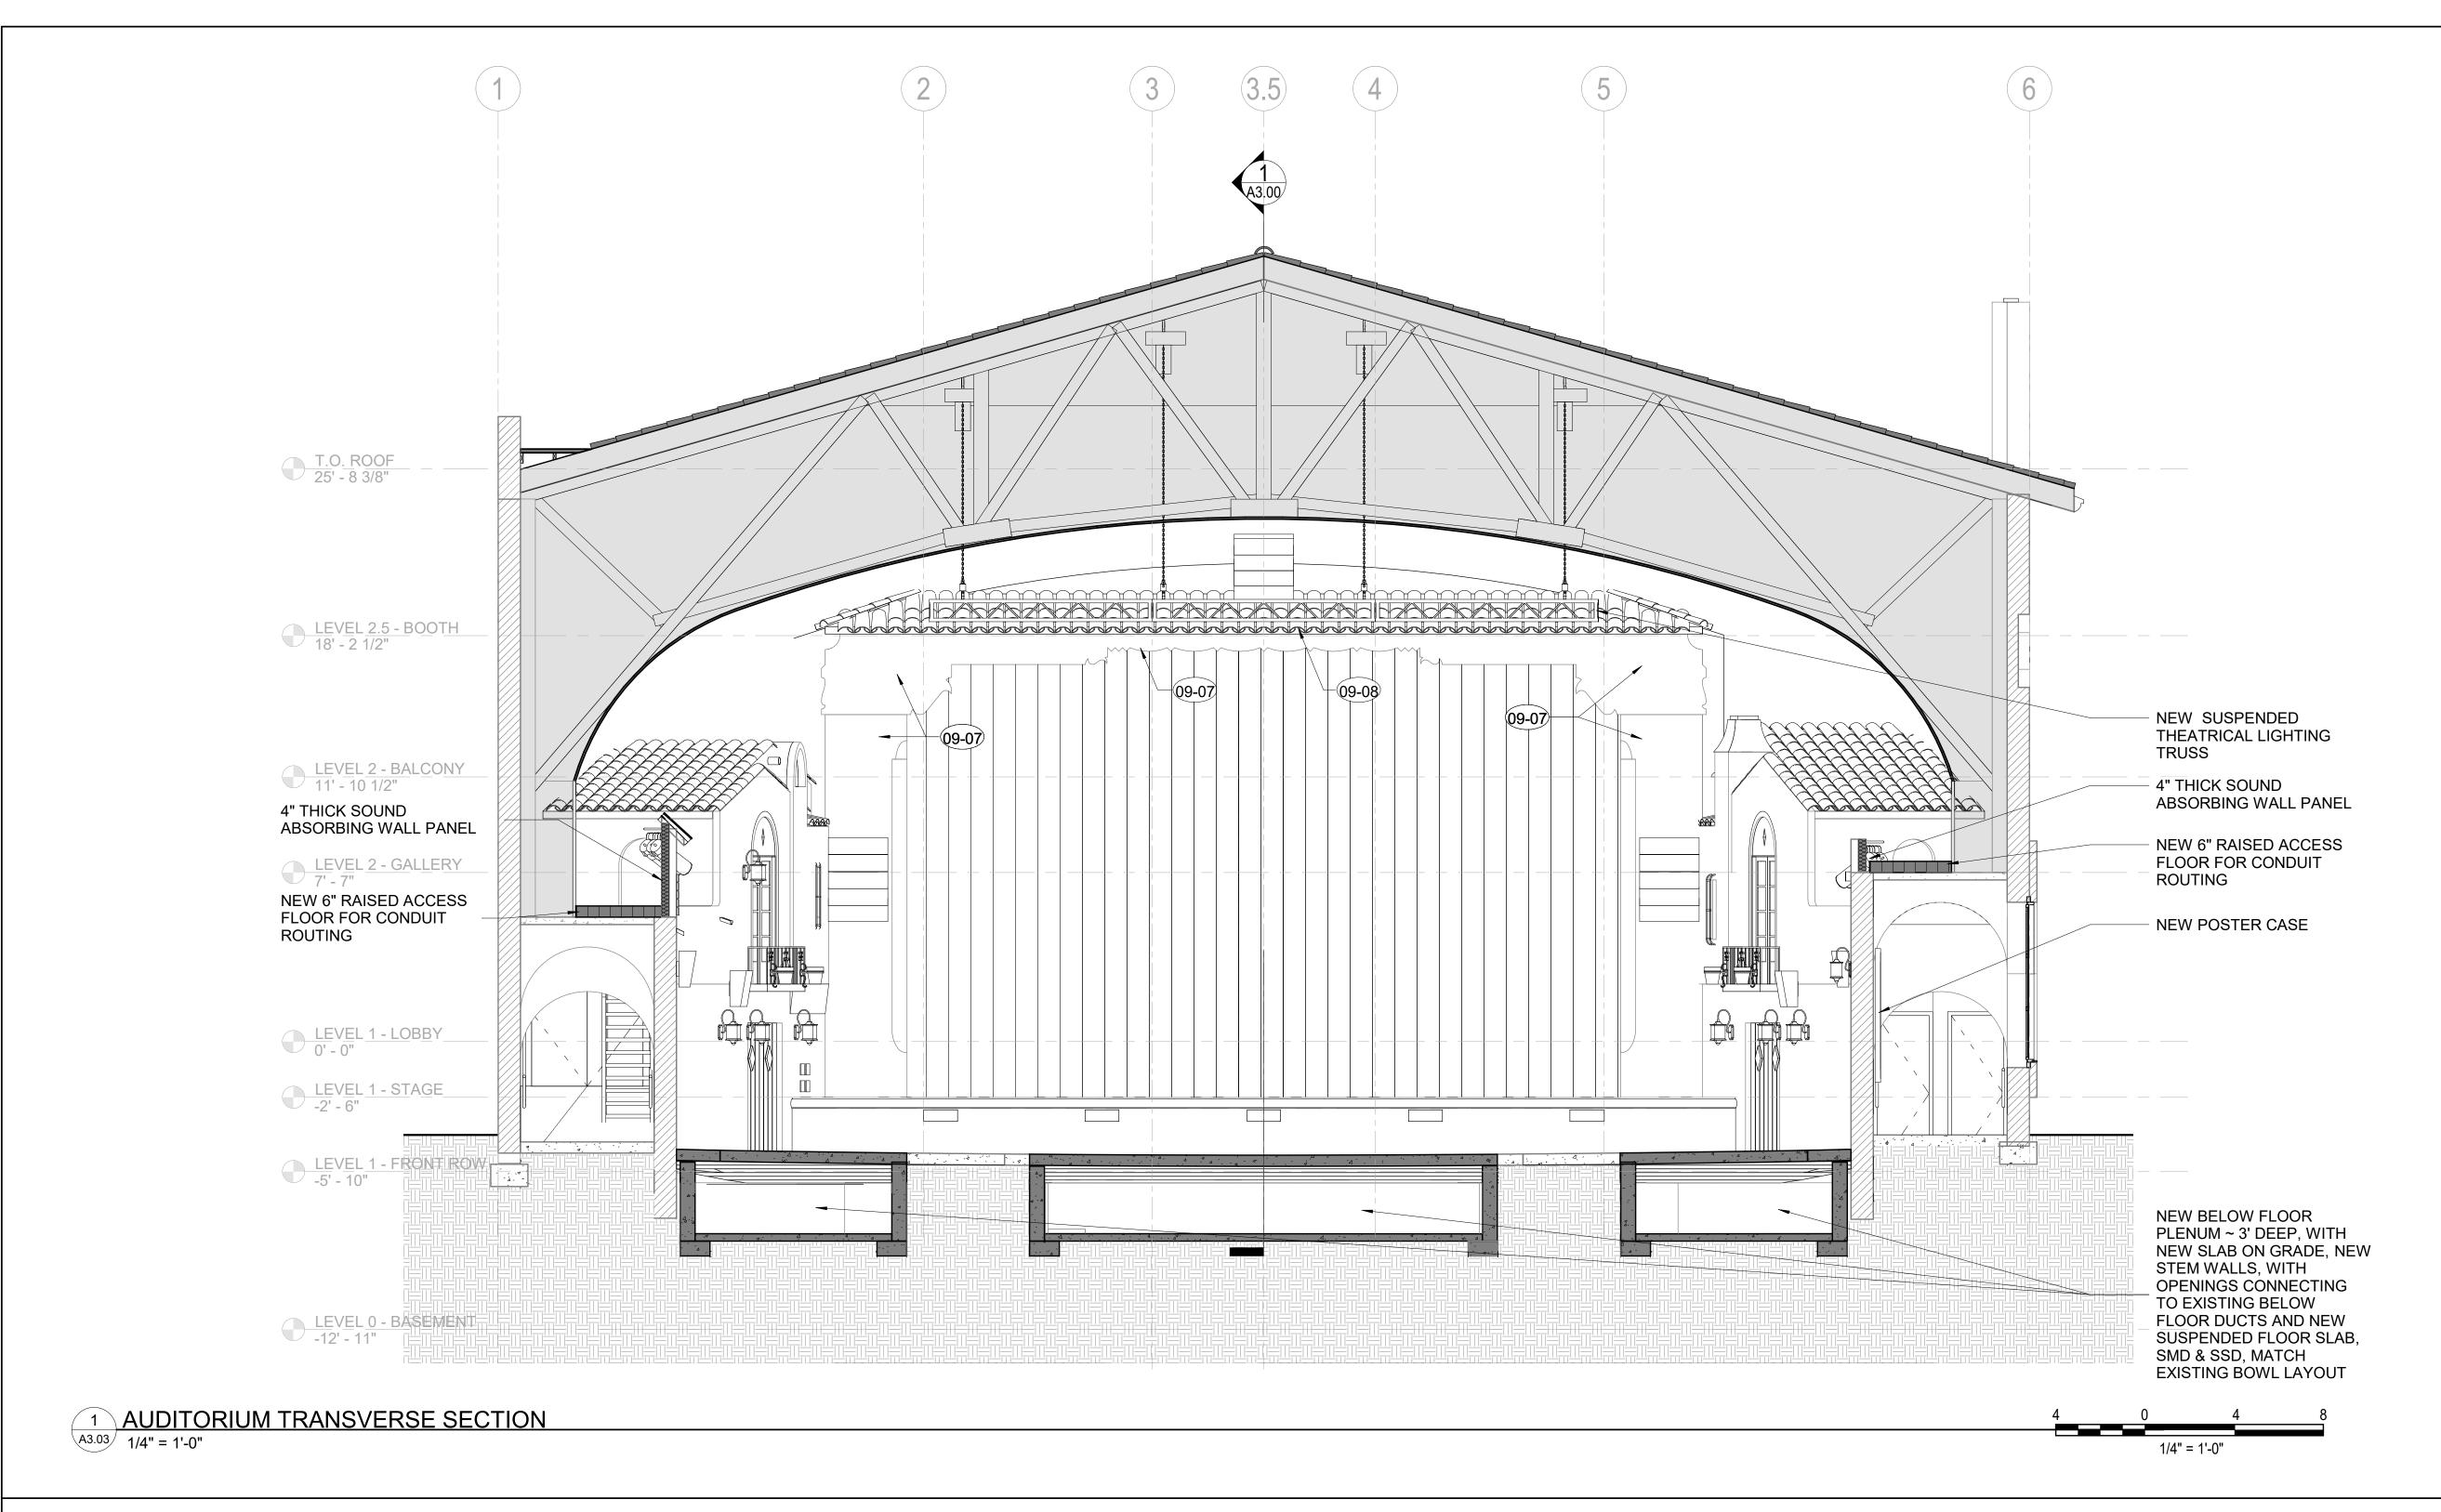
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BT/MGB

CHECKED JC/SD/NOM





**GENERAL SECTION NOTES** 

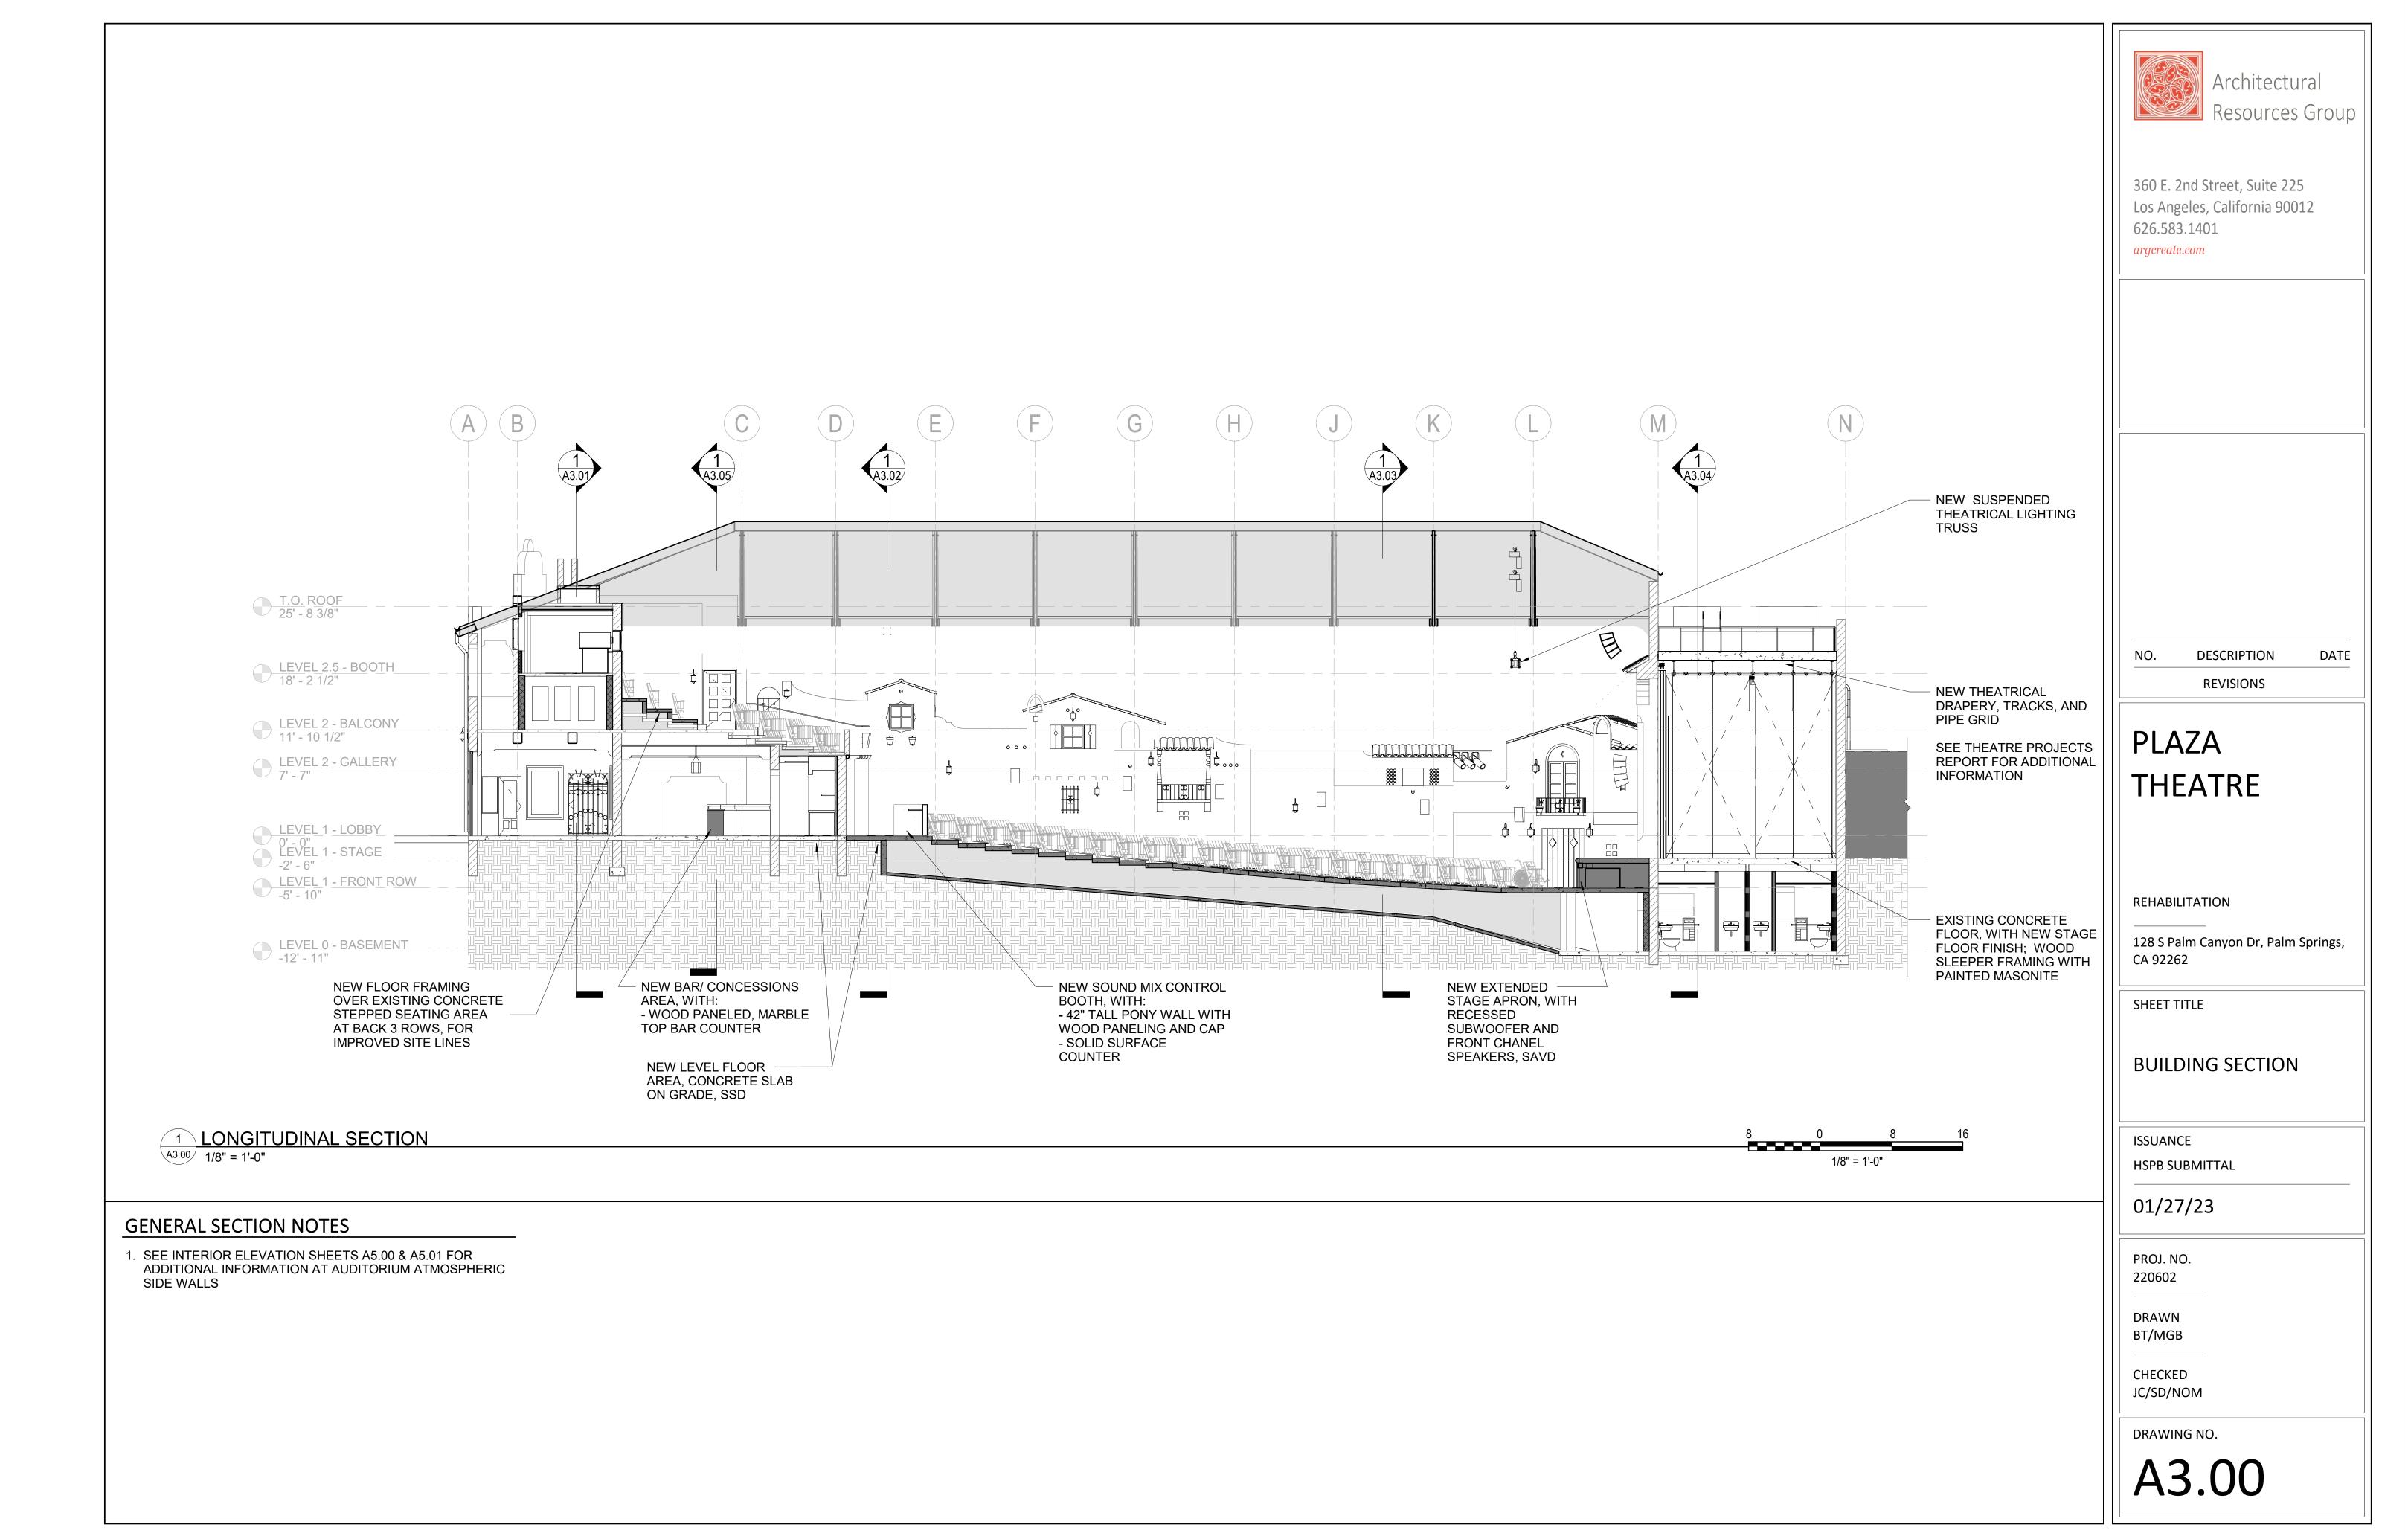1. CAREFULLY REMOVE (E) NON-ORIGIAL FURRING, INCLUDING WOOD FRAMING AND PLASTER FINISH SURROUNDING PROSCENIUM. SEE DEMO ELEVATION SHT. AD3.03.

- 2. PROTECT (E) HISTORIC DECORATIVELY PAINTED CONCRETÉ PROSCENIUM BELOW.
- 3. PERFORM A VISUAL INSPECTION OF CONCRETE SURFACES, AND NOTIFY ARCHITECT OF ANY DAMAGE.
- 4. SUBMIT REPAIR SCHEDULE FOR ARCHITECT'S REVIEW INDICATING REPAIR LOCATIONS AND QUANTITIES PRIOR TO START OF WORK. (COORDINATE WITH ALLOWANCES AND UNIT PRICES).
- 5. SEE INTERIOR ELEVATION SHEETS A5.00 & A5.01 FOR ADDITIONAL INFORMATION AT AUDITORIUM ATMOSPHERIC SIDE WALLS

### DECORATIVELY PAINTED (STENCILED) CONCRETE PROSCENIUM:

- 1. BRUSH/VACUUM CLEAN TO REMOVE SURFACE SOILING.
- 2. CLEAN SURFACES AS SPECIFIED TO REMOVE STAINS, EFFLORESCENCE, NICOTINE, ETC. (CLEANING TO BE DETERMINED IN NEXT PHASE BY CONSERVATOR TESTING. LIKELY TO INCLUDE AQUEOUS AND/OR DETERGENT CLEANING BY HAND.)
- 3. REMOVE OBSOLETE OR ABANDONED FASTENERS, WIRING, NAILS, ETC.
- 4. PATCH LOSS AREAS AS SPECIFIED W/ A COMPATIBLE REPAIR MORTAR. FORM & FINISH PATCHES TO MATCH SURROUNDING SURFACES.
- 5. IN-PAINT AT AREAS OF PAINT LOSS OR REPAIR TO MATCH (E) DECORATIVE SCHEME.

### SHEET KEYNOTES

CLEAN AND TOUCH-UP DECORATIVE PAINT 09-08 CLEAN INTERIOR DECORATIVE ROOF TILE

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SHEET TITLE

### **BUILDING SECTION**

**ISSUANCE** 

**HSPB SUBMITTAL** 

01/27/23


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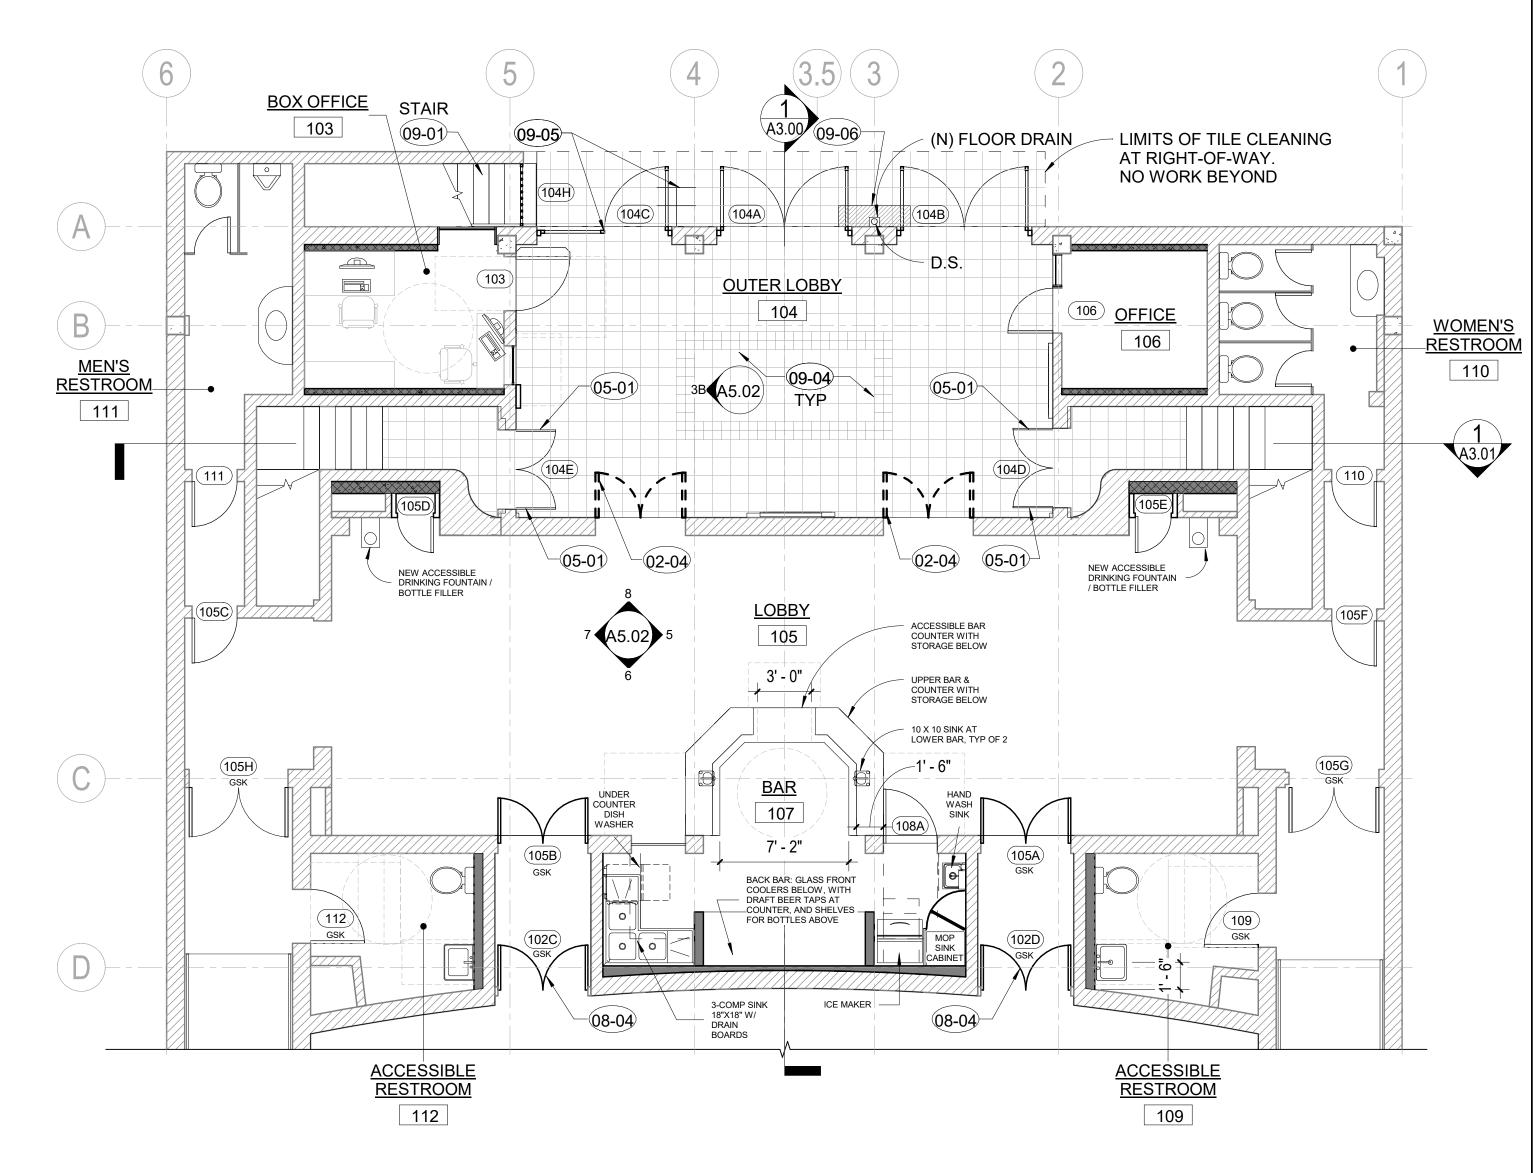
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DRAWING NO.

JC/SD/NOM





1 ENLARGED PLAN - LOBBY 3/16" = 1'-0"
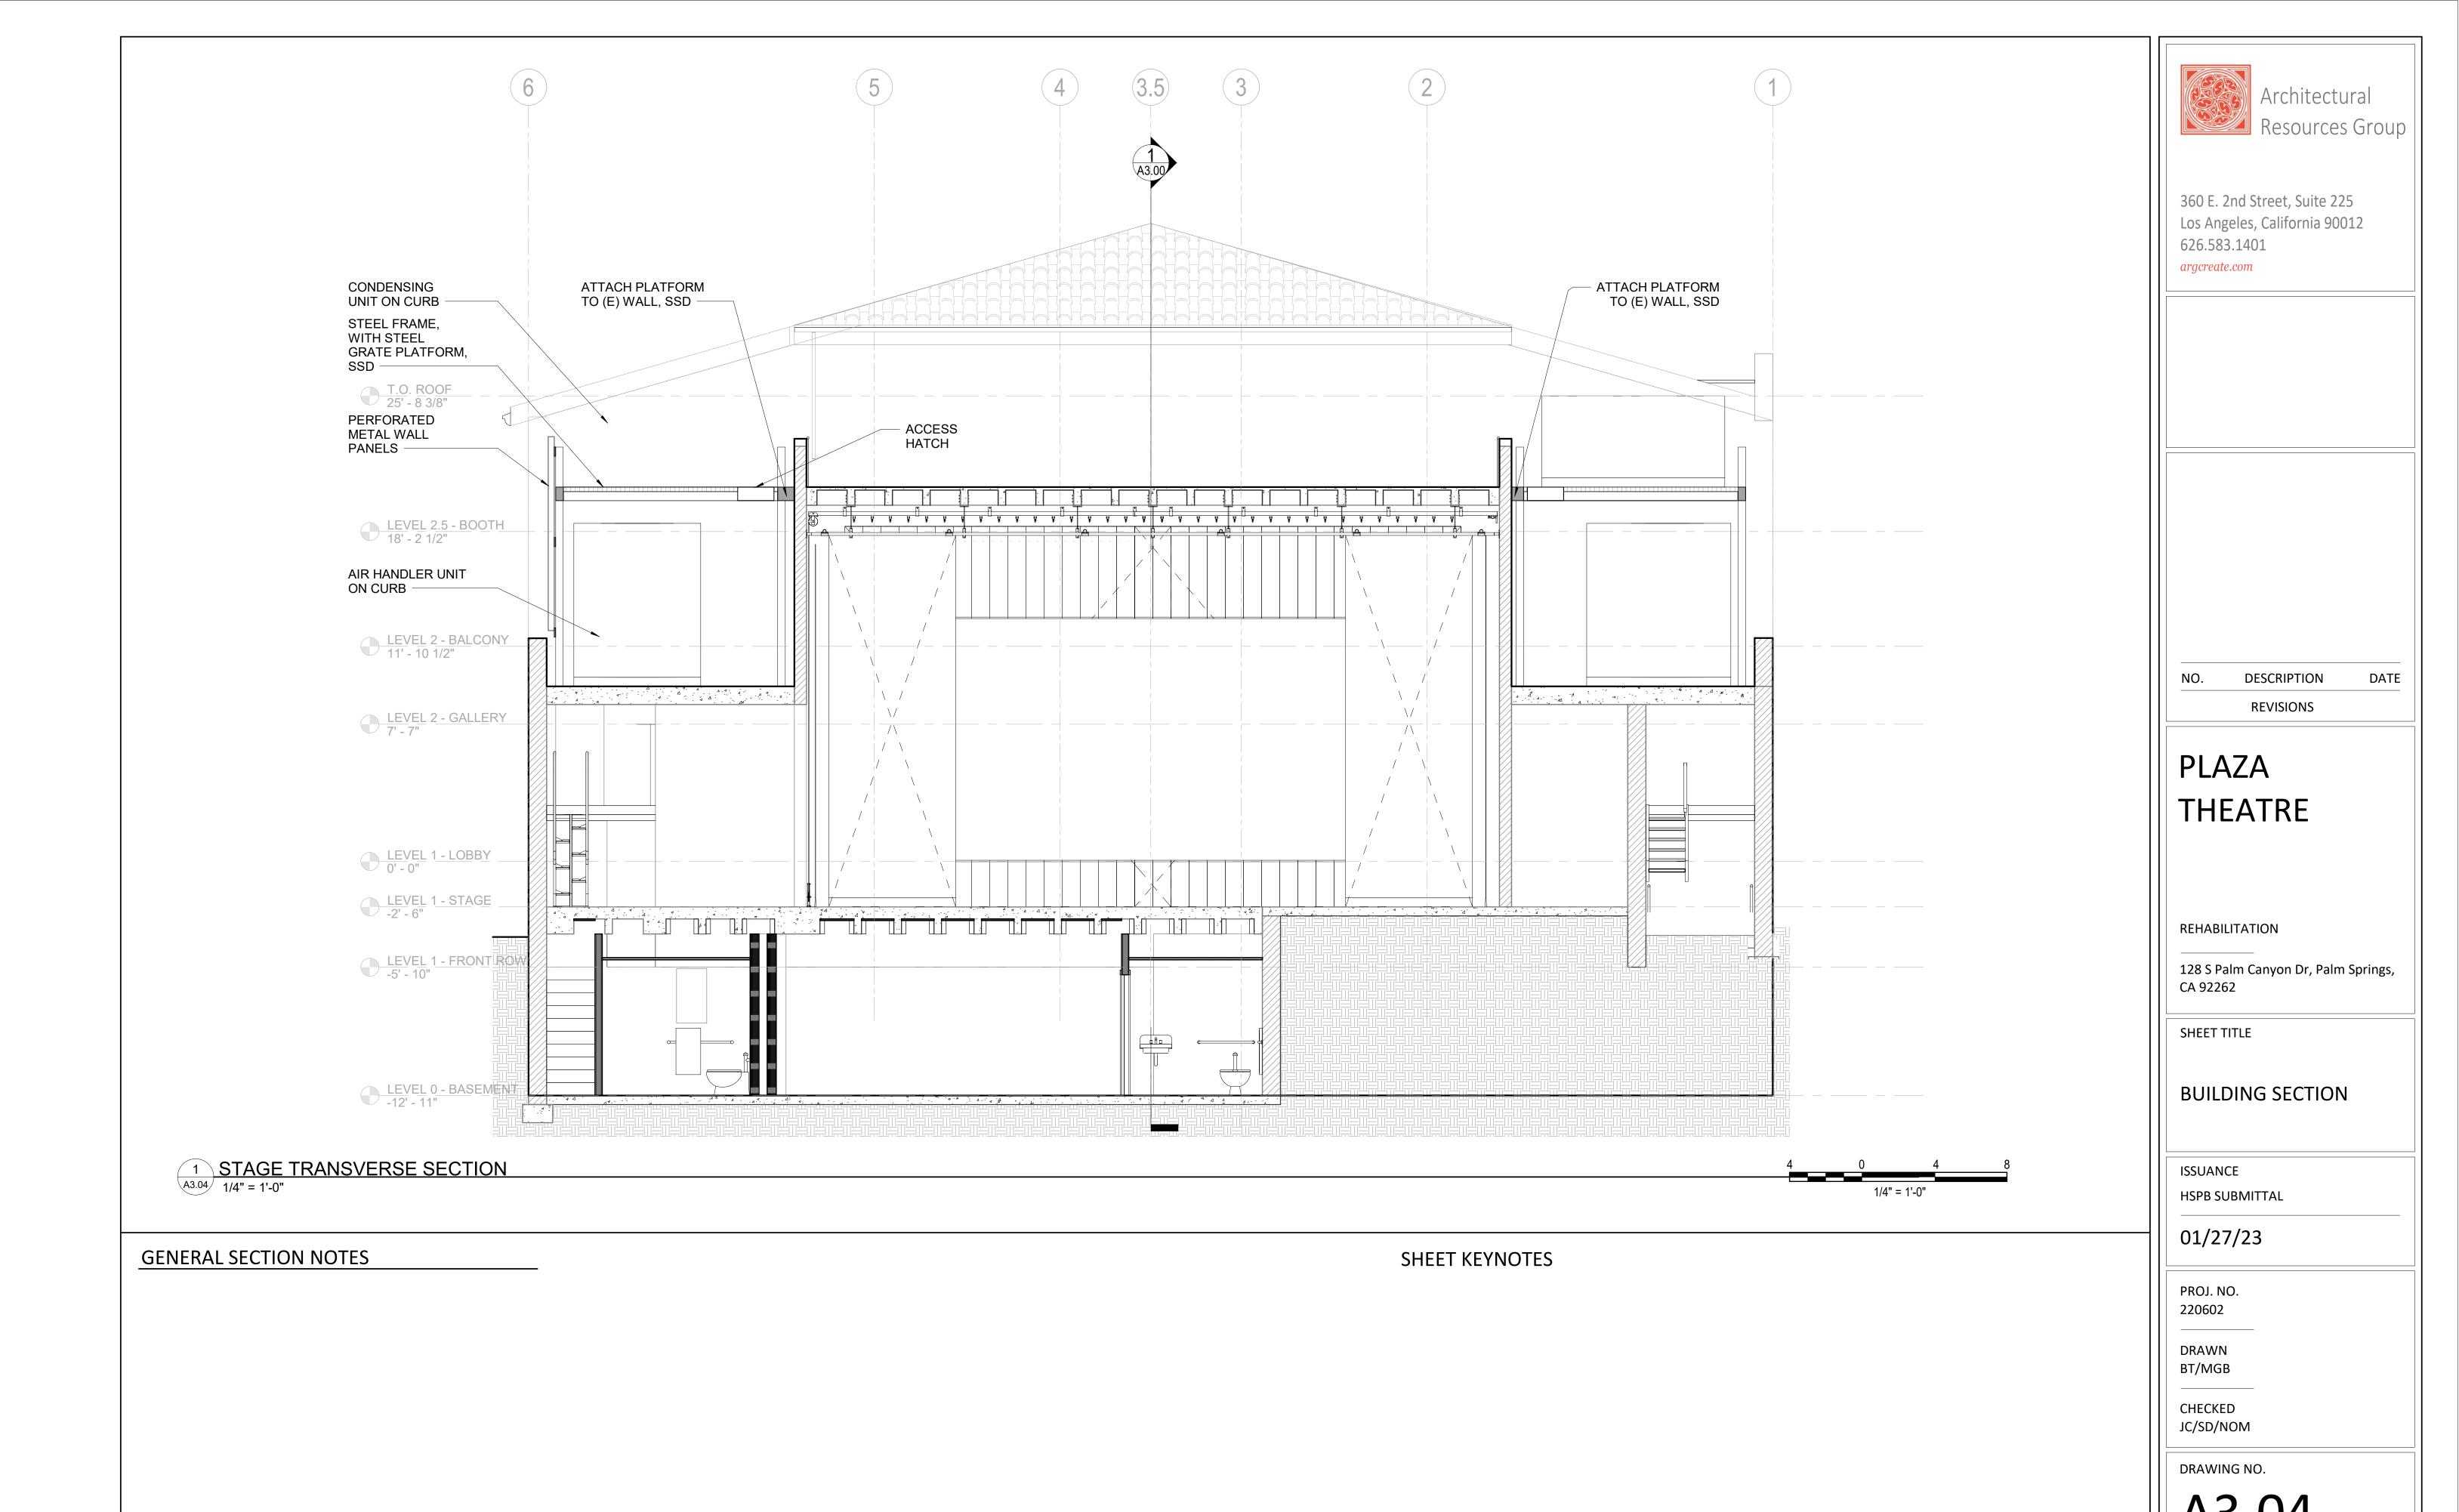
# 1/4" = 1'-0"

# SHEET KEYNOTES

05-01

09-04

02-04 SALVAGE (E) DOORS FOR REUSE

REPAIR AND REPAINT (E) METALWORK (GRILLE, RAILING, ETC.)

08-04 REPAIR AND REINSTALL SALVAGED DOORS 09-01 CLEAN, PREPARE AND REPAINT SURFACES


CLEAN TILE AND GROUT SURFACES

09-05 RE-GROUT TILE JOINTS

REPLACE DAMAGED TILE W/NEW TO MATCH

ENLARGED PLAN GENERAL NOTES

## FLOOR PLAN LEGEND

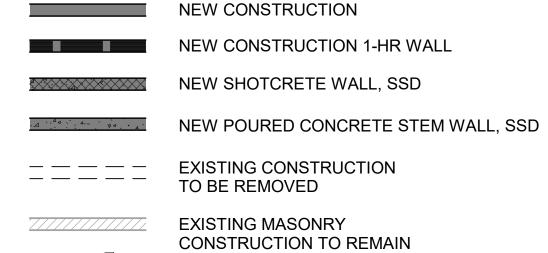

DOOR NUMBER

GSK DOORS TO RECEIVE ACOUSTICAL GASKETING

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# PLAZA THEATRE

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SHEET TITLE

**ENLARGED PLAN - LOBBY** 

ISSUANCE

HSPB SUBMITTAL

01/27/23

PROJ. NO. 220602

> DRAWN BT/MGB


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A4.00



7 LOBBY DECORATIVE CLG



4 OUTER LOBBY CLG & BEAM

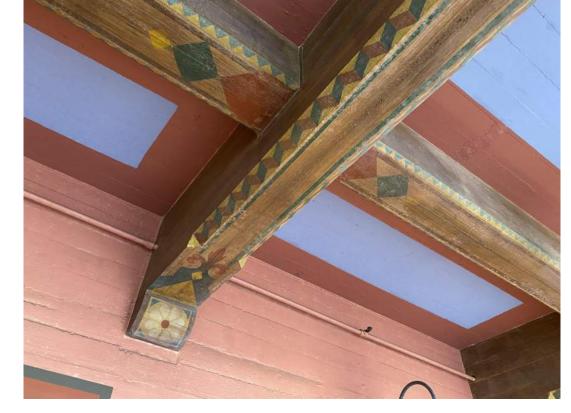

6 LOBBY DECORATIVE CLG 2





# REFLECTED CEILING PLAN - LOBBY

REMOVE OBSOLETE OR ABANDONED FASTENERS, HARDWARE, 02-02 ETC. AND PATCH HOLES

CONCRETE CRACK REPAIR 03-01

09-01 CLEAN, PREPARE AND REPAINT SURFACES

09-03 PLASTER PATCH REPAIR

CLEAN AND TOUCH-UP DECORATIVE PAINT

26-02 NEW LIGHT FIXTURE

SHEET KEYNOTES

26-03 DEMO (E) LIGHT FIXTURE 26-07 REPLACE LIGHT FIXTURE, COORDINATE WITH LIGHTING

DEMO EXISTING LIGHT FIXTURE AND INSTALL NEW, COORDINATE

WITH LIGHTING


# REFLECTED CEILING PLAN GENERAL NOTES

#### DECORATIVELY PAINTED (STENCILED) CEILING BORDERS AND **CONCRETE BEAMS:**


- 1. BRUSH/VACUUM CLEAN TO REMOVE SURFACE SOILING. 2. CLEAN SURFACES AS SPECIFIED TO REMOVE STAINS, EFFLORESCENCE, NICOTINE, ETC. (CLEANING TO BE DETERMINED IN NEXT PHASE BY CONSERVATOR TESTING. LIKELY TO INCLUDE AQUEOUS AND/OR DETERGENT CLEANING BY HAND.)
- 3. REMOVE OBSOLETE OR ABANDONED FASTENERS, WIRING, NAILS, ETC.
- 4. PATCH LOSS AREAS AS SPECIFIED W/ A COMPATIBLE REPAIR MORTAR. FORM & FINISH PATCHES TO MATCH SURROUNDING SURFACES.
- 5. IN-PAINT AT AREAS OF PAINT LOSS OR REPAIR TO MATCH (E) DECORATIVE SCHEME.

### PLASTER CEILINGS (SINGLE COLOR):

- 1. VACUUM CLEAN AND PREPARE SURFACES FOR REPAINTING.
- 2. REMOVE OBSOLETE OR ABANDONED FASTENERS, WIRING, NAILS, ETC.
- 3. PATCH LOSS AREAS AS SPECIFIED W/ A COMPATIBLE REPAIR MORTAR. FORM & FINISH PATCHES TO MATCH SURROUNDING SURFACES.
- 4. REPAINT PLASTER SURFACES AS SPECIFIED.

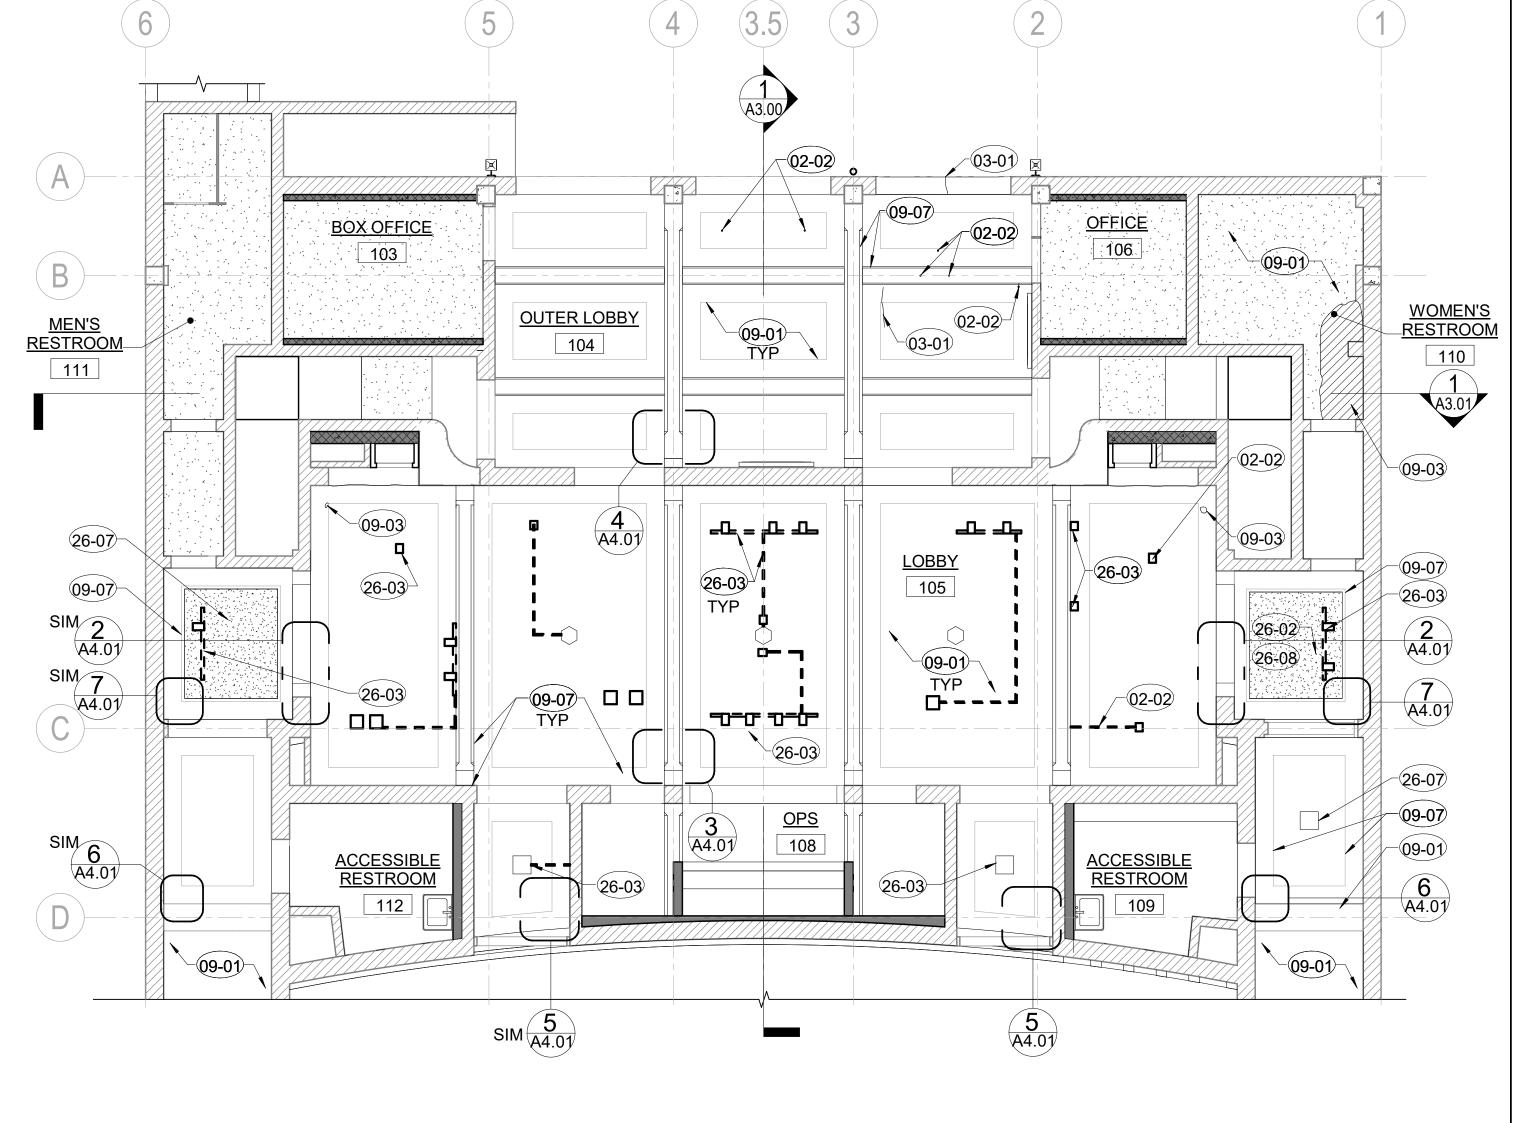

# A4.01 3/16" = 1'-0"

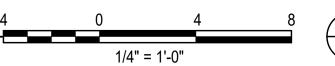

SHEET TITLE

**ENLARGED PLAN - LOBBY** 

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Architectural

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**REHABILITATION** 

CA 92262

**THEATRE** 

**ISSUANCE** 

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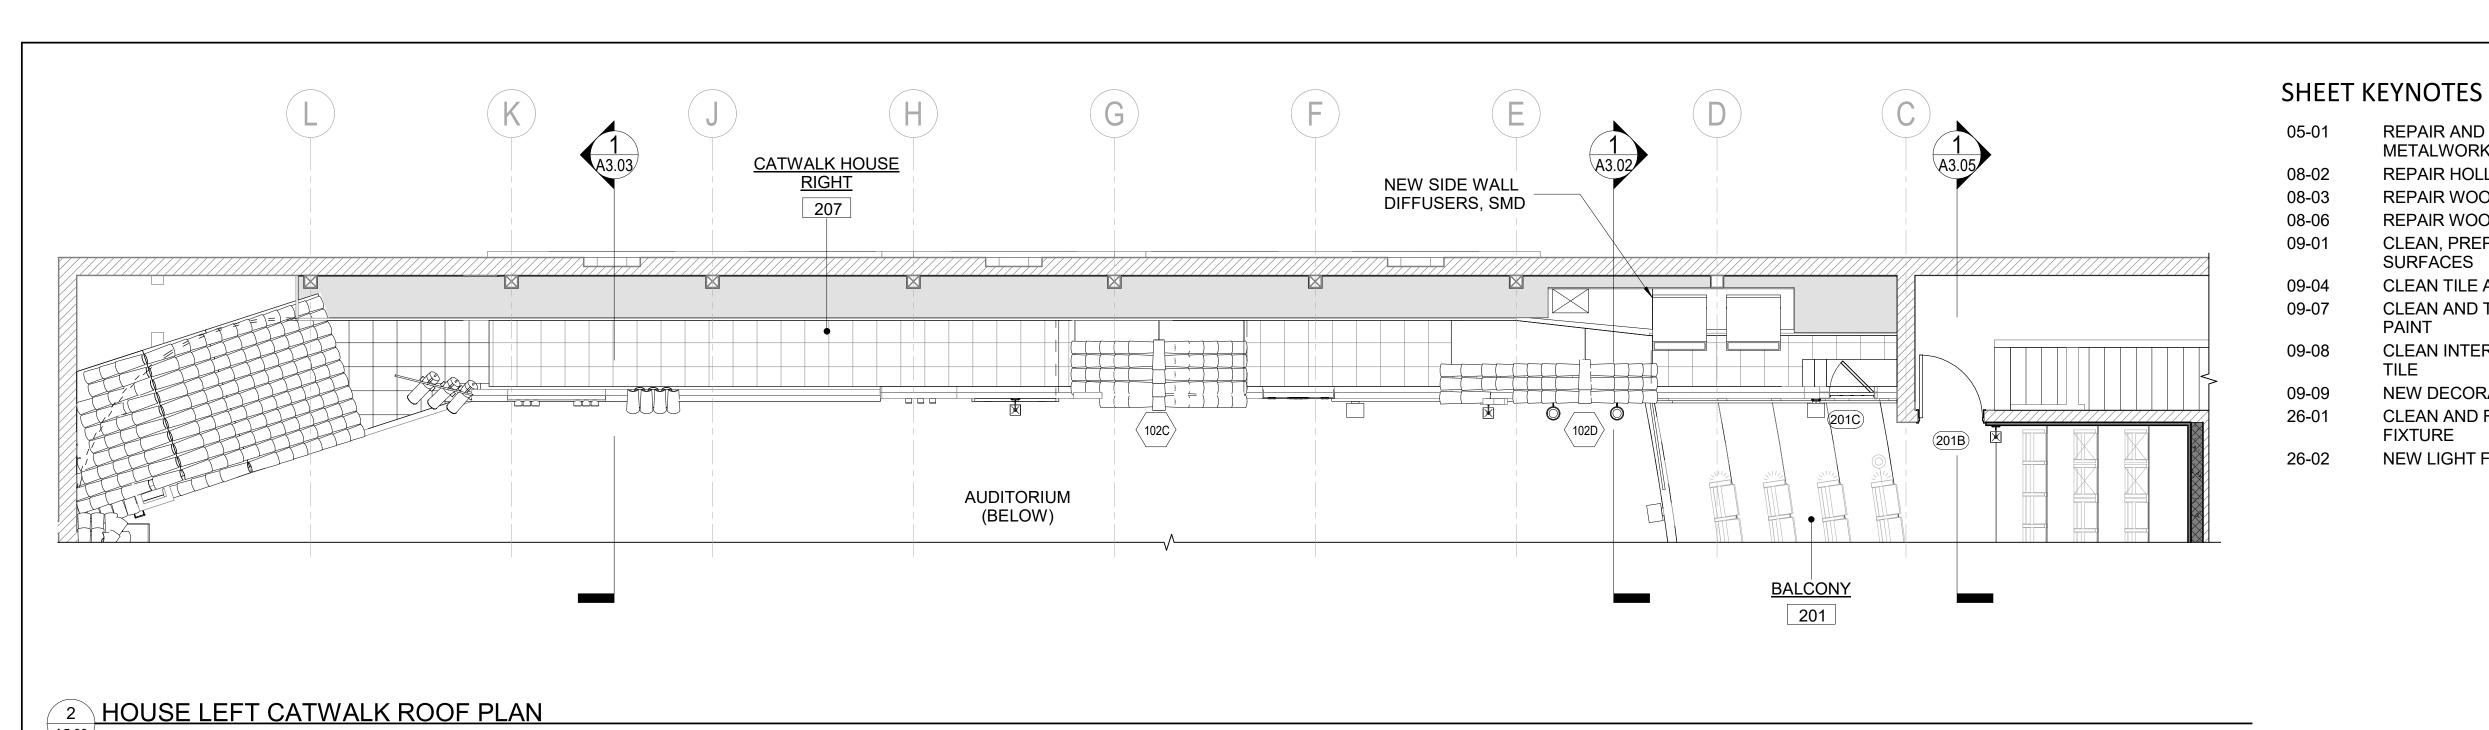
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RCP LEGEND

NEW SUSPENDED GYP. BD CEILING, PAINTED

NEW SUSPENDED PLASTER FINISH CEILING, MATCH TEXTURE FINISH AND PAINT COLOR

(E) CEILING TO REMAIN.



REPAIR AND REPAINT (E)

REPAIR WOOD DOOR

SURFACES

**FIXTURE** 

**REPAIR WOOD WINDOW** 

METALWORK (GRILLE, RAILING, ETC.)

REPAIR HOLLOW METAL DOOR

CLEAN, PREPARE AND REPAINT

CLEAN TILE AND GROUT SURFACES

CLEAN AND TOUCH-UP DECORATIVE

**CLEAN INTERIOR DECORATIVE ROOF** 

NEW DECORATIVE ROOF TILE

CLEAN AND REPAIR (E) LIGHT

**NEW LIGHT FIXTURE** 

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# **PLAZA**

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SHEET TITLE

**INTERIOR ELEVATIONS** 

**ISSUANCE** 

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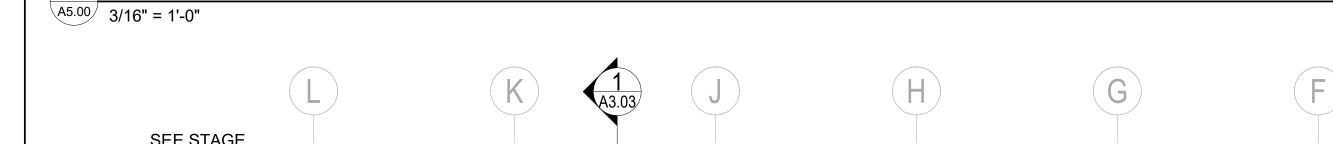
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SEE STAGE **ELEVATION NOTES,** SHT. A3.03 09-04 (N) DECORATIVE CHIMNEY TO 09-07 MATCH ORIGINAL DRAWINGS (METAL LATH AND PLASTER) LEVEL 2.5 - BOOTH 18' - 2 1/2" NEW PORTION OF 09-08 NEW BALCONETTE WALL TO MATCH -09-07 -05-01 WITH SALVAGED 08-06 ORIGINAL DRAWINGS (METAL LATH AND 26-01) \(\text{09-07} **DECORATIVE IRON** RAILING PLASTER) LEVEL 2 - BALCONY 11' - 10 1/2" **-**09-09 09-08 -(08-03) ⟨102C⟩ LEVEL 2 - GALLERY 000 NEW POTTED PLANTS IN PROVIDE NEW 4" THICK 26-02 -(26-02) METAL WALL HANGERS SOUND ABSORBING ACOUSTICAL WALL PANEL 26-02 AT BACK AND SIDE WALLS BOTH SIDES OF UPPER BALCONY TYP LEVEL 1 - LOBBY LEVEL 1 - STAGE **NEW OPENING AND** DECORATIVE METAL GRILL LEVEL 1 - FRONT ROW (N) OPENINGS WITH DECORATIVE IRON GRILLES

A5.00 3/16" = 1'-0"

<u>INTERIOR ELEVATION - AUDITORIUM - SOUTH</u>

# **INTERIOR ELEVATION GENERAL NOTES**

### **INTERIOR PLASTER:**

- 1. VACUUM CLEAN AND PREPARE SURFACES FOR REPAINTING.
- 2. REMOVE OBSOLETE OR ABANDONED FASTENERS, WIRING, NAILS, ETC. AND PATCH HOLES
- 3. ROUT OUT AND FILL CRACKS WHERE NOTED AND ANY OTHER CRACKS AT FACADES THAT ARE 1/8-INCH OR WIDER. FILL AS SPECIFIED WITH A COMPATIBLE CEMENTITIOUS REPAIR MORTAR AND FINISH FLUSH WITH SURROUNDING SURFACES
- 4. CHIP AWAY AND REMOVE LOOSE OR UNSOUND MATERIAL TO SOUND SUBSTRATES & PREPARE FOR PATCHING.
- 5. IF (E) EMBEDDED REINFORCEMENT IS EXPOSED, PREPARE SURFACES & TREAT REBAR W/ A CORROSION INHIBITOR PRIOR TO PATCHING.
- 6. PATCH LOSS AREAS AS SPECIFIED W/ A COMPATIBLE REPAIR MORTAR. FORM & FINISH PATCHES TO MATCH SURROUNDING SURFACES.
- 7. REPAINT PLASTER SURFACES AS SPECIFIED.

### INTERIOR/EXTERIOR QUARRY TILE FLOORS:

- CLEAN TILE AND GROUT SURFACES AS SPECIFIED.
- 2. SAWCUT AND REPLACE GROUT JOINTS WHERE DETERIORATED OR MISSING.
- 3. REPLACE CRACKED, BROKEN OR OTHERWISE DAMAGED TILE W/NEW TO MATCH.

### **INTERIOR WOOD DOORS:**

- 1. EXISTING DOOR SIZES SHOWN ARE NOMINAL. FIELD VERIFY ACTUAL SIZE.
- 2. CONTRACTOR TO ENSURE PROPER WORKING ORDER AND WEATHERTIGHTNESS.
- 3. CLEAN AND PREPARE SURFACES FOR REPAINTING. 4. REMOVE ALL NAILS, FASTENERS, AND EXTRANEOUS OR OBSOLETE HARDWARE. FILL ALL HOLES IN ASSEMBLY AS

REQUIRED PRIOR TO APPLICATION OF FINISH.

5. REMOVE AREAS OF WOOD DECAY AND TREAT WITH A WOOD CONSULTANT. FILL ANY VOIDS, HOLES, CRACKS OR GAPS WITH AN EPOXY PASTE, AND FINISH TO MATCH SURROUNDING SURFACES.

### INTERIOR WOOD DOORS (CONT):

PROFILE.

- 6. REPLACE BROKEN OR DAMAGED GLASS WHERE NOTED... 7. REMOVE CRACKED, LOOSE OR DE-BONDED GLAZING PUTTY AND INFILL WITH NEW PUTTY; MATCH EXISTING
- 8. REPAINT WOOD SURFACES AS SPECIFIED.
- 9. CLEAN AND LUBRICATE (E) HARDWARE.
- 10. INSTALL (N) PERIMETER SEALANT AT JOINT BETWEEN FRAME AND BUILDING WALLS.
- 11. INSTALL (N) ACOUSTICAL GASKETS.

### **INTERIOR HOLLOW METAL DOORS:**

INHIBITOR, AND PRIME.

- 1. EXISTING DOOR SIZES SHOWN ARE NOMINAL. FIELD VERIFY ACTUAL SIZE.
- 2. CONTRACTOR TO ENSURE PROPER WORKING ORDER. 3. CLEAN AND PREPARE SURFACES FOR REPAINTING. 4. TREAT AREAS OF CORROSION WITH A CORROSION

#### 5. REPLACE BROKEN OR DAMAGED GLASS WHERE NOTED. 6. REMOVE CRACKED, LOOSE OR DE-BONDED GLAZING PUTTY AND INFILL WITH NEW PUTTY; MATCH EXISTING

- PROFILE. 7. REPAINT METAL SURFACES AS SPECIFIED.
- 8. WHERE REQ'D, REPAINT TO MATCH (E) WOOD GRAIN EFFECT.
- 9. CLEAN AND LUBRICATE (E) HARDWARE.

**INTERIOR HOLLOW METAL DOORS (CONT):** 


# INTERIOR ELEVATION LEGEND

3/16" = 1'-0"


**EXISTING CONSTRUCTION** TO REMAIN

NEW CONSTRUCTION

ACOUSTICAL WALL PANELS

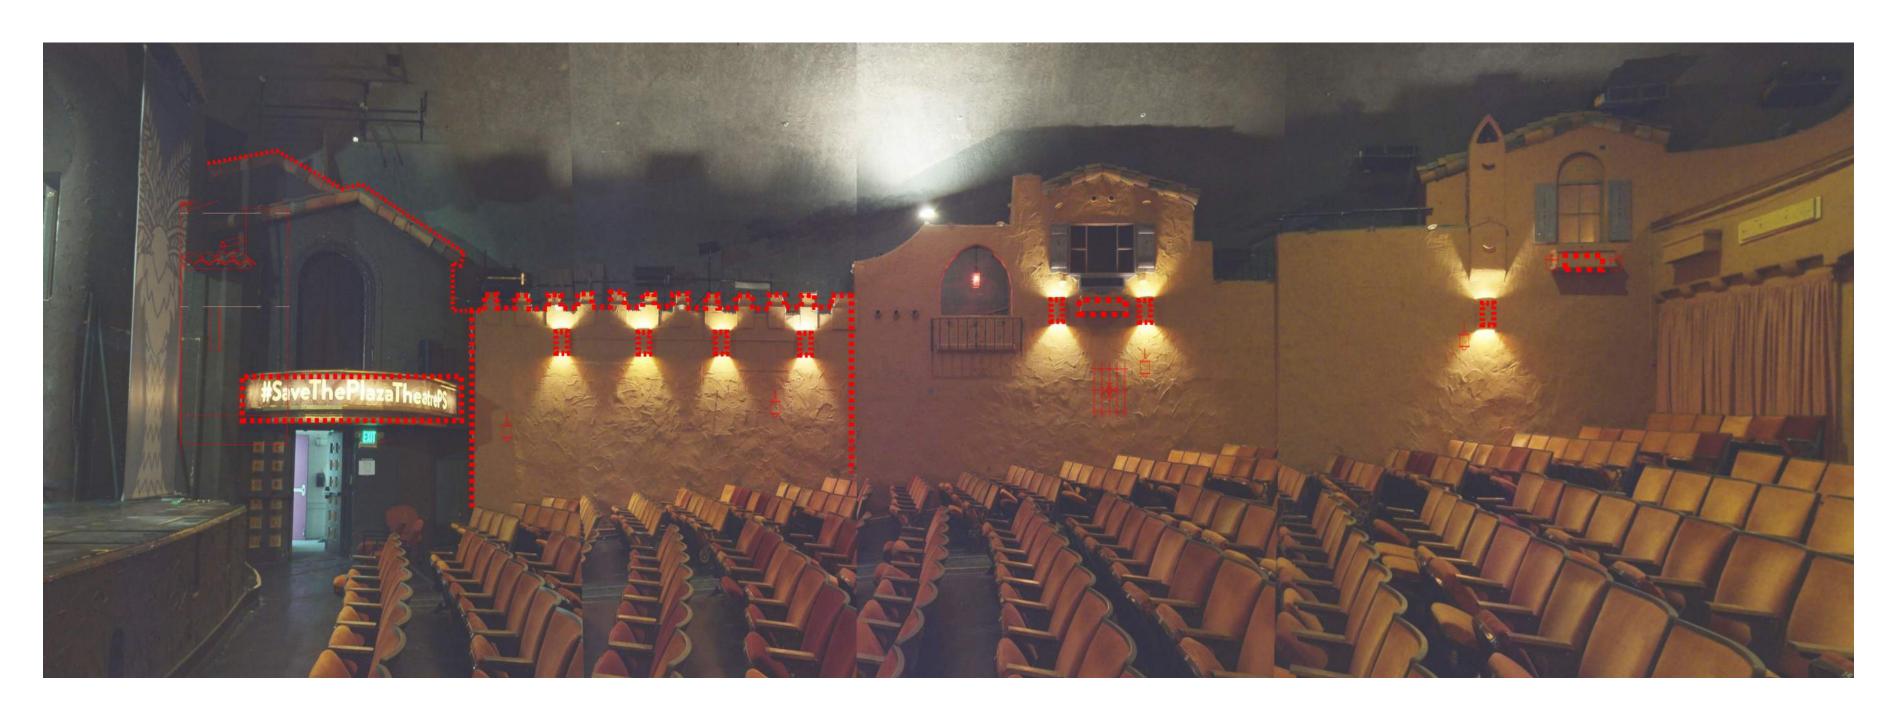

EXISTING ATMOPSPHERIC SIDEWALL CONDITION PHOTO WITH NON-ORIGINAL, AND MISSING ORIGINAL ELEMENTS HIGHLIGHTED

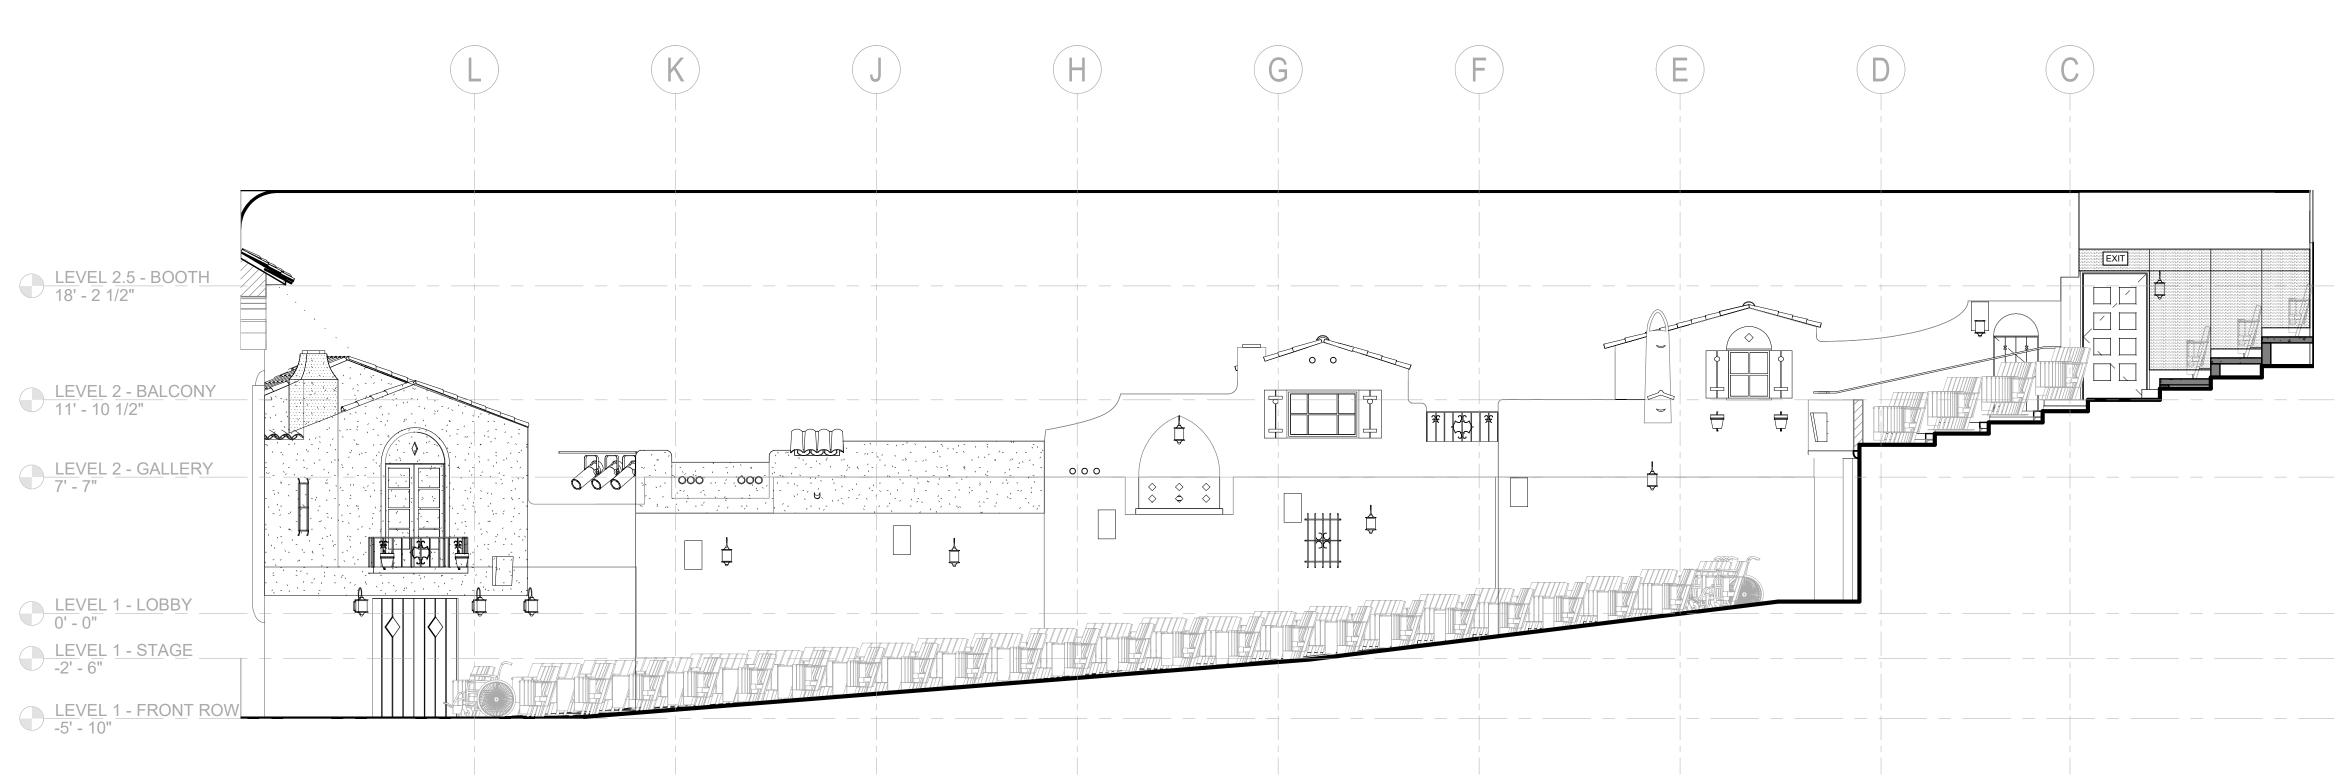

PROPOSED ATMOPSPHERIC SIDEWALL REHABILITATED TO ORIGINAL CONDITION

3/16" = 1'-0"



360 E. 2nd Street, Suite 225 Los Angeles, California 90012 626.583.1401

argcreate.com

. DESCRIPTION

DATE

**REVISIONS** 

# PLAZA THEATRE

REHABILITATION

128 S Palm Canyon Dr, Palm Springs, CA 92262

SHEET TITLE

INTERIOR COMPARISON

ISSUANCE

HSPB SUBMITTAL

01/27/23

PROJ. NO. 220602


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Author

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DRAWING NO.

A5.00-A



### SHEET KEYNOTES

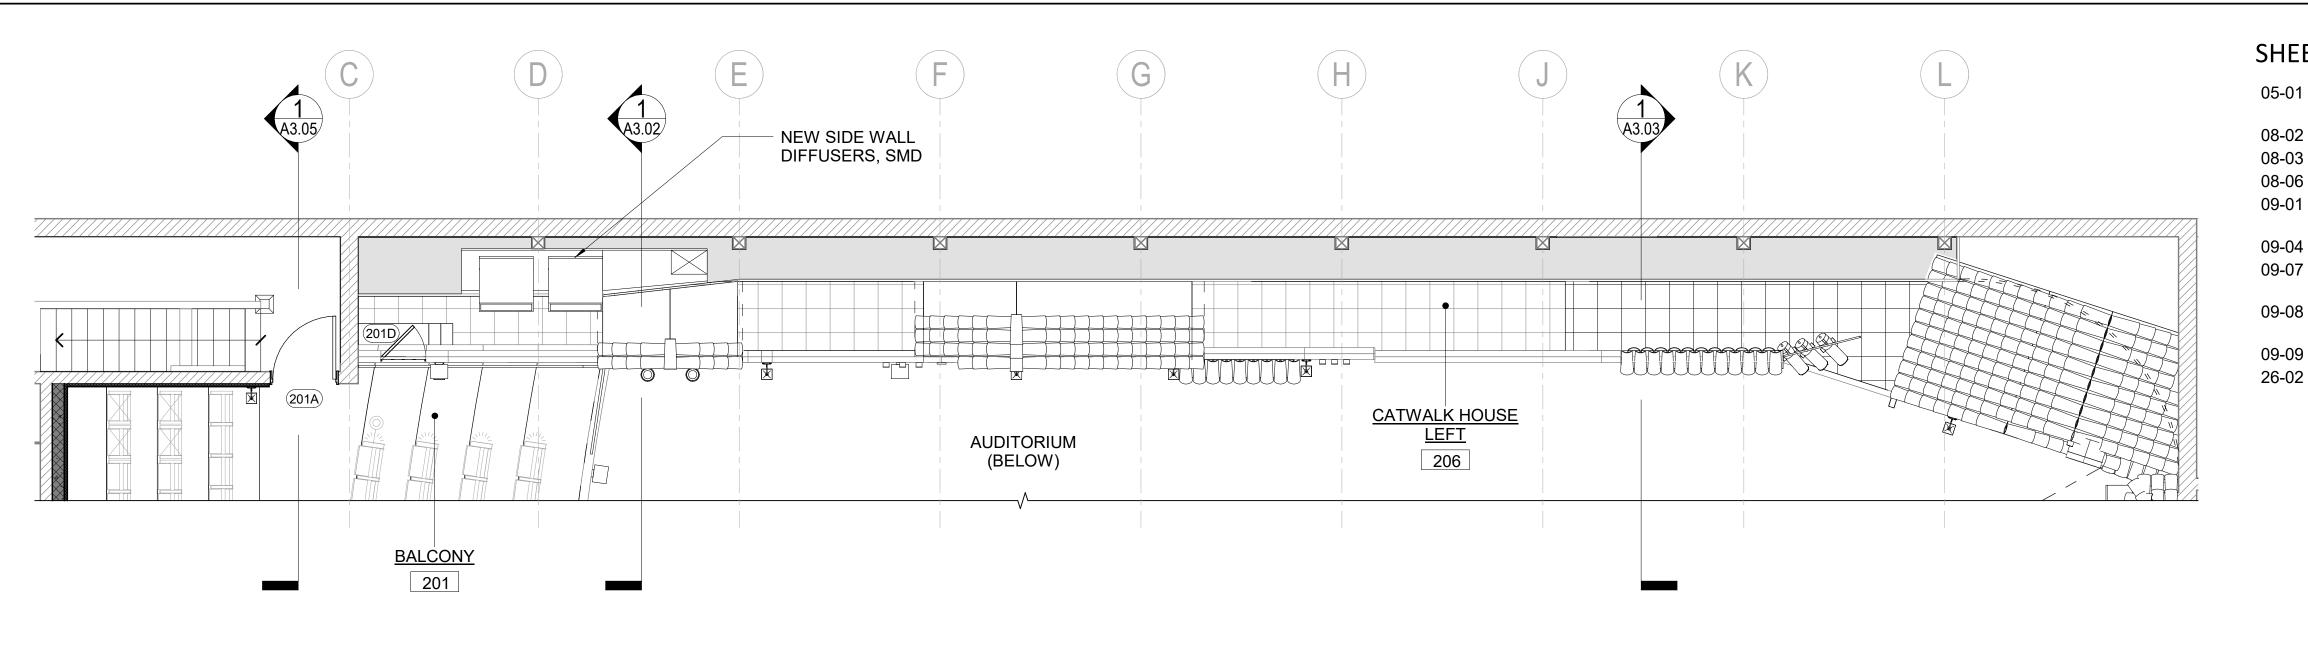REPAIR AND REPAINT (E) METALWORK (GRILLE, RAILING, ETC.)

REPAIR HOLLOW METAL DOOR 08-03 REPAIR WOOD DOOR

08-06 **REPAIR WOOD WINDOW** 09-01 CLEAN, PREPARE AND REPAINT

SURFACES CLEAN TILE AND GROUT SURFACES


CLEAN AND TOUCH-UP DECORATIVE

CLEAN INTERIOR DECORATIVE ROOF 09-08

NEW DECORATIVE ROOF TILE 09-09

26-02 **NEW LIGHT FIXTURE** 

### 2 HOUSE RIGHT CATWALK ROOF PLAN A5.01 3/16" = 1'-0"

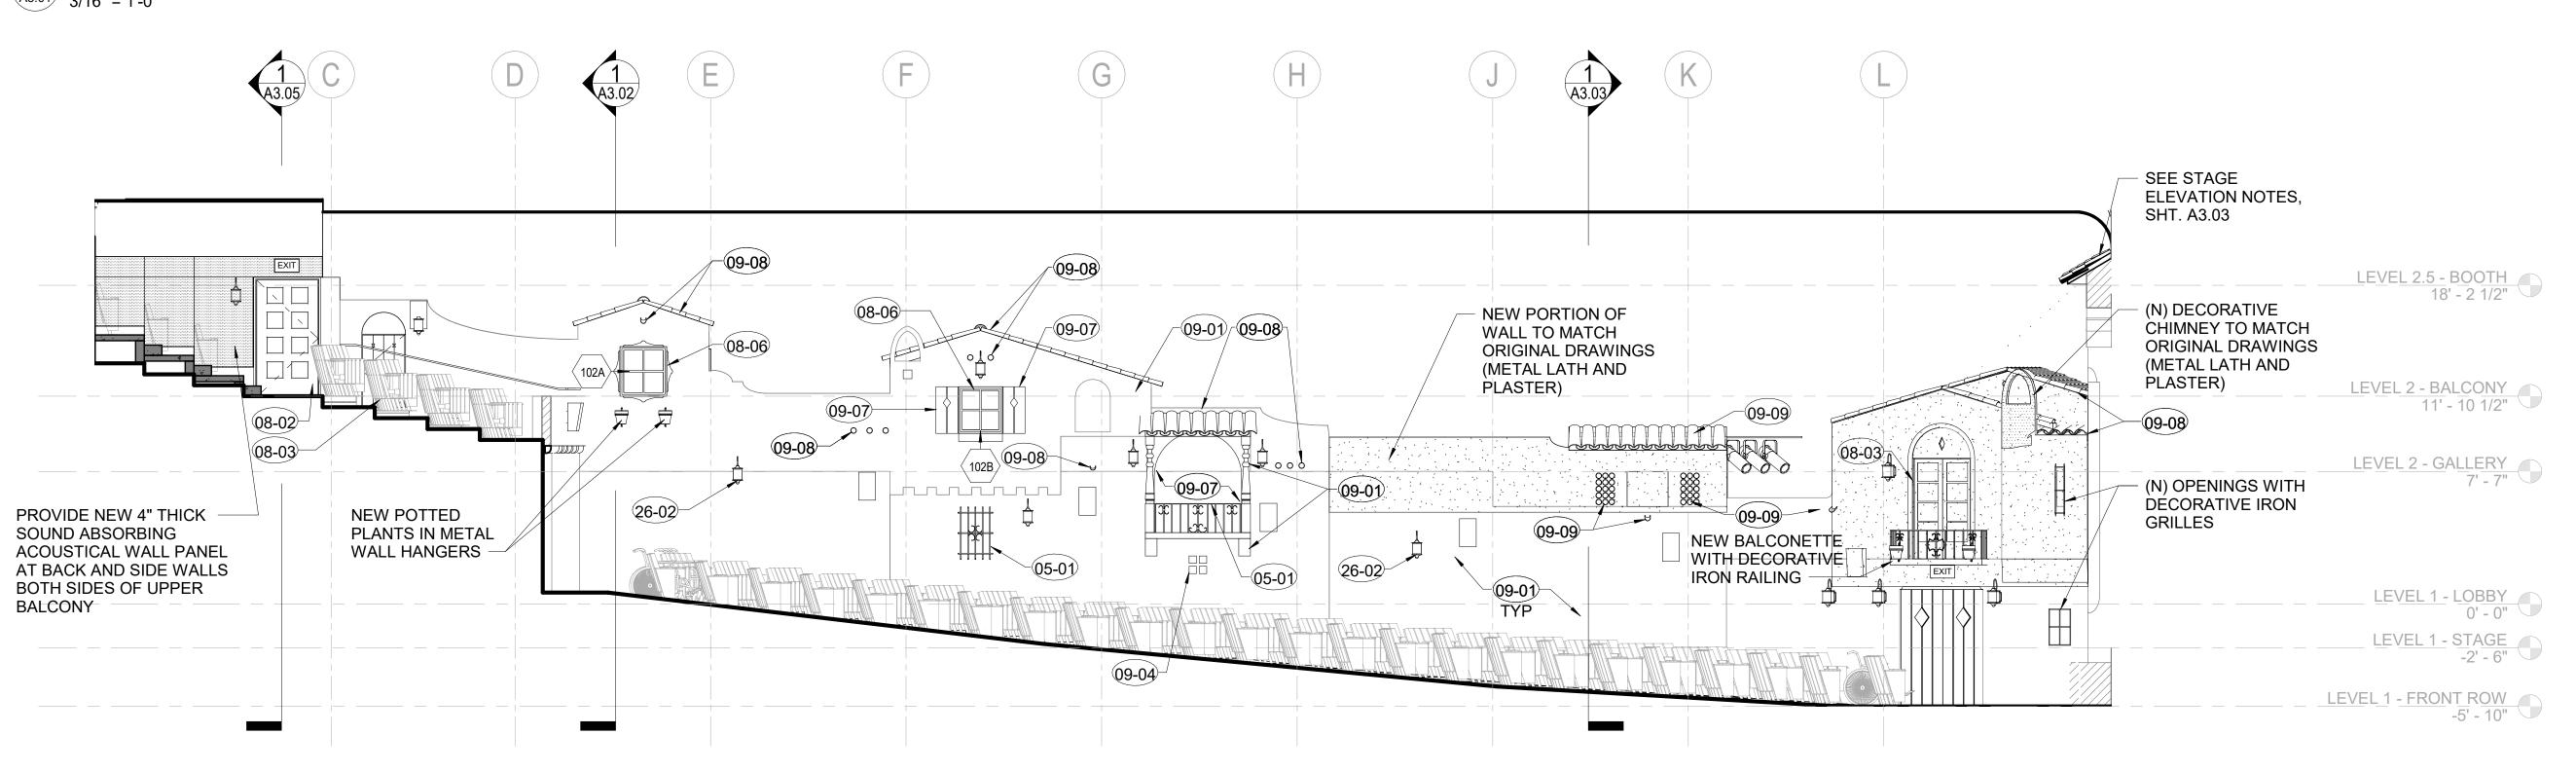

## INTERIOR ELEVATION GENERAL NOTES

### **INTERIOR PLASTER:**

A5.01 3/16" = 1'-0"

- 1. VACUUM CLEAN AND PREPARE SURFACES FOR REPAINTING.
- 2. REMOVE OBSOLETE OR ABANDONED FASTENERS, WIRING, NAILS, ETC. AND PATCH HOLES

INTERIOR ELEVATION - AUDITORIUM - NORTH

- 3. ROUT OUT AND FILL CRACKS WHERE NOTED AND ANY OTHER CRACKS AT FACADES THAT ARE 1/8-INCH OR WIDER. FILL AS SPECIFIED WITH A COMPATIBLE CEMENTITIOUS REPAIR MORTAR AND FINISH FLUSH WITH SURROUNDING SURFACES
- 4. CHIP AWAY AND REMOVE LOOSE OR UNSOUND MATERIAL TO SOUND SUBSTRATES & PREPARE FOR PATCHING.
- 5. IF (E) EMBEDDED REINFORCEMENT IS EXPOSED, PREPARE SURFACES & TREAT REBAR W/ A CORROSION INHIBITOR PRIOR TO PATCHING.
- 6. PATCH LOSS AREAS AS SPECIFIED W/ A COMPATIBLE REPAIR MORTAR. FORM & FINISH PATCHES TO MATCH SURROUNDING SURFACES.
- 7. REPAINT PLASTER SURFACES AS SPECIFIED.

### INTERIOR/EXTERIOR QUARRY TILE FLOORS:

- CLEAN TILE AND GROUT SURFACES AS SPECIFIED.
- 2. SAWCUT AND REPLACE GROUT JOINTS WHERE DETERIORATED OR MISSING.
- 3. REPLACE CRACKED, BROKEN OR OTHERWISE DAMAGED TILE W/NEW TO MATCH.

### **INTERIOR WOOD DOORS:**

- 1. EXISTING DOOR SIZES SHOWN ARE NOMINAL. FIELD VERIFY ACTUAL SIZE.
- 2. CONTRACTOR TO ENSURE PROPER WORKING ORDER AND WEATHERTIGHTNESS.
- 3. CLEAN AND PREPARE SURFACES FOR REPAINTING. 4. REMOVE ALL NAILS, FASTENERS, AND EXTRANEOUS OR OBSOLETE HARDWARE. FILL ALL HOLES IN ASSEMBLY AS REQUIRED PRIOR TO APPLICATION OF FINISH.
- 5. REMOVE AREAS OF WOOD DECAY AND TREAT WITH A WOOD CONSULTANT. FILL ANY VOIDS, HOLES, CRACKS OR GAPS WITH AN EPOXY PASTE, AND FINISH TO MATCH SURROUNDING SURFACES.

### INTERIOR WOOD DOORS (CONT):

- 6. REPLACE BROKEN OR DAMAGED GLASS WHERE NOTED... 7. REMOVE CRACKED, LOOSE OR DE-BONDED GLAZING PUTTY AND INFILL WITH NEW PUTTY; MATCH EXISTING PROFILE.
- 8. REPAINT WOOD SURFACES AS SPECIFIED.
- 9. CLEAN AND LUBRICATE (E) HARDWARE.
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- 11. INSTALL (N) ACOUSTICAL GASKETS.

### **INTERIOR HOLLOW METAL DOORS:**

- 1. EXISTING DOOR SIZES SHOWN ARE NOMINAL. FIELD VERIFY ACTUAL SIZE.
- 3. CLEAN AND PREPARE SURFACES FOR REPAINTING. 4. TREAT AREAS OF CORROSION WITH A CORROSION INHIBITOR, AND PRIME.

2. CONTRACTOR TO ENSURE PROPER WORKING ORDER.

### **INTERIOR HOLLOW METAL DOORS (CONT):**

- 5. REPLACE BROKEN OR DAMAGED GLASS WHERE NOTED. 6. REMOVE CRACKED, LOOSE OR DE-BONDED GLAZING PUTTY AND INFILL WITH NEW PUTTY; MATCH EXISTING PROFILE.
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# INTERIOR ELEVATION LEGEND

3/16" = 1'-0"

**EXISTING CONSTRUCTION** TO REMAIN

NEW CONSTRUCTION

ACOUSTICAL WALL PANELS

Architectural Resources Group 360 E. 2nd Street, Suite 225

Los Angeles, California 90012

626.583.1401

argcreate.com

DATE **DESCRIPTION REVISIONS** 

# **PLAZA** THEATRE

### **REHABILITATION**

128 S Palm Canyon Dr. Palm Springs, CA 92262

SHEET TITLE

### **INTERIOR ELEVATIONS**

**ISSUANCE** 

**HSPB SUBMITTAL** 

01/27/23


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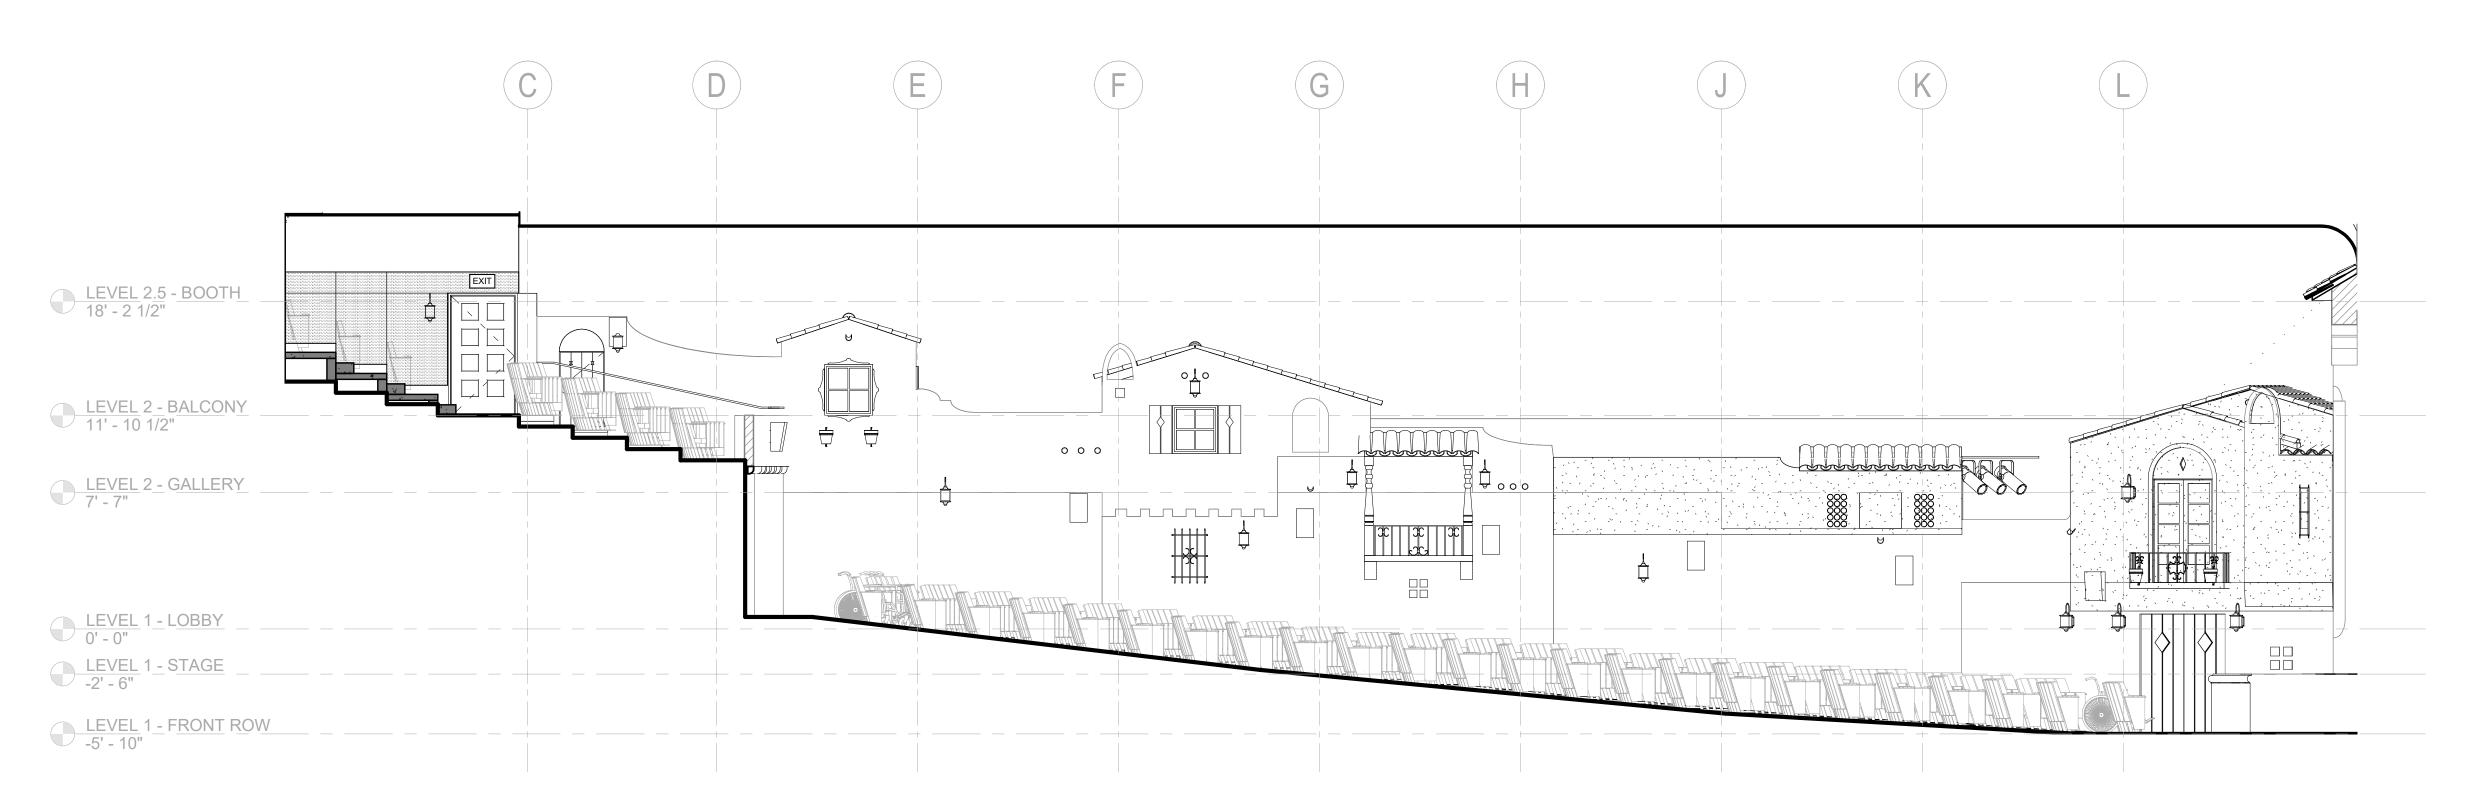
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DRAWING NO.



EXISTING ATMOPSPHERIC SIDEWALL CONDITION PHOTO WITH NON-ORIGINAL, AND MISSING ORIGINAL ELEMENTS HIGHLIGHTED



PROPOSED ATMOPSPHERIC SIDEWALL REHABILITATED TO ORIGINAL CONDITION

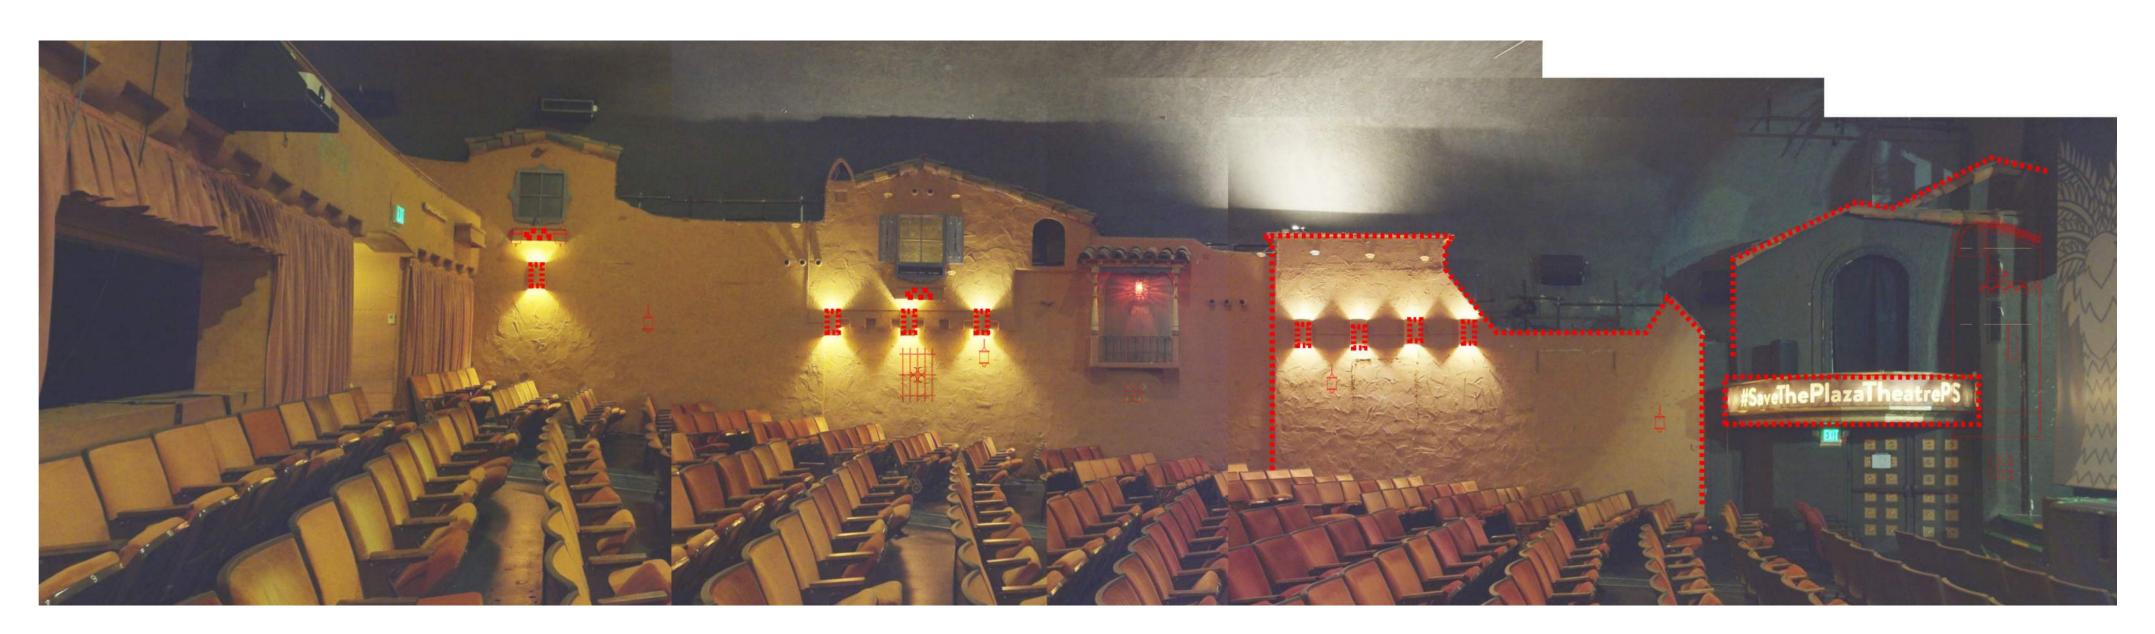

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DESCRIPTION

**REVISIONS** 

DATE

# PLAZA THEATRE

REHABILITATION

128 S Palm Canyon Dr, Palm Springs, CA 92262

SHEET TITLE

INTERIOR COMPARISON

**ISSUANCE** 

**HSPB SUBMITTAL** 

01/27/23

PROJ. NO. 220602

DRAWN Author


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1 INTERIOR ELEVATION - AUDITORIUM - NORTH

A5.01-A 3/16" = 1'-0"

3/16" = 1'-0"



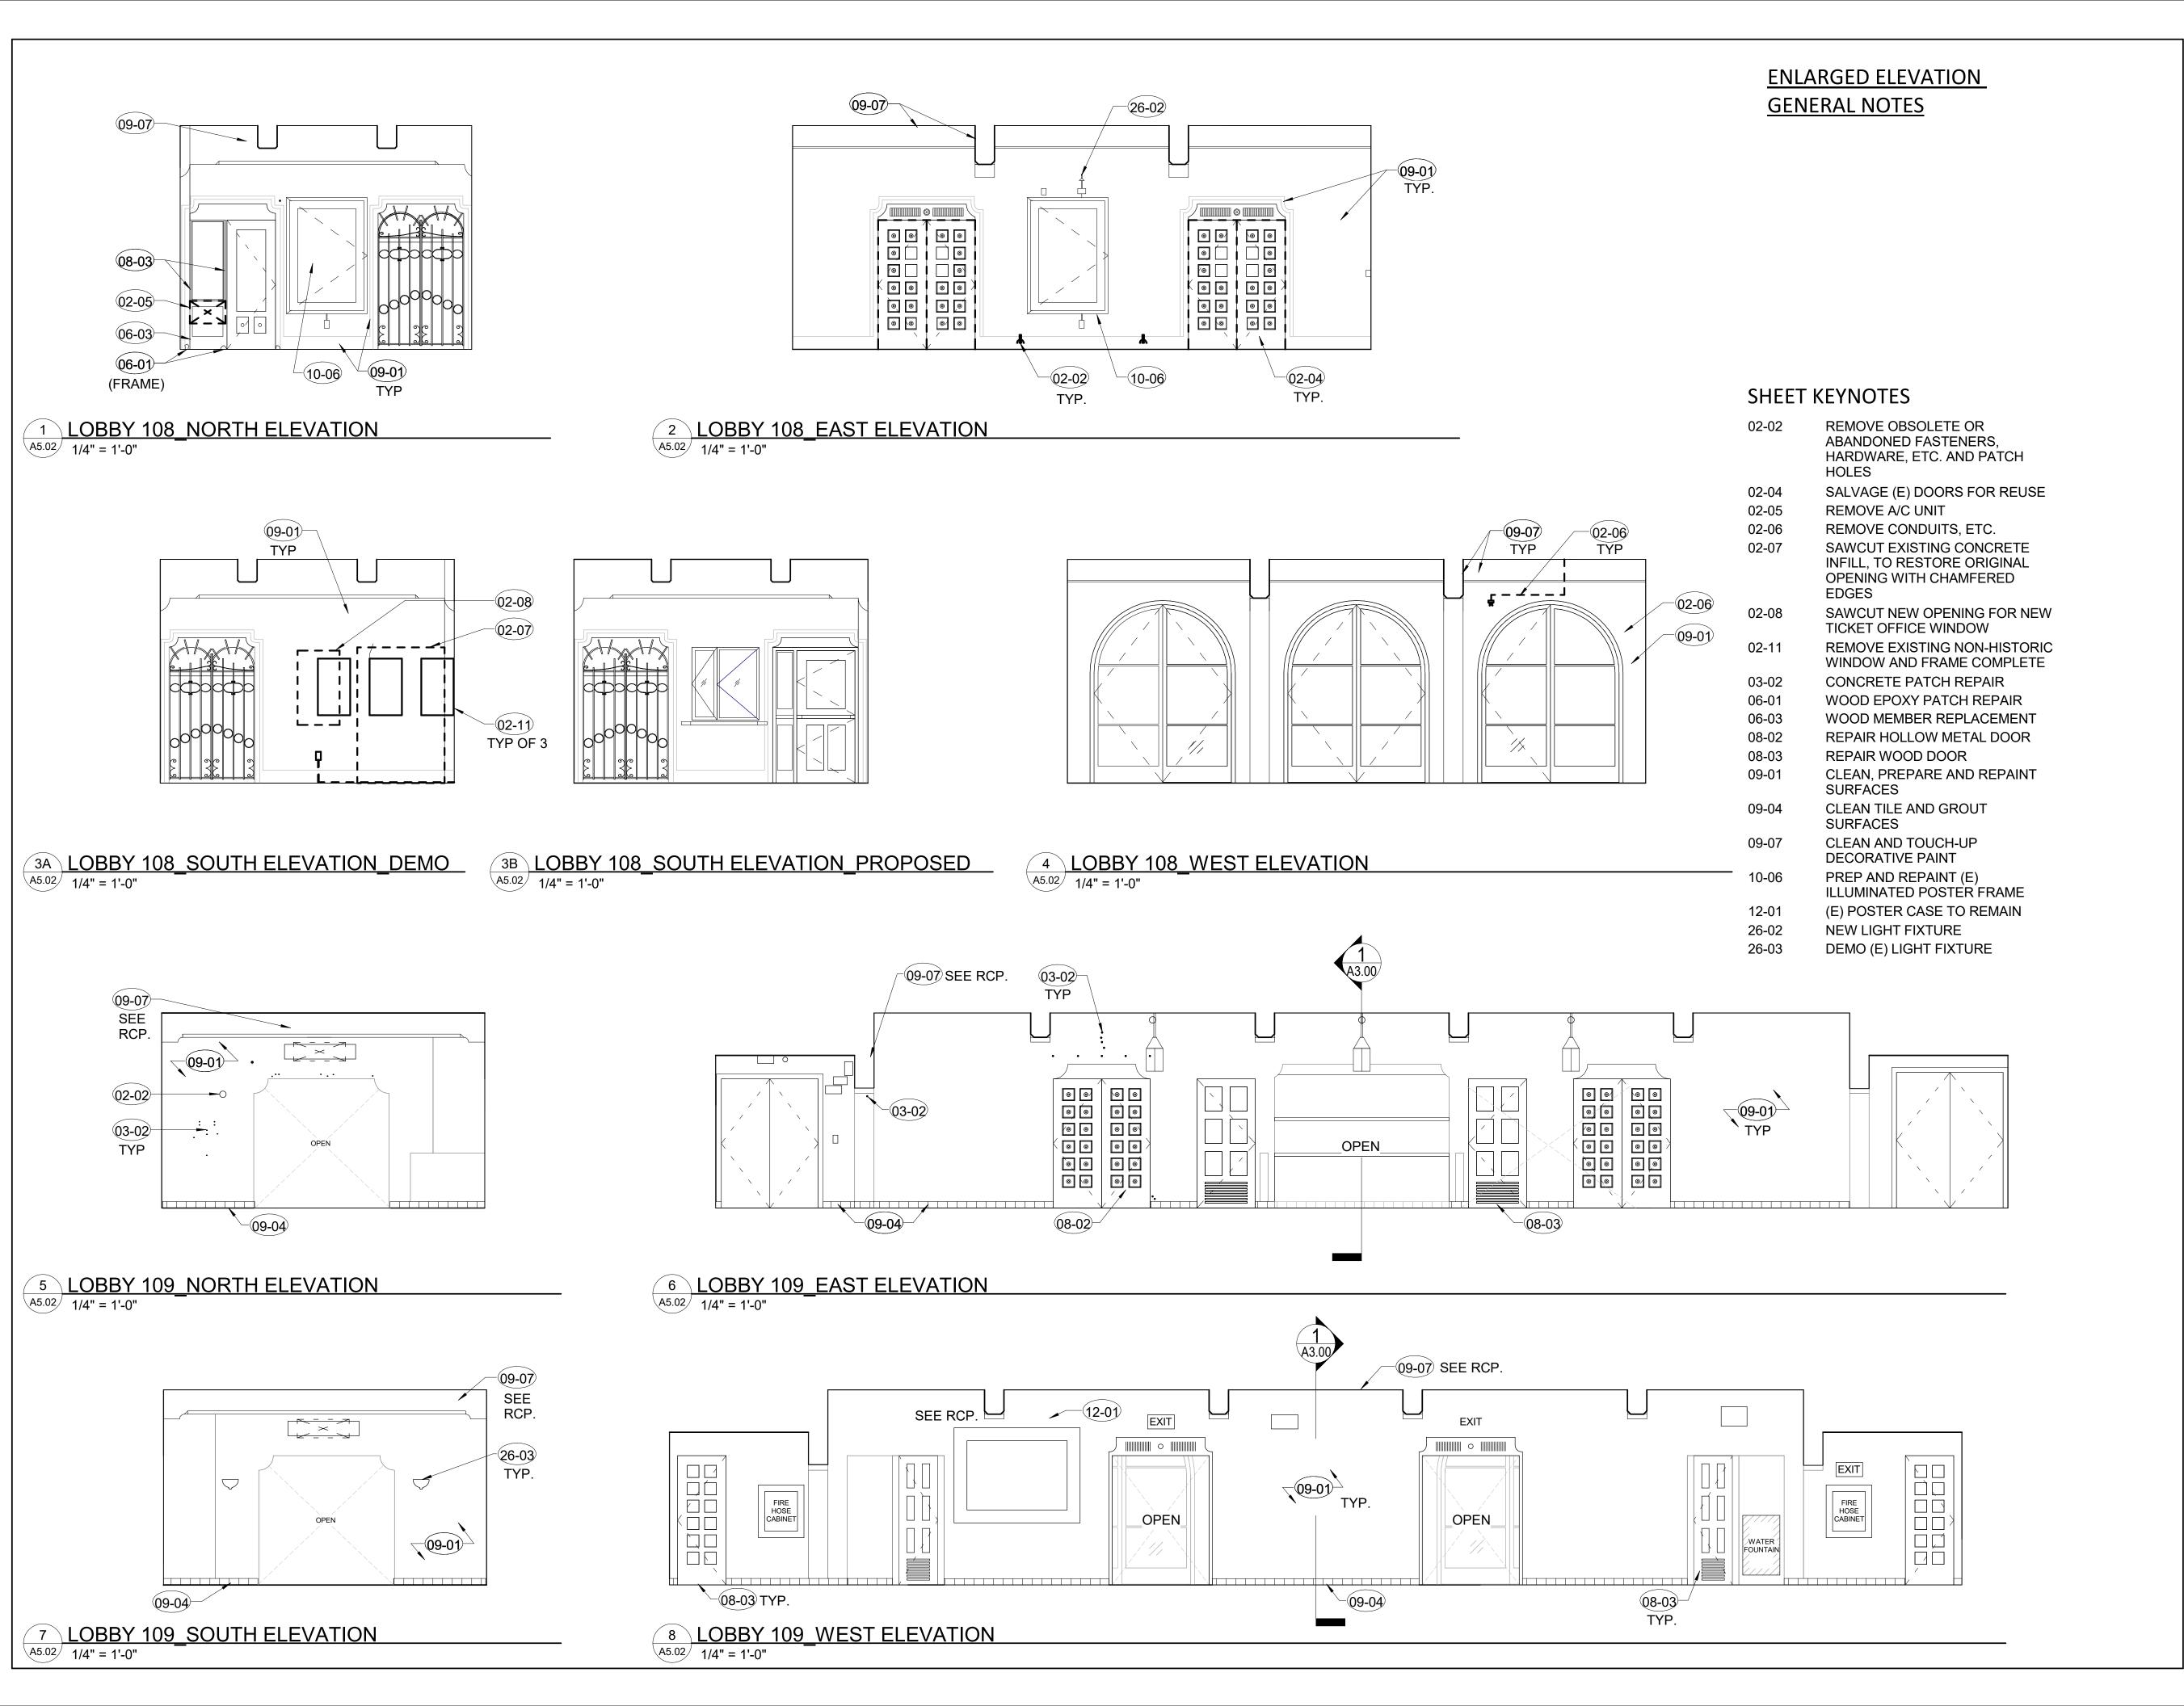

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DATE

REVISIONS

# PLAZA THEATRE

### REHABILITATION

128 S Palm Canyon Dr, Palm Springs, CA 92262

SHEET TITLE

# ENTRY PORTICO ELEVATIONS

ISSUANCE

HSPB SUBMITTAL

# 01/27/23

PROJ. NO. 220602

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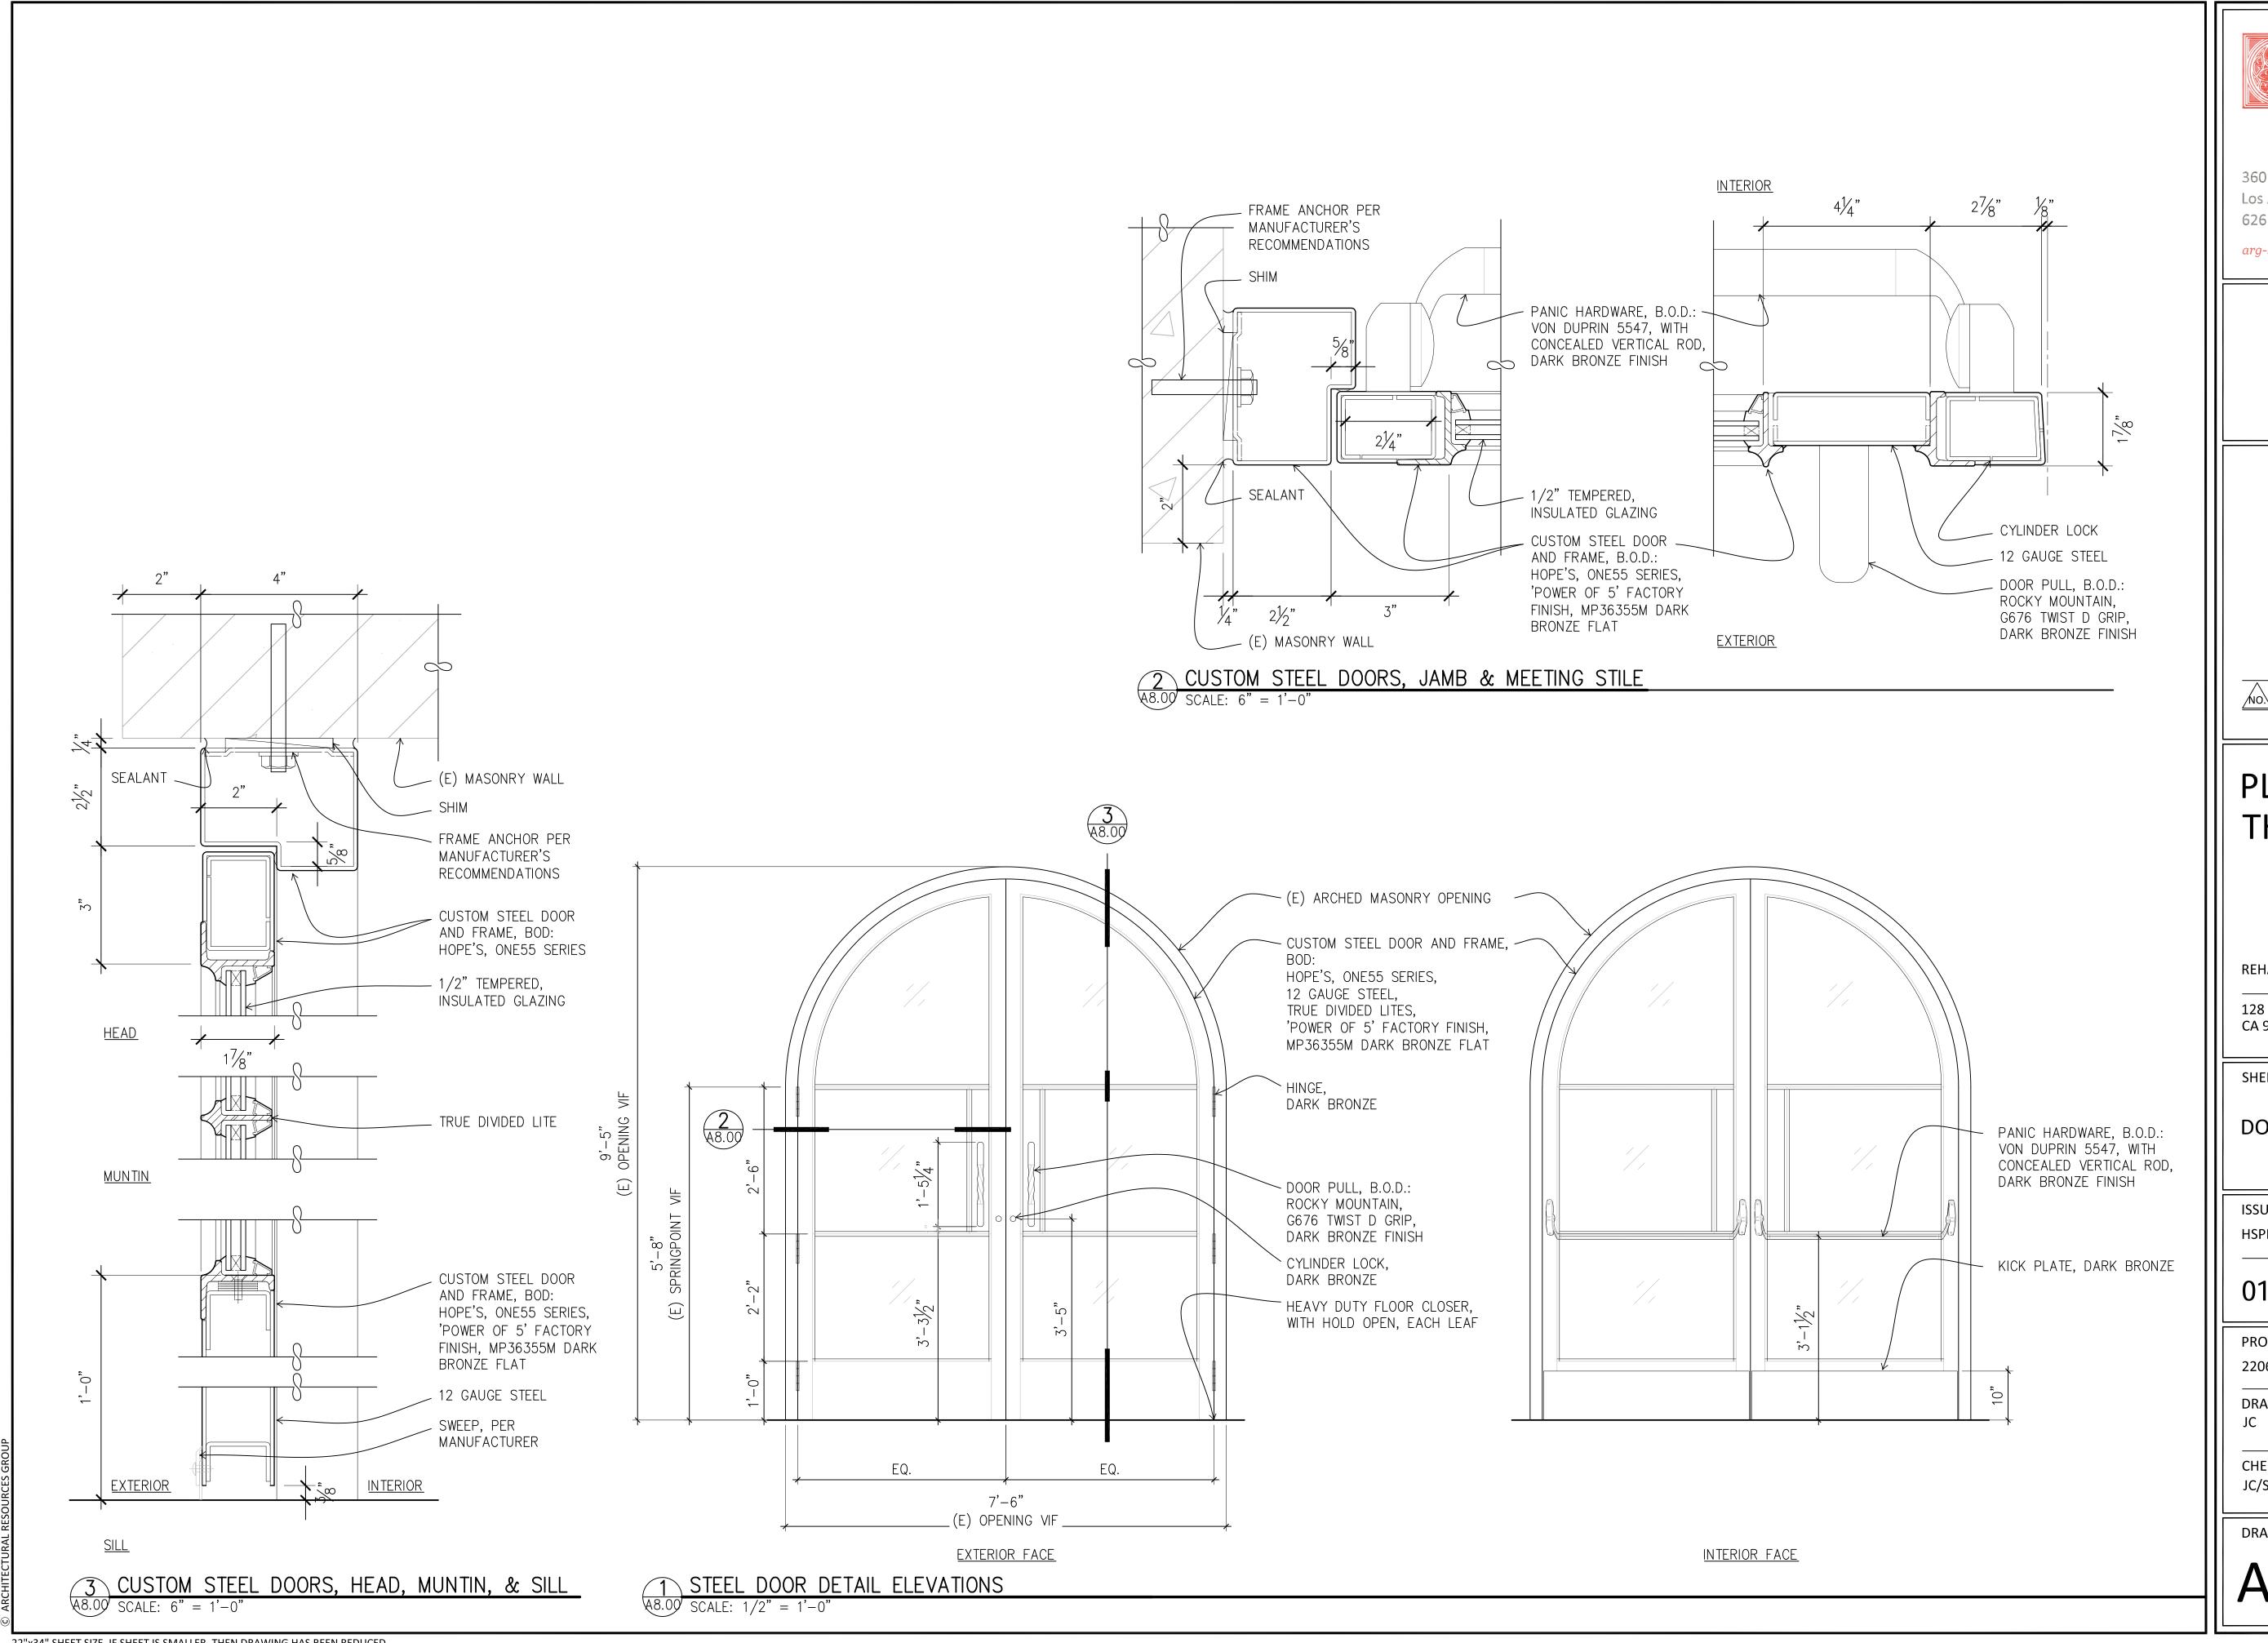
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A5.02





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DESCRIPTION **REVISIONS** 

DATE

# **PLAZA THEATRE**

REHABILITATION

128 S Palm Canyon Dr, Palm Springs, CA 92262

SHEET TITLE

DOOR DETAILS

**ISSUANCE** 

HSPB SUBMITTAL

01/27/23

PROJ NO.


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DRAWING NO.

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NO. DESCRIPTION

REVISIONS

DATE

# PLAZA THEATRE

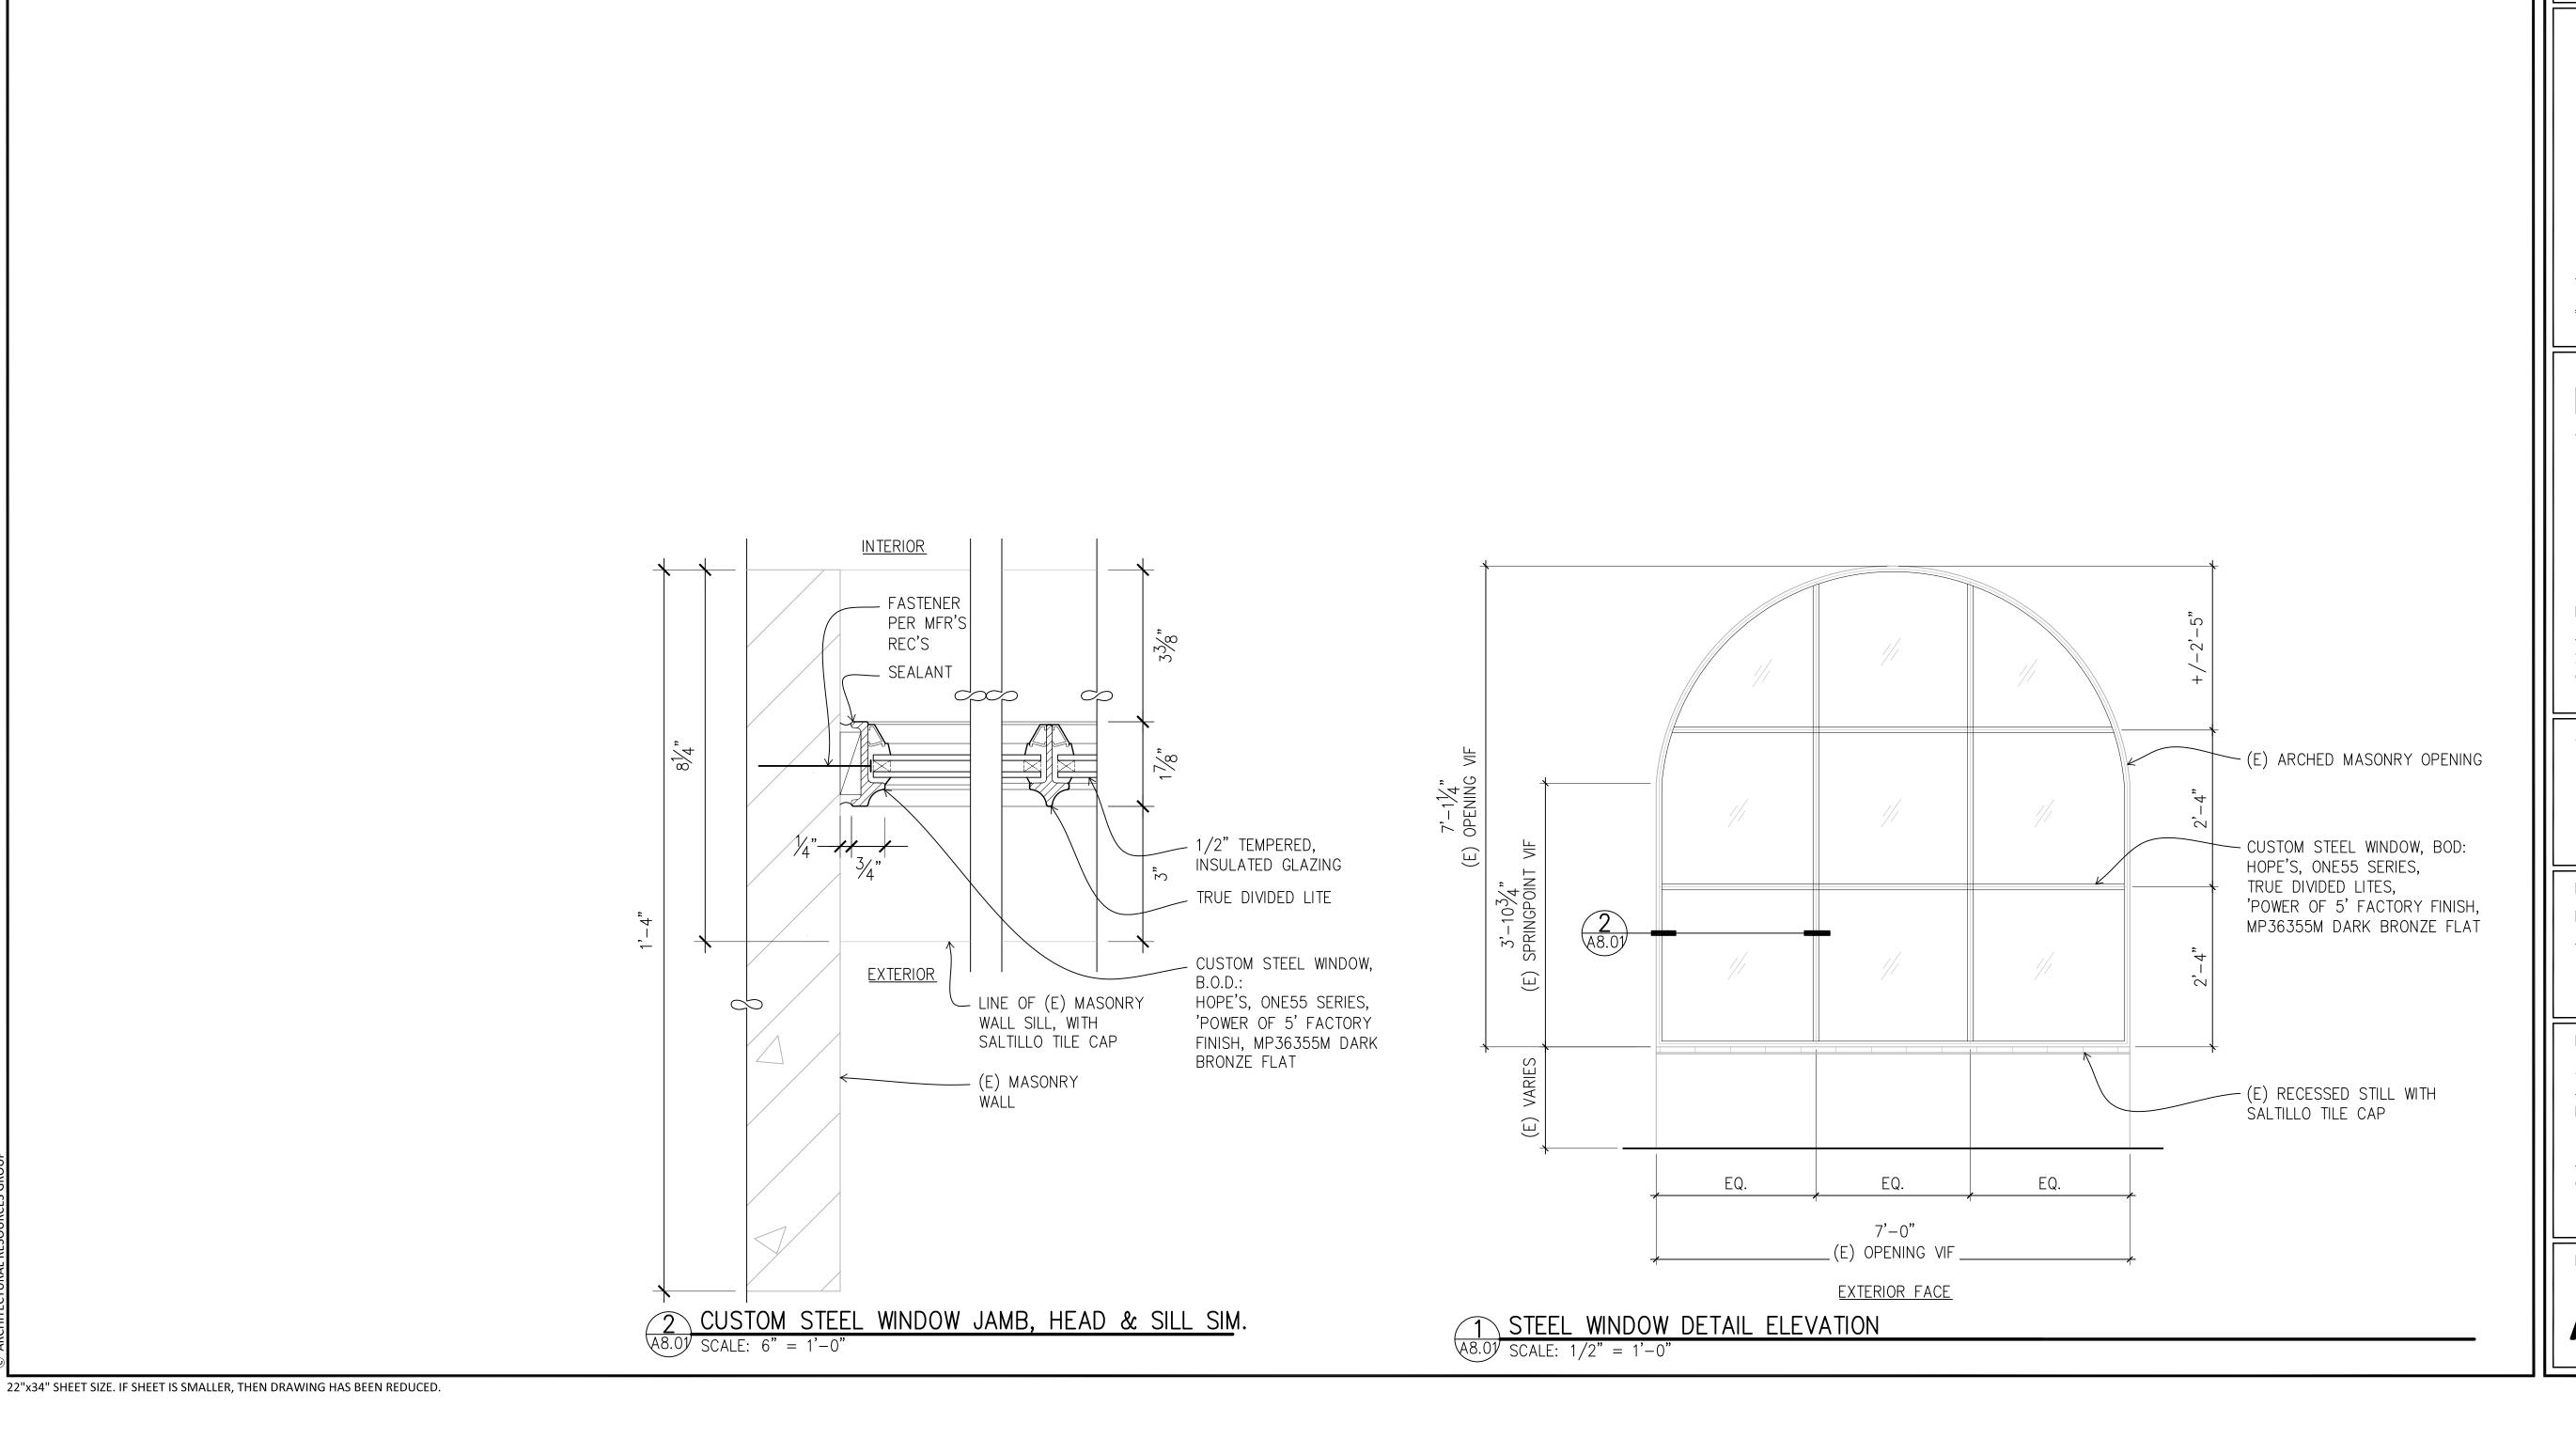REHABILITATION

128 S Palm Canyon Dr, Palm Springs, CA 92262

SHEET TITLE

## WINDOW DETAILS

ISSUANCE

HSPB SUBMITTAL

# 01/27/23

PROJ NO.

220602

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DRAWING NO.

A8.01



Mondel 1711-16-14-94 by Drotte # 240997

#### RESOLUTION NO. 17678

OF THE CITY COUNCIL OF THE CITY OF PALM SPRINGS, CALIFORNIA, DESIGNATING THE PLAZA THEATRE AS A CLASS 1 HISTORIC SITE.



WHEREAS the Plaza Theatre and its associated personages have contributed substantially to the history of the City of Palm Springs; and

WHEREAS the Plaza Theatre, and its sign, has long been a landmark for both residents and visitors in the City of Palm Springs; and

WHEREAS the Plaza Theatre has been sensitively rehabilitated and now serves as the home of the Palm Springs International Film Festival; and

WHEREAS Chapter 8.05 of the Palm Springs Municipal Code allows for the designation of historic sites; and

WHEREAS on February 13, 1991, the Historic Site Preservation Board held a public hearing regarding the designation of the Plaza Theatre as an historic site and unanimously recommended to the City Council designation of said property as a Class 1 Historic Site; and

WHEREAS the City Council concurs in the recommendation of the Historic Site Preservation Board regarding the historic value of the Plaza Theatre; and

WHEREAS the designation of the Plaza Theatre shall further the purposes and intent of Chapter 8.05, and the Conservation Element of the General Plan; and

WHEREAS the designation of the Plaza Theatre shall promote the sensitive preservation and restoration of said site, as well as the historic "Village" atmosphere of the Downtown.

NOW THEREFORE BE IT RESOLVED by the City Council of the City of Palm Springs, California, as follows:

- SECTION 1. The Plaza Theatre, as shown on Exhibit A, located at 120 S. Palm Canyon Drive, shall be designated a Class 1 Historic Site pursuant to Chapter 8.05 of the Palm Springs Municipal Code. The site is located on a portion of Block 27 of the subdivision of Palm Springs as recorded at Page 432 of Map Book 9, Riverside County, California; APN 513-144-003.
- SECTION 2. No exterior alteration to the Plaza Theatre, or its signs, shall be made without the prior approval of the Historic Site Preservation Board; approved alterations shall tend to maintaining the historic integrity of the site. A plaque demarking the Plaza Theatre as an historic site shall be installed by the City.

HSPB.

SECTION 3.

The current plans to remodel the property and structure commonly known as "Karen's Korner" and to enclose the south arcade have been reviewed by the Historic Site Preservation Board and have been found to be consistent that the intent and purposes of Chapter 8.05 of the Municipal Code and the Conservation Element of the General Plan.

ADOPTED this 6th day of November , 1991.

AYES:

Councilmembers Broich, Hodges, Murawski, Neel and Mayor Bono

NOES: None ABSENT: None

ATTEST:

CITY OF PALM SPRINGS CALIFORNIA

City Manager

REVIEWED & APPROVED:

City Clerk